


# PARCEL "M" DEVELOPMENT PLANS FOR PARCEL "M" DEVELOPMEN

MAP 99, LOT 1 & MAP 99, LOT 6 HAYES MEMORIAL DRIVE

## MARLBOROUGH, MA

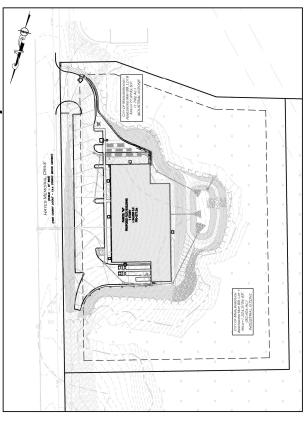

ALLEN & MAJOR ASSOCIATES, INC. 100 COMMERCE WAY, SUITE 5 WOBURN, MA 01801 781.935.6889

ENVIRONMENTAL CONSULTANT:

GODDARD CONSULTING, LLC 291 MAIN STREETM, SUITE 8 NORTHBOROUGH, MA 01532 508.393.3784

LAND SURVEYOR, SITE ENGINEER LANDSCAPE ARCHITECT:

THE GUTIERREZ COMPANY 200 SUMMIT DRIVE, SUITE 400 BURLINGTON, MA 01803 781.272.7000

APPLICANT:




LIST OF D	LIST OF DRAWINGS		
DRAWING TITLE	SHEET NO.	ISSUED	REVISED
CIVIL DRAWINGS			
EXISTING CONDITIONS KEY SHEET	V-101	06-05-2020	
EXISTING CONDITIONS	V-104	06-05-2020	
EXISTING CONDITIONS	V-105	06-05-2020	
ABBREVIATIONS AND NOTES	9	06-05-2020	
ABBREVIATIONS AND NOTES	8 0 0	06-05-2020	
LOCUS PLAN	8	06-05-2020	
EROSION CONTROL PLAN	2	06-05-2020	
LAYOUT & MATERIALS PLAN	2 8 8	06-05-2020	
GRADING & DRAINAGE PLAN	9 8	06-05-2020	
UTILITIES PLAN	\$ 5	06-05-2020	
FIRE TRUCK TURNING PLAN	ن 8	06-05-2020	
TRUCK TURNING PLAN	ر 8	06-05-2020	
PHOTOMETRICS PLAN	ر د ۱۵	06-05-2020	
SNOW STORAGE PLAN	90 J	06-05-2020	
CIVIL DETAILS	550	06-05-2020	
CML DETALS	C-502	06-05-2020	
CIVIL DETAILS	C-58	06-05-2020	
CIVIL DETAILS	C-504	06-05-2020	
CIVIL DETAILS	C-508	06-05-2020	
CIVIL DETAILS	2506	06-05-2020	
LANDSCAPE DRAWINGS			
LANDSCAPE PLAN	<u></u>	06-05-2020	
LANDSCAPE DETAILS	L102	06-05-2020	
ARCHITECTURAL DRAWINGS			
CONCEPTIAL RENDERING	ı	04.05.2020	






SUBMITTED FOR CONSERVATION COMMISSION: JUNE 5, 2020

BEFORE YOU DIG CALL 811 OR 1-888-DIG-SAFE 1-888-344-7233

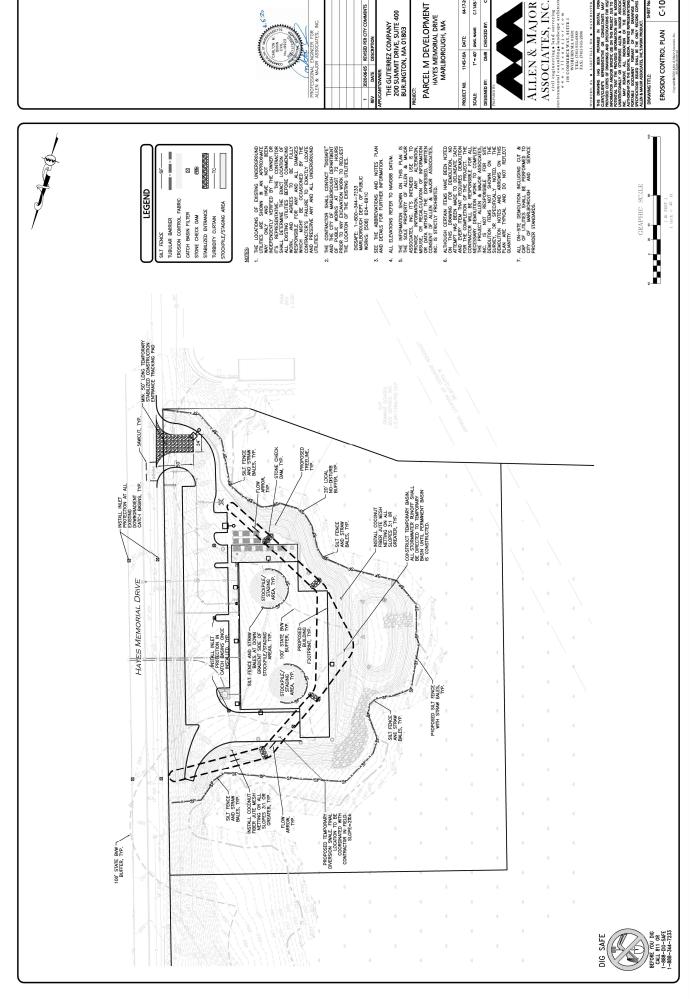

C-101

C-1145-10A

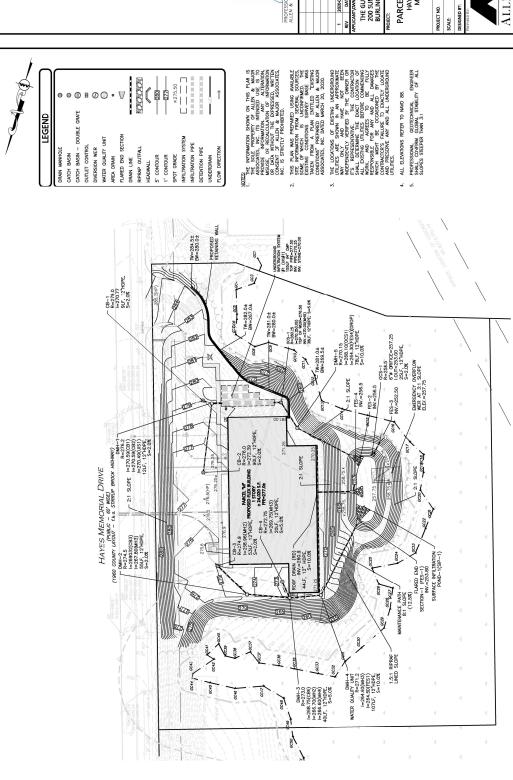




04-17-2020 C-1145-10A

1145-10A DATE:

PARCEL M DEVELOPMENT HAYES MEMORIAL DRIVE MARLBOROUGH, MA

THE GUTIERREZ COMPANY 200 SUMMIT DRIVE, SUITE 400 BURLINGTON, MA 01803

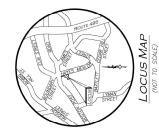

### APPLICANT/OWNER:

THE GUTIERREZ COMPANY 200 SUMMIT DRIVE, SUITE 400 BURLINGTON, MA 01803 781.272.7000

## LAND SURVEYOR, SITE ENGINEER LANDSCAPE ARCHITECT:

ALLEN & MAJOR ASSOCIATES, INC. 100 COMMNERCE WAY, SUITE 5 WOBURN, MA 01801 TEL: 781:935.6889 FAX: 781:935.2896


### ENVIRONMENTAL CONSULTANT:

GODDARD CONSULTING, LLC 291 MAIN STREET, SUITE 8 NORTHBOROUGH, MA 01532 508.393.3784


## SITE DEVELOPMENT PLANS FOR

# PARCEL "K" DEVELOPMENT MAP 88, LOT 35, HAYES MEMORIAL DRIVE

## MARLBOROUGH, MA

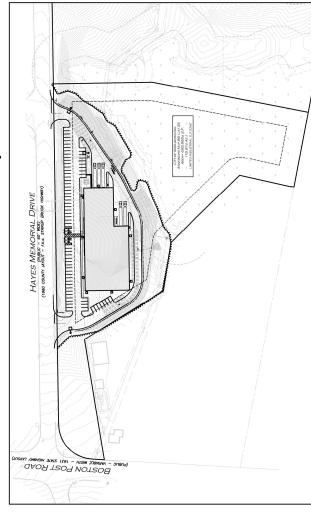

CIVIL DRAWING TITLE   SHEET NO. ISSUED REVISED	LIST OF D	LIST OF DRAWINGS		
No.	DRAWING TITLE	SHEET NO.	ISSUED	REVISED
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NOTES C.001 04-2200 NOTES C.002 04-2200 NOTES C.003 04-2200 C.003 04-2200 NOTES C.003 04-2200 NOTES C.004	EXISTING CONDITIONS	V-102	06-04-2020	
HOTES	ABBREVIATIONS AND NOTES	9	06-04-2020	
C-100   0-0-1200	ABBREVIATIONS AND NOTES	C-002	06-04-2020	
S PLAN C.	LOCUS PLAN	8 8	06-04-2020	
SPLAN C.IOZ 0404-2000 EPLAN C.IOS 0404-2000 C.	EROSION CONTROL PLAN	5	06-04-2020	
C	LAYOUT & MATERIALS PLAN	2017	06-04-2020	
CLICH 04-2000 SPLAN CLICK 04-42000 NA CLICK 04-42000 NA CLICK 04-42000 CLICK 04-4	GRADING & DRAINAGE PLAN	20.0	06-04-2020	
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C-501 64-0-200 C-502 C-503 C-503 C-503 C-503 C-504 C-504 C-504 C-504 C-505 C-5	SNOW STORAGE PLAN	90 J	06-04-2020	
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C.564 04-9200 C.565 04-9200 C.565 04-9200 C.567 04-9200 C.	CML DETAILS	C-503	06-04-2020	
C-565 04-04-2020 C-564 04-04-04-2020 C-564 04-04-04-04-04-04-04-04-04-04-04-04-04-0	CIVIL DETAILS	C-504	06-04-2020	
C-566 04-04-2020 C-567 04-04-04-2020 C-567 04-04-04-04-04-04-04-04-04-04-04-04-04-0	CML DETAILS	C-505	06-04-2020	
RAWINGS C-597 06-04-2020 L-101 04-04-2020 L-102 06-04-2020	CML DETAILS	C-506	06-04-2020	
RAWINGS L-101	CML DETAILS	C-507	06-04-2020	
L-101	LANDSCAPE DRAWINGS			
L-102	LANDSCAPE PLAN	<u>-</u>	06-04-2020	
	LANDSCAPE DETAILS	۲- 102	06-04-2020	

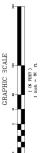








SUBMITTED FOR CONSERVATION COMMISSION: JUNE 4, 2020

DIG SAFE

SETOR YOU DG

CALL 811 OR


1-888-206-58FE

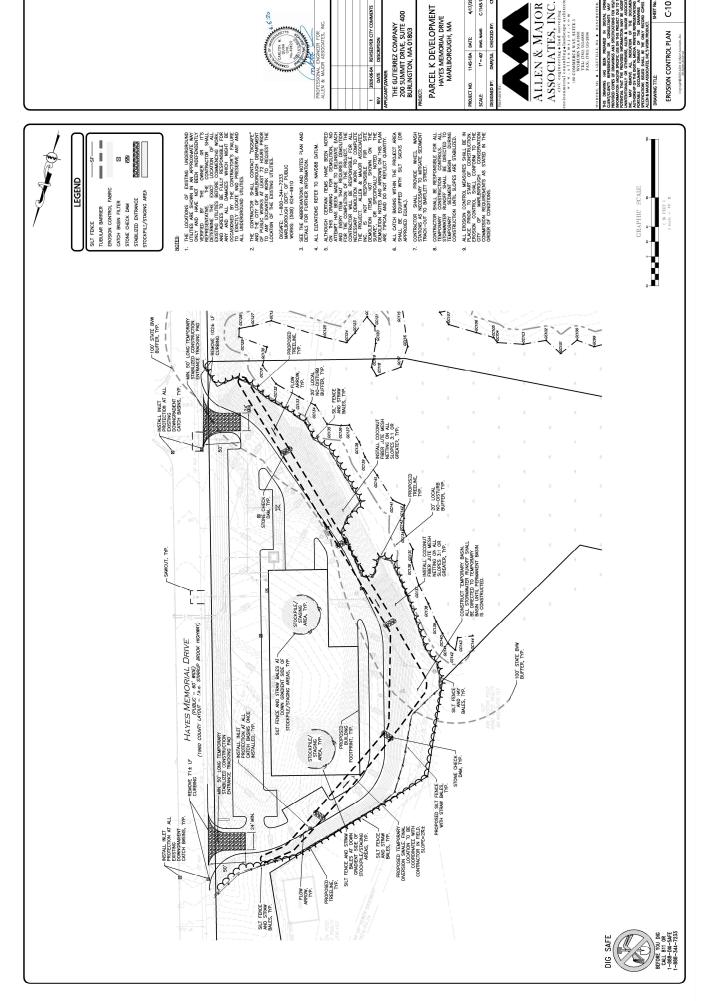


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THE GUTIERREZ COMPANY 200 SUMMIT DRIVE, SUITE 400 BURLINGTON, MA 01803 781.272.7000


## LAND SURVEYOR, SITE ENGINEER LANDSCAPE ARCHITECT:


ALLEN & MAJOR ASSOCIATES, INC. 100 COMMINERCE WAY, SUITE 5 WOBURN, MA 01801 TEL: 781.935.6889 FAX: 781.935.2896
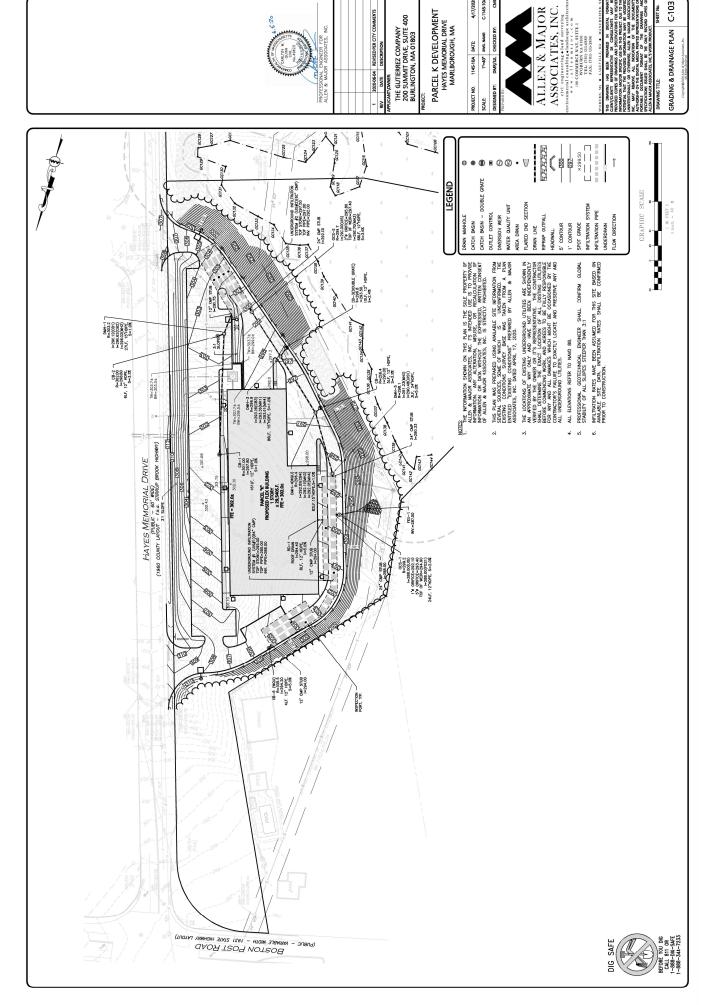
### ENVIRONMENTAL CONSULTANT:

GODDARD CONSULTING, LLC 291 MAIN STREET, SUITE 8 NORTHBOROUGH, MA 01532 508.393.3784

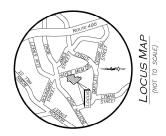
## MAP 88, LOT 35 & MAP 99, LOT 1 PARCEL "L" DEVELOPMEN SITE DEVELOPMENT PLANS FOR HAYES MEMORIAL DRIVE

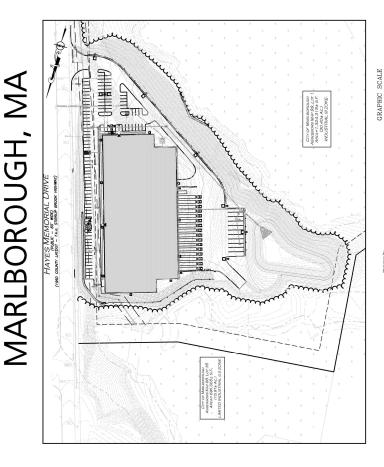

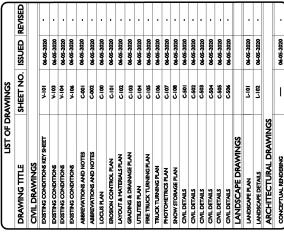





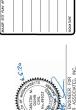




SUBMITTED FOR LOCAL APPROVAL: APRIL 17, 2020 ISSUED TO CONSERVATION COMMISSION: JUNE 5, 2020

ASSOCIATES, INC.
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BEFORE YOU DIG CALL 811 OR 1-888-DIG-SAFE 1-888-344-7233




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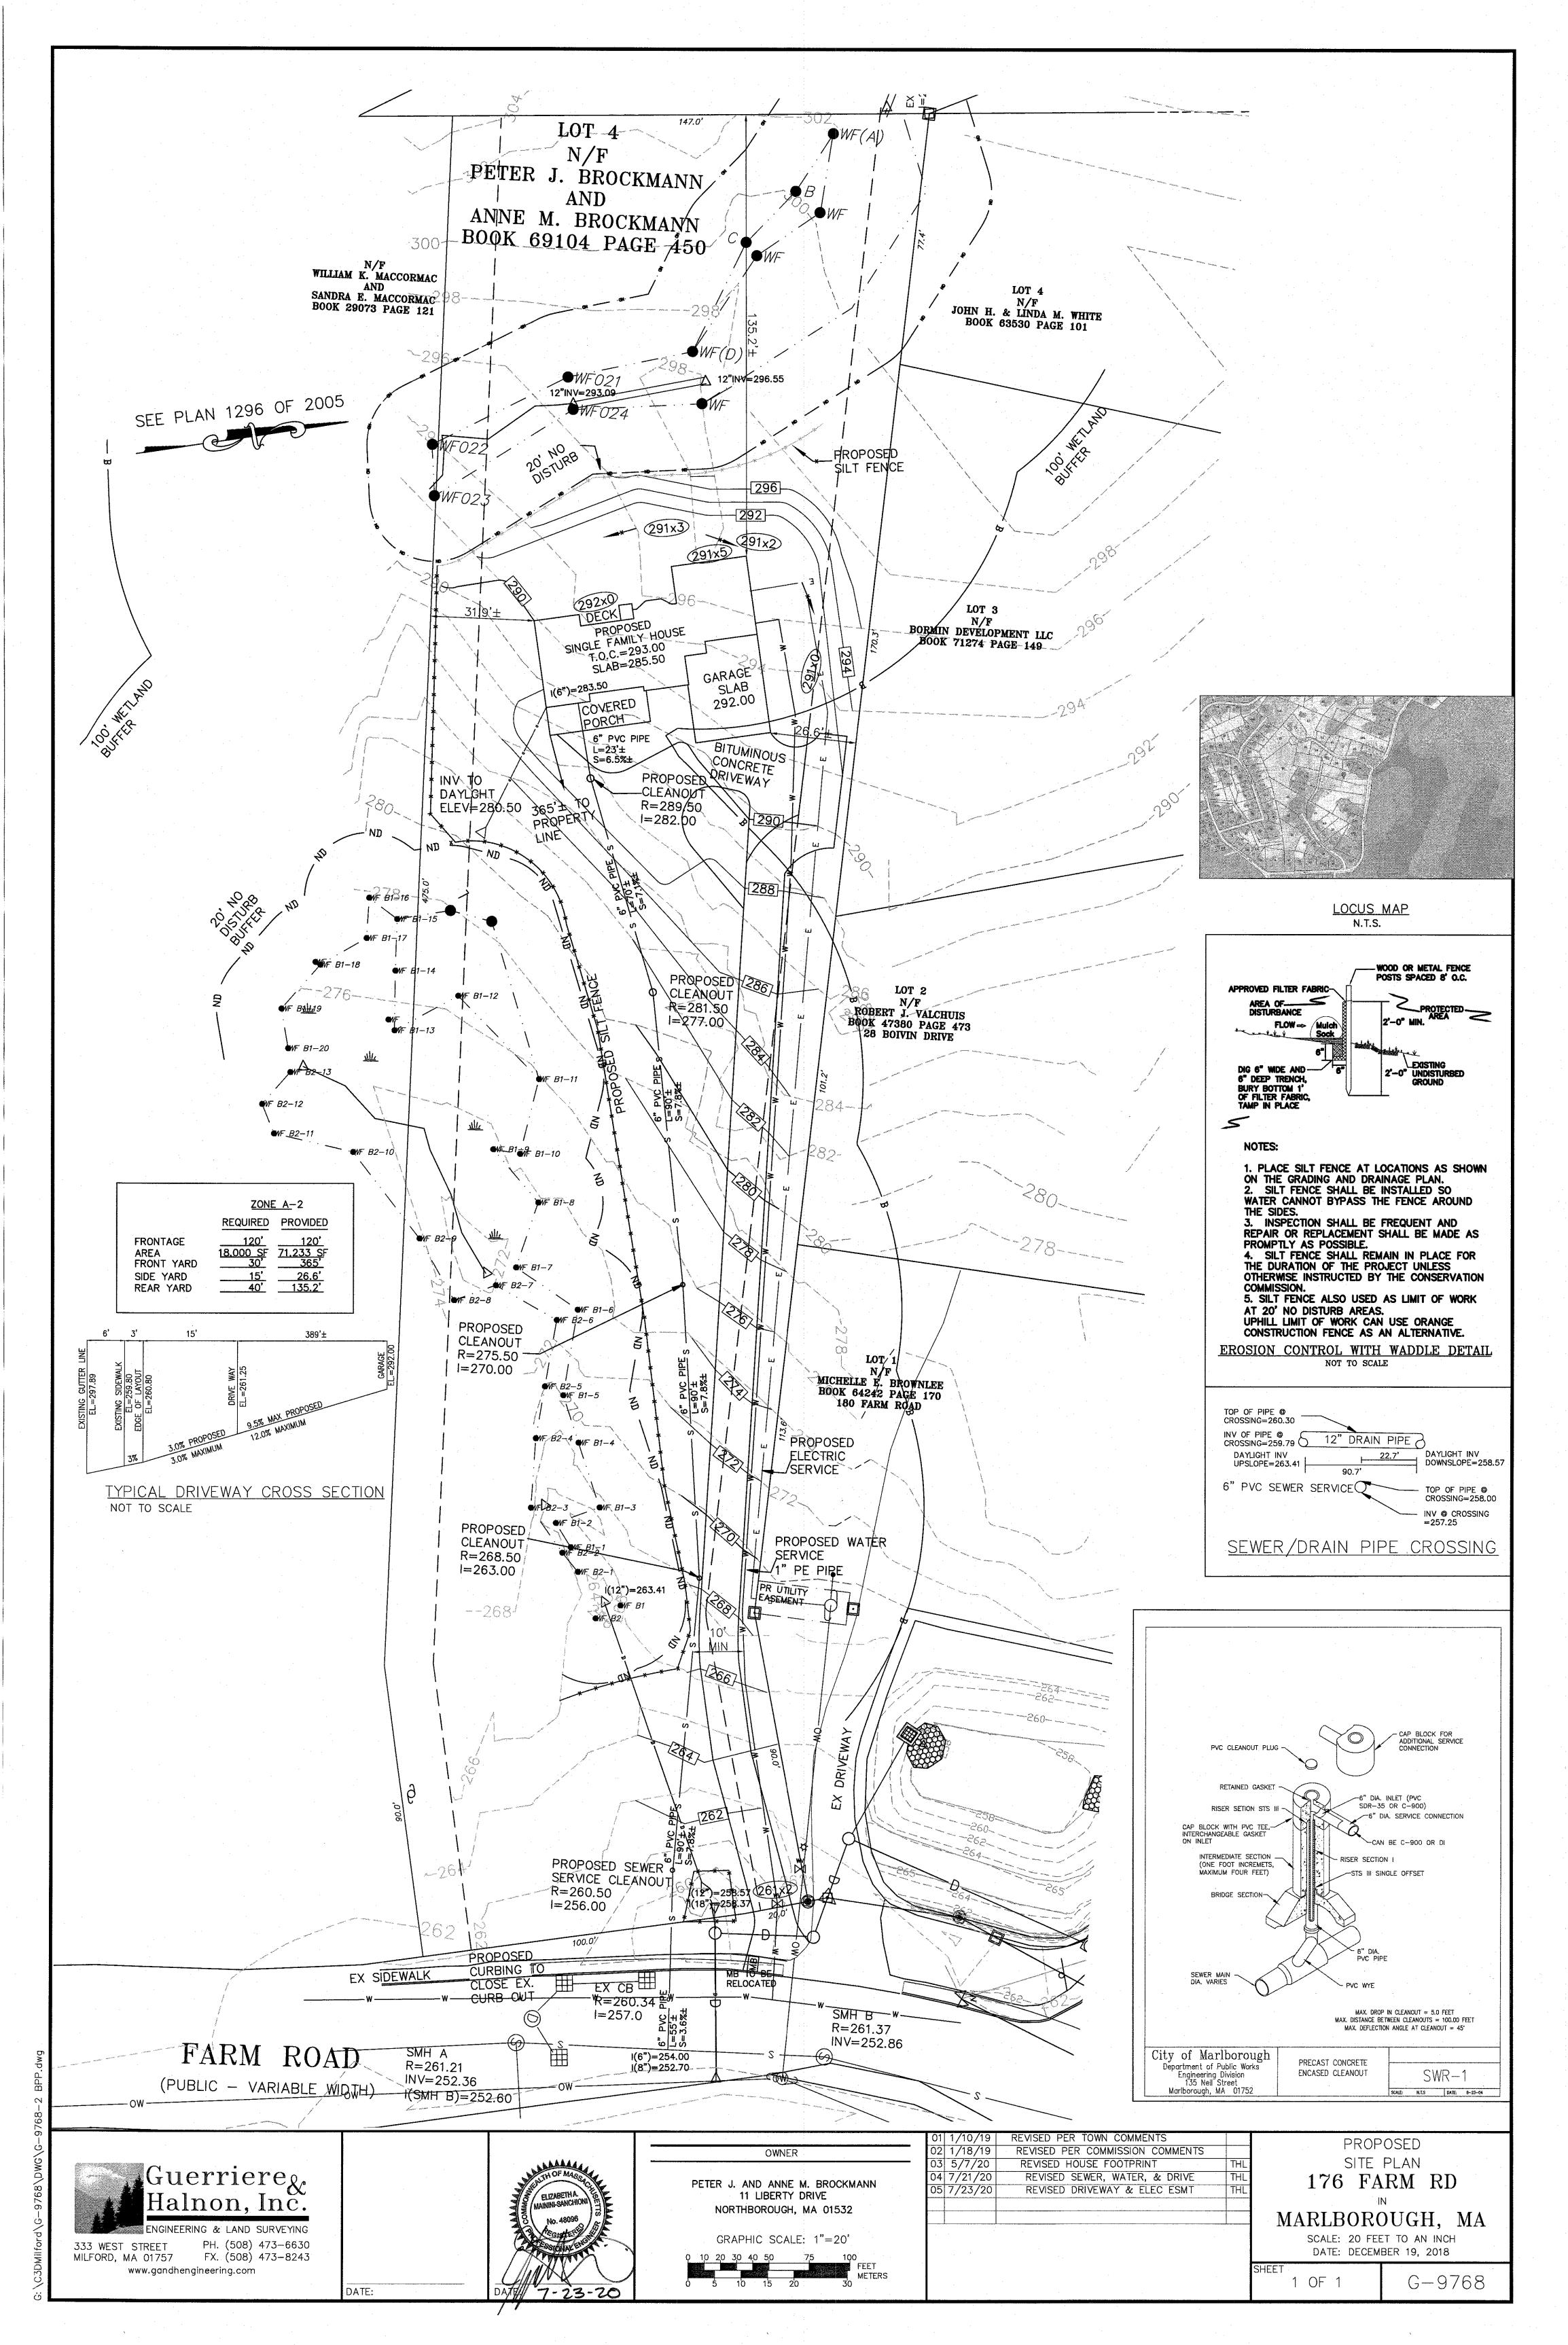
1" - 40" DWG. NAME:

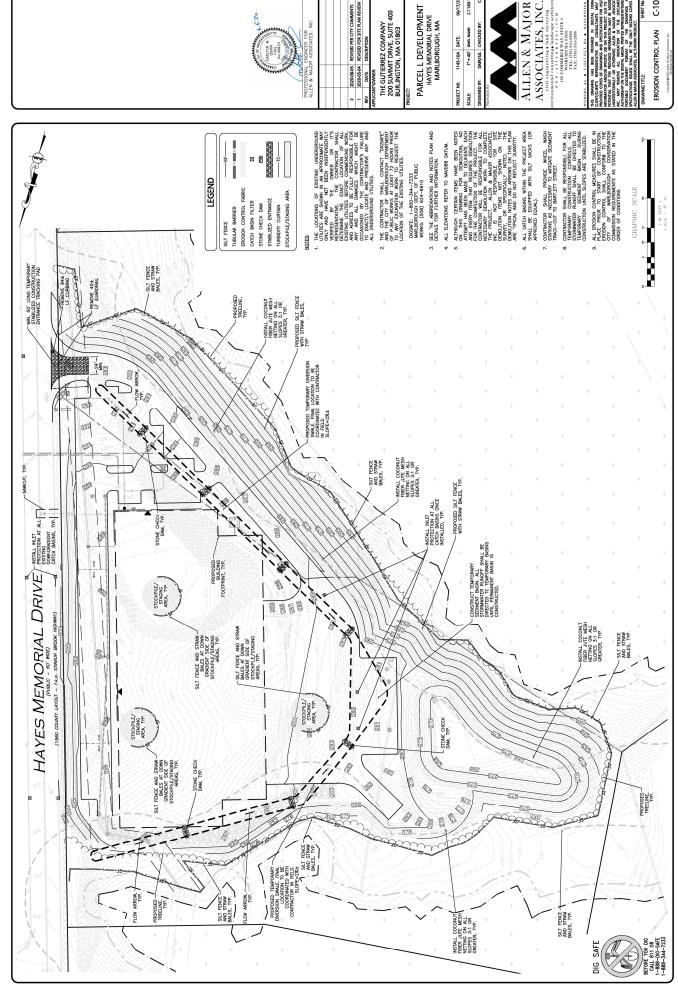1145-10A DATE:



C-1145-10A

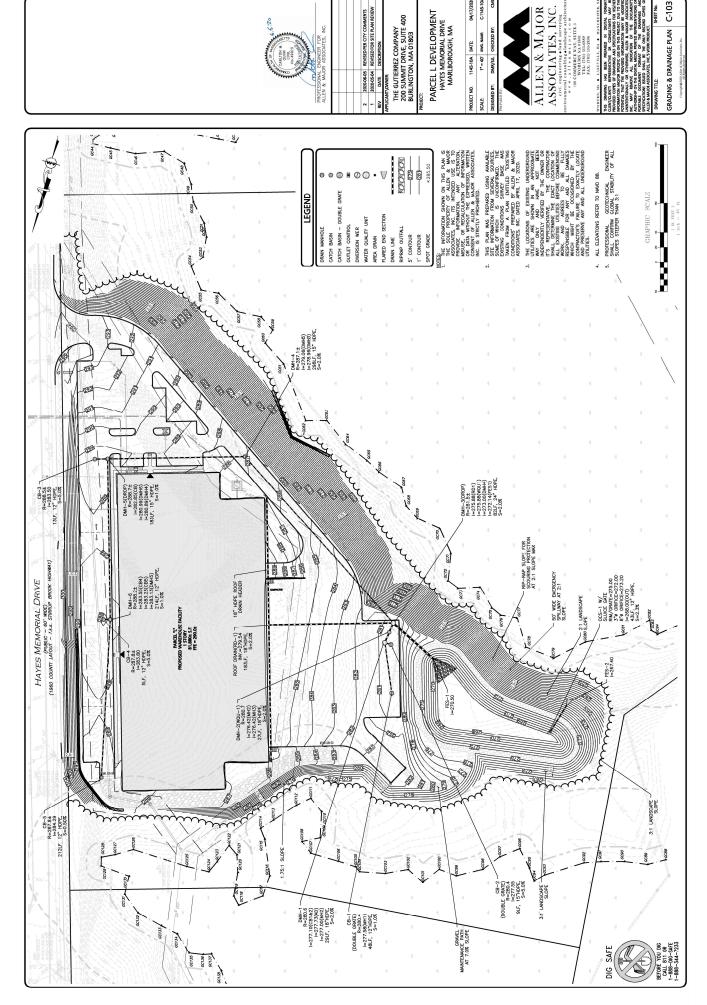04/17/202





July 13, 2020

Chairman Edward Clancy City of Marlborough Conservation Commission 140 Main Street Marlborough, MA 01752 Re: A&M Project: 1145-08A
The Gutierrez Company
c/o Scott Weiss
150 Hayes Memorial Drive
Request for Certificate
of Compliance
DEP File #212-1198

### Dear Chairman Clancy:

On behalf of The Gutierrez Company, and in accordance with Conditions #12, Allen & Major Associates, Inc. (A&M) is submitting a request for a Certificate of Compliance for the Parcel G Distribution Center project at 150 Hayes Memorial Drive (DEP File #212-1198).

### **Completed Special Conditions**

- 1. In accordance with Special Condition #27 A&M, has attached an as-built plan set and a letter of compliance, stamped by a registered professional engineer. Said plans and letter show all conditions of the Order of Conditions have been complied within a satisfactory manner.
- 2. Per Special Condition #29, after the site has been stabilized, all erosion controls shall be removed from the site.
- 3. Per Special Condition #48, the detention basins, all drainage pipes and catch basins, and drainage structures have been cleaned of sediment and debris. All infiltration systems and water quality structures have been inspected and cleaned when necessary.
- 4. Per Special Condition #49, the Stormwater Management System Operations and Maintenance Plan found in section 2.0 in the Drainage Report, has been updated with the final O&M plan in the final drainage report and has been attached for review and approval.
- 5. Special Condition #51 requires the wetland boundary to be marked in the field to show the closest points from wetland to construction. It was determined that there were no wetland locations close enough to construction such that they would require additional marking. Wetlands are still protected by erosion control measures such as silt fences and straw wattles.

This letter serves to notify the Marlborough Conservation Commission that the work depicted on the approved plans has been completed and is in substantial conformance to the approved site plans. Based upon on-site construction observations and the attached "As-Built" drawing prepared by field instrument survey, A&M finds that the proposed site development was completed in substantial

compliance with the approved drawings and Order of Conditions. Please consider this letter as our affidavit of such.

We thank you in advance for the consideration of the Conservation Commission at the next available public hearing. Please let me know if attendance at the hearing will be necessary and a representative can be available. If you have any questions regarding this submittal, please contact me at (781) 305-9431.



Cc: The Gutierrez Company; Scott Weiss

### Attachments:

- 1. Massachusetts Department of Environmental Protection WPA Form 8A Request for Certificate of Compliance.
- 2. P.E. stamped Letter of Drainage Certification, dated January 28, 2020.
- 3. P.E. stamped volume calculations noting both the provided and required stormwater water quality & recharge volumes.
- 4. An updated Operation and Maintenance Plan (O&M) dated May 14, 2020.
- 5. 150 Hayes Memorial Drive "As-Built" Plan by Allen & Major Associates, Inc. dated January 24, 2020 including inverts of all structures and discharge points.



### **Massachusetts Department of Environmental Protection**Bureau of Resource Protection - Wetlands

WPA Form 8A - Request for Certificate of Compliance

Massachusetts Wetlands Protection Act M.G.L. c. 131, §40

DEP File Number:

212-1198 Provided by DEP

### A. Project Information

Important:
When filling out forms on the computer, use only the tab key to move your cursor - do not use the



return key.



Upon completion of the work authorized in an Order of Conditions, the property owner must request a Certificate of Compliance from the issuing authority stating that the work or portion of the work has been satisfactorily completed.

This request is being made by:		
The Gutierrez Company c/o Scott	Weiss	
Name		
200 Summit Drive, Suite 400		
Mailing Address		
Burlington		01803
City/Town	State	Zip Code
781-272-7000		
Phone Number		
2. This request is in reference to wor	k regulated by a final Order of Conditions issu	ied to:
The Gutierrez Company		
Applicant		
October 5, 2018	212-1198	
Dated	DEP File Number	
2. The preject site is leasted at:		
3. The project site is located at:		
Hayes Memorial Drive	Marlborough	
Street Address	City/Town	
Map 99	Parcel 4	
Assessors Map/Plat Number	Parcel/Lot Number	er
	recorded at the Registry of Deeds for: Realty Trust, Arthur Guitierrez, Jr., Trustee	
Property Owner (if different)	really Trust, Artiful Guiderrez, 31., Trustee	
Middlesex South	72032	146
County	Book	Page
N/A		3.
Certificate (if registered land)	h (ah a ak an a)	
Certificate (if registered land)	t (check one):	
Certificate (if registered land)  5. This request is for certification that	t (check one): /e-referenced Order of Conditions has been sa	tisfactorily completed.
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wpaform8a.doc •• rev. 5/29/14 Page 1 of 2

work regulated by it was never started.



### Massachusetts Department of Environmental Protection Bureau of Resource Protection - Wetlands

### WPA Form 8A – Request for Certificate of Compliance

Massachusetts Wetlands Protection Act M.G.L. c. 131, §40

DEP File Number:

212-1198 Provided by DEP

### A. Project Information (cont.)

	of Conditions for this project, or the portion of the project subject to this request, containg any plans stamped by a registered professional engineer, architect, landscape and surveyor?
⊠ Yes	If yes, attach a written statement by such a professional certifying substantial compliance with the plans and describing what deviation, if any, exists from the plans approved in the Order.
☐ No	

### **B. Submittal Requirements**

Requests for Certificates of Compliance should be directed to the issuing authority that issued the final Order of Conditions (OOC). If the project received an OOC from the Conservation Commission, submit this request to that Commission. If the project was issued a Superseding Order of Conditions or was the subject of an Adjudicatory Hearing Final Decision, submit this request to the appropriate DEP Regional Office (see <a href="http://www.mass.gov/eea/agencies/massdep/about/contacts/find-the-massdep-regional-office-for-your-city-or-town.html">http://www.mass.gov/eea/agencies/massdep/about/contacts/find-the-massdep-regional-office-for-your-city-or-town.html</a>).

wpaform8a.doc •• rev. 5/29/14 Page 2 of 2



July 13, 2020

Mr. Thomas DiPersio Marlborough Engineering Department 140 Main Street Marlborough, MA 01752 RE: A&M # 1145-08A

Hayes G Warehouse Project 150 Hayes Memorial Drive **Drainage Certification** 

Dear Mr. Dipersio:

Allen & Major Associates, Inc., on behalf of The Gutierrez Company, has prepared this letter as a written statement certifying substantial compliance of the installed drainage system with the approved site plans for the Hayes G Warehouse project at 150 Hayes Memorial Drive. This letter has been prepared in support of close out with the Conservation Commission, and will be submitted with a WPA Form 8A Request for Certificate of Compliance for the issued Order of Conditions at a future date.

I, Carlton M. Quinn, PE, with Massachusetts Registration No. 49923, being a registered professional civil engineer certify at this time that the drainage improvements have been satisfactorily completed in substantial compliance with the approved site plans on file with the City of Marlborough associated with this project.

Enclosed is a copy of the final stamped and signed site as-built survey for the project, an updated Operation and Maintenance plan revised to incorporate the new owner and operator contact information, as well as a spreadsheet of the design and as-built volumes of the two (2) basins on-site, including one in Northborough. We thank you in advance for your consideration and please contact me with any concerns.



### Attachments:

- 1. WPA Form 8a Request for Certification of Compliance
- 2. Spreadsheet of design versus as-built basin volumes, issued January 28, 2020.
- 3. Operation and Maintenance plan revised through January 28, 2020 incorporating new owner and operator contact information.
- 4. Stamped and Signed As-Built Survey revised through January 24, 2020.

BASIN CAPACITY			By DMR
Hayes G Project - 150 Hayes M	1emorial Drive	Jan. 28, 2020	Checked by CMQ
ВМР	DESIGN VOLUME (FT <sup>3)</sup>	VOLUME PROVIDED (FT <sup>3</sup> )	ADJUST REQUIRED
BASIN #1	108,216	111,242	NO
BASIN #2	53,240	53,524	NO



SITE LOCUS SCALE: 1"=1,000'



## PARCEL G - DISTRIBUTION CENTER DEVELOPMENT NORTHBOROUGH & MARLBOROUGH, MASSACHUSETTS OPERATION & MAINTENANCE PLAN

### **DATE PREPARED:**

**APRIL** 6, 2018

### **REVISED THROUGH:**

MAY 14, 2020

### APPLICANT:

THE GUTIERREZ COMPANY 200 WHEELER ROAD BURLINGTON, MA 01803 781.272.7000

### PREPARED BY:

ALLEN & MAJOR ASSOCIATES, INC. 100 COMMERCE WAY WOBURN, MASSACHUSETTS 01801



**A&M PROJECT NO.:** 1145-08A

A&M Project # 1145-08A Issued April 6, 2018 Revised through May 14, 2020

### OPERATION AND MAINTENANCE PLAN

In accordance with the standards set forth by the Stormwater Management Policy issued by the Department of Environmental Protection (DEP), Allen & Major Associates, Inc. (A&M) has prepared the following Operation and Maintenance plan for the Parcel G Distribution Center Stormwater Management System (SMS).

This plan is broken in to two major sections. The first section describes construction-related erosion and sedimentation controls, which are now complete. The second section is devoted to post-development, on-going operation and maintenance plan which is covered by the remainder of this document. An operation and maintenance schedule has been included with this report.

Stormwater Management System Owner: Hayes G, LLC

28 State Street, 10<sup>th</sup> Floor Boston, MA 02109

Stormwater Management System Operator: Sam Ajanaku (Property Manager)

Lincoln Property Company

1 Van De Graff Drive, Lower Level

Burlington, MA 01803 Tel: (781) 238-4488 Cell: (781) 858-4153 Email: sajanaku@lpc.com

Emergency Response Personnel Contact Information:

Clean Harbors

Marlborough Field Services

50A Brigham Street Marlborough, MA 01752 24-hour line: (800)-645-8265 Bus. Line: (508)-970-8672

-	Allen & Major Associates, Inc. (Site Civil Engineer)	Phone (781) 935-6889
-	Northborough Public Works	Phone (508) 393-5030
-	Northborough Conservation Commission	Phone (508) 393-5015
-	Northborough Fire Department	Phone (508) 393-1537
-	Clean Harbors 24 Hour Emergency Response Line	Phone (800) 645-8265
_	Clean Harbors Local Business Line (Marlborough)	Phone (508) 970-8672

A&M Project # 1145-08A Issued April 6, 2018 Revised through May 14, 2020

### **INTRODUCTION**

The stormwater management system (SMS) for this project is owned by Hayes G, LLC (or current owner) and shall be legally responsible for long-term operation and maintenance for this SMS as outlined in this Operation and Maintenance (O&M) Plan. Should ownership of the SMS change, the succeeding owner will be presented with this O&M Plan and supporting attachments at or before legal conveyance of ownership and will assume the obligations of the O&M Plan. The Town of Northborough shall be notified of any change in ownership.

In the event that the SMS will be operated and maintained by an entity other than that listed in this document, the applicant shall provide a plan and easement deed that provides a right of access for the legal entity to be able to perform said operation and maintenance functions. In the event the SMS will serve multiple lots/owners, the applicant shall also provide a copy of the legal instrument (deed, homeowner's association, utility trust or other legal entity) to the Town of Northborough that establishes the terms of and legal responsibility for the operation and maintenance of the entire SMS.

### POST CONSRUCTION MAINTENANCE PLAN

The SMS shall be inspected immediately after construction, and in accordance with the attached Operation and Maintenance Schedule Log, as well as the Inspection and Maintenance Frequency Section below. The maintenance log will be kept (i.e. reported) by summarizing inspections, maintenance, and any corrective actions taken. The log will include the date on which each inspection or maintenance task was performed, a description of the inspection findings or maintenance completed, and the name of the inspector or maintenance personnel performing the task. If a maintenance task requires the clean-out of any sediments or debris, the location where the sediment and debris was disposed after removal will be indicated. The log will be made accessible to the Conservation Agent and a copy provided to the Department upon request. In accordance with the issued Orders of Conditions for the project, an annual maintenance report shall be provided to the Town Engineer and the Conservation Commission by June 1st of each year reporting on the maintenance and operation procedures, outlined in condition above, which have been met for that year. This reporting requirement will begin with the request for a Certificate of Compliance, or occupancy permit, whichever comes first.

The property is a warehouse and may be used to house rubber tires for a tire wholesaler. Although tires themselves are not considered hazardous materials, due to the nature of the potential contaminants generated by tires which have caught fire, and the location of the site within the Town of Northborough's Groundwater Overlay District 3, an Environmental Incident Response Plan (EIRP) has been incorporated into this Operation and Maintenance report in the event of a building fire containing tires. No tires are currently being stored in the building and the additional EIRP measures are only required during the time when tires are stored on site.

The burning tires could potentially generate contaminants including oil, oil by-products or other hydrocarbons. These potential contaminants could possibly be dispersed by water from

A&M Project # 1145-08A Issued April 6, 2018 Revised through May 14, 2020

the fire suppression system and conveyed to the existing stormwater management system, and eventually infiltrate into groundwater. For this reason, these preventative measures and response plan are required in the unlikely event of a tire fire. The response plan is not intended to be a complete treatment of contaminated fire suppression water on-site, but a reasonable approach to filtering and removing oils and other related contaminants from fire suppression water prior to reaching groundwater. This response plan will only be activated if tires are stored at the property. In the event that tires are stored in the building on the property, then the following items shall apply:

### **Tire Storage Related Pre-Incident Preparations:**

- Each of the eighteen (18) catch basins on-site shall be equipped with one oil absorbent catch basin pillows, installed according to the manufacturer's recommendations. See the attached As-built plan for catch basin locations.
  - o Install Complete Environmental Products, Inc., (CEP) Poly Pillow Part #PIL10, or an equal as approved by the Town of Northborough Engineering Department to remove floating hydrocarbons within the catch basins. See below for more information on the poly pillow.
  - Every catch basin has been installed with a snout to retain hydrocarbons within the catch basins for capture by the poly pillows (or approved equal)
  - Pillows shall be inspected a minimum of every six (6) months and replaced as needed. Deteriorated, used or torn pillows shall be properly disposed of, and additional pillows shall be obtained and installed.
- Have contact information for Clean Harbors Emergency Response Line in a conspicuous location on-site.

Clean Harbors Emergency Response Line: 1-(800) 645-8265

### In case of Tire Fire Incident:

- Evacuate the premises and ensure safety of everyone on-site.
- Call the Northborough Fire Department at (508) 393-1537.
- Contact Clean Harbors Emergency Response to schedule a cleanup.

### **Post Incident:**

- Have Clean Harbors Emergency Response on site as soon as possible after the fire
  has been terminated to remove used pillows and vacuum remaining standing water
  within building and dispose of standing water and used pillows in accordance with all
  Local, State and Federal Regulations. The Town Engineer and Conservation Agent
  shall be notified and afforded the opportunity to inspect the site prior to the start of
  cleanup.
- All catch basin sumps shall be cleaned and vacuumed and contents disposed of in accordance with all Local, State and Federal Regulations.
- Forebays and detention basins shall be cleaned and contents disposed of in accordance with all Local, State and Federal Regulations.
- Provide written reports of the incident and cleanup to the City Engineer of Marlborough and Town Engineer of Northborough within 30 days of the incident.

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- Install new pillows in accordance with manufacturers recommendations.

### Oil Absorbent Catch Basin Pillows:

Any time period during which rubber tires are stored on site, Complete Environmental Products, Inc., Poly Pillows Part #PIL10, or an approval equal, shall be installed in all catch basins. Poly pillows are ideal for spill control, containment, or for skimming oil from water. Oil absorbent catch basin pillows work in conjunction with oil snouts which are permanently installed in all catch basins on site to mitigate potential contaminants, including oil, oil products or other hydrocarbons from exiting the catch basins. The poly pillows (or approved equal) shall be inserted in all catch basins during the presence of rubber tires stored on the property. The use of heavy-duty polypropylene covers makes them resistant to tearing. The pillows shall be inspected every year at a minimum to ensure they are in good condition and have not deteriorated. Deteriorated, used or torn pillows shall be properly disposed of, and additional pillows shall be attained and installed as required, and in accordance with manufacturers recommendations. The Building manager shall maintain a supply of pillows on site equal to the number of catch basins on site at all times.

### **Inspection and Maintenance Frequency and Corrective Measures:**

In accordance with MA DEP Stormwater Handbook: Volume 2, Chapter 2; the following areas, facilities, and measures will be inspected and the identified deficiencies will be corrected. Clean-out must include the removal and legal disposal of any accumulated sediments, trash, and debris. In any and all cases, operations, inspections, and maintenance activities shall utilize best practical measures to avoid and minimize impacts to wetland resource areas outside the foot print of the SMS.

<u>Structural Pretreatment BMPs:</u> Regular maintenance of these BMPs is especially critical because they typically receive the highest concentration of suspended solids during the first flush of a storm event.

### **Deep Sump Catch Basins:**

Inspect catch basins 2 times per year (specifically after foliage and snow season) to ensure that the catch basins and pillows are working in their intended fashion and that they are free of debris. Structures will be skimmed of floatable debris at each inspection and sediment will be removed when or before sump is determined to be 50% full. If the basin outlet is designed with a hood to trap floatable materials (i.e. Snout), check to ensure watertight seal is working.

### **Proprietary Stormwater Separator (Water quality unit):**

Inspect and clean these units in strict accordance with manufacturers' recommendations and requirements. Clean the units using the method specified by the manufacturer. Vactor trucks are typically used to clean these units. Clamshell buckets typically used for cleaning catch basins will not be allowed by manufacturers. Sometimes it will be necessary to remove sediment manually. The only proprietary separator proposed on-site is labeled as DMH-6 on the Grading and Drainage plans and discharges to basin #1 located in Northborough.

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The proprietary stormwater separator shall be maintained as stated in this appended Maintenance Plan and as follows: the system shall be inspected twice annually and shall be cleaned using a vacuum truck in accordance with the manufacturer's instructions and at a minimum annually. Sediment shall be removed when the depth in the chamber reaches 12 inches. During the first year of operation, inspection shall occur monthly and during periods of heavy contaminant loading (e.g. – construction, winter sanding, soil disturbances, or fuel spills). All records of annual maintenance shall be provided to the Commission electronically via e-mail within 30 days.

### **Detention BMPs:**

### **Stormwater Facilities:**

Maintenance of upstream pre-treatment measures is critically important to the function of BMPs. Pre-treatment BMPs shall be inspected for sediment and floatables accumulation and maintained at least twice per year (every other month recommended) and after every major storm event.

### **Surface Structures (Storm Water Detention Basins):**

The surface structures will be inspected within the first three months after construction within 72 hours of a half-inch storm event to ensure it is draining properly. Thereafter, the bottom should be inspected for sediment, trash and debris at least twice per year. Trash, debris, and visible sediment should be removed. The system should also be inspected annually within 72 hours of a half-inch storm event to ensure it is draining properly. Inspections shall be logged in the attached Log Sheet.

Basins shall be maintained and inspected as stated in this Operation and Maintenance Plan and as follows:

- a. During the growing season, the side slopes shall be mowed at least twice with additional cutting performed as needed. Wetland plants shall be allowed to grow along the wet basin bottom, except that and such plants that interfere with the inlet or outlet control devices shall be removed.
- b. All tree saplings shall be removed from embankments and the pond bottom.
- c. The inlet and outlet shall be inspected for erosion and sedimentation; riprap shall be repaired promptly in the event of erosion.
- d. The basins shall be inspected for sediment accumulation annually and any accumulated sediments shall be removed when the depth reaches six inches anywhere in the basins. All accumulated sediments shall be disposed of in accordance with current applicable local, state and federal guidelines and regulations. Sediment removal and other pond maintenance activities shall not be

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considered as a wetland alteration under the Massachusetts Wetlands Protection Act or the Northborough Wetlands Bylaw, however the Commission shall be notified of all such activities at least 48 hours in advance.

### Other BMPs and Accessories:

### **Culverts:**

Inspect culverts 2 times per year (in Spring and Fall) to ensure that the culverts are working in their intended fashion and that they are free of debris. Remove any obstructions to flow; remove accumulated sediments and debris at the inlet, at the outlet, and within the conduit and to repair any erosion damage at the culvert's inlet and outlet.

### **Vegetated Areas:**

Inspect slopes and embankments early in the growing season to identify active or potential erosion problems. Replant bare areas or areas with sparse growth. Where rill erosion is evident, armor the area with an appropriate lining or divert the erosive flows to on-site areas able to withstand the concentrated flows.

### **De-Icing Chemicals:**

In accordance with the Town of Northborough's special condition #14, the use of deicing chemicals shall be limited. Reduced amounts of de-icing chemicals shall be achieved through careful application. Sand shall be the primary agent used for driveways, pedestrian walkways, and parking lots during snow/ice conditions. When necessary for safety conditions, alternative de-icing compounds, such as calcium chloride and/or calcium magnesium acetate shall be used. No de-icing chemicals shall be used where direct run-off/drainage will discharge into the wetland resource areas. This condition shall remain in perpetuity, and shall be recorded as such on the Certificate of Compliance.

### **Roadways and Parking Surfaces:**

Clear accumulations of winter sand in parking lots and along roadways at least once a year, preferably in the spring. Accumulations on pavement may be removed by pavement sweeping. Accumulations of sand along road shoulders may be removed by grading excess sand to the pavement edge and removing it manually or by a front-end loader. In accordance with the Town of Northborough's special conditions #40, the sidewalk and parking lot shall be swept during early and late spring at a minimum or in the event of excessive accumulation.

### **Roof Drains:**

In accordance with the Town of Northborough's special conditions #42, the roof shall be kept clear of debris. An annual inspection shall be conducted and any sediment or other particulate matter that may accumulate shall be removed and reported on the maintenance log sheet.

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### **Snow Storage:**

In accordance with the Town of Northborough's special conditions #41, snow storage shall be limited to the designated locations as indicated on the approved plans.

### **Accumulated Debris:**

In accordance with the Town of Northborough's special conditions #43 and #44, the accumulated debris and sediment shall be removed on an as needed basis, annually at a minimum and all accumulated sediments and hydrocarbons shall be disposed of in accordance with current applicable local, state and federal guidelines and regulations.

### **LANDSCAPED MANAGEMENT PLAN**

It should be recognized that this is a general guideline towards achieving high quality and well-groomed landscaped areas. The grounds staff / landscape contractor must recognize the shortcomings of a general maintenance program such as this and modify and/or augment it based on weekly, monthly, and yearly observations. In order to assure the highest quality conditions, the staff must also recognize and appreciate the need to be aware of the constantly changing conditions of the landscaping and be able to respond to them on a proactive basis.

Additional care must be taken in landscape areas that are functioning as BMP drainage structures. These areas have been specifically designed to treat and convey stormwater and shall be maintained as such. These areas include the Sediment Forebay and Detention Basin and are illustrated on the Grading & Drainage Plan.

### **Fertilizer**

Maintenance practices should be aimed at reducing environmental, mechanical and pest stresses to promote healthy and vigorous growth. When necessary, pest outbreaks should be treated with the most sensitive control measure available. Synthetic chemical controls should be used only as a last resort to organic and biological control methods. Fertilizer, synthetic chemical controls and pest management applications (when necessary) should be performed only by licensed applicators in accordance with the manufacturer's label instructions when environmental conditions are conducive to controlled product application.

Only slow-release organic fertilizers should be used in the landscaped areas to limit the amount of nutrients that could enter downstream resource areas. Fertilization of developed areas on site will be performed within manufacturers labeling instructions. Additionally, the fertilizer will include a slow release element and be Phosphorous free.

In accordance with the Order of Conditions recorded with the Worcester Registry of Deeds

### **DRAINAGE REPORT**

Parcel G Distribution Center Northborough & Marlborough, MA A&M Project # 1145-08A Issued April 6, 2018 Revised through May 14, 2020

Book 59844 Page 211 special condition #13, the use of fertilizers shall be in accordance with manufacturer's recommendations and federal law. Herbicide and pesticide usage shall be in accordance with federal regulations. This condition shall remain in perpetuity, and shall be recorded as such on the Certificate of Compliance.

### **Suggested Aeration Program**

In-season aeration of lawn areas is good cultural practice and is recommended whenever feasible. It should be accomplished with a solid thin tine aeration method to reduce disruption to the use of the area. The depth of solid tine aeration is similar to core type but should be performed when the soil is somewhat drier for a greater overall effect.

Depending on the intensity of use, it can be expected that all landscaped lawn areas will need aeration to reduce compaction at least once per year. The first operation should occur in late May following the spring season. Methods of reducing compaction will vary based on the nature of the compaction. Compaction on newly established landscaped areas is generally limited to the top 2-3" and can be alleviated using hollow core or thin tine aeration methods.

The spring aeration should consist of two passes at opposite directions with 1/4" hollow core tines penetrating 3-5" into the soil profile. Aeration should occur when the soil is moist but not saturated. The cores should be shattered in place and dragged or swept back into the turf to control thatch. If desired the cores may also be removed and the area top-dressed with sand or sandy loam. If the area drains on average too slowly, the topdressing should contain a higher percentage of sand. If it is draining on average too quickly, the top dressing should contain a higher percentage of soil and organic matter.

### Landscape Maintenance Program Practices:

### Lawn

- Mow a minimum of once a week in spring, to a height of 2" to 2 1/2" high. Mowing should be frequent enough so that no more than 1/3 of grass blade is removed at each mowing. The top growth supports the roots; the shorter the grass is cut, the less the roots will grow. Short cutting also dries out the soil and encourages weeds to germinate.
- Mow approximately once every two weeks from July 1st to August 15th depending on lawn growth.
- Mow on a ten-day cycle in fall, when growth is stimulated by cooler nights and increased moisture.
- Do not remove grass clippings after mowing. (Except in Drainage BMP's)
- · Keep mower blades sharp to prevent ragged cuts on grass leaves, which cause a

### **DRAINAGE REPORT**

Parcel G Distribution Center Northborough & Marlborough, MA A&M Project # 1145-08A Issued April 6, 2018 Revised through May 14, 2020

brownish appearance and increase the chance for disease to enter a leaf.

- Supplemental irrigation of lawn areas should provide 1" of water per week in two watering's per week—when no natural rainfall has occurred.
- Shrubs
- Mulch not more than 3" depth with shredded pine or fir bark.
- Hand pruning shall be performed annually based on the natural growth characteristics
  of each species to keep plants from overgrowing walks and windows. NO
  SHEARING OF SHRUBS IS PERMITTED. Typically, pruning of each variety shall
  be immediately after blooming.
- Fertilize with ½ lb. slow-release fertilizer (see above section on Fertilizer) every second year.
- Hand prune evergreen shrubs only as needed to remove dead and damaged wood and to maintain the naturalistic form of the shrub. Never mechanically shear evergreen shrubs.
- Trees
- Provide aftercare for new tree plantings for the first three years.
- Do not fertilize trees, it artificially stimulates them (unless tree health warrants).
- Water once a week for the first year; twice a month the second, once a month the third year.
- Prune trees on a four-year cycle.

### **Grassland Management Protocol**

During the first three growing seasons the native grasslands should mowed one or two times with a sickle bar mower to suppress weed species. The blade shall be set between 5"-10" as directed. If weed growth is not rampant, the first mowing should be done in mid-July. More than one mowing may be necessary over the course of the first and second growing season if extensive weed growth is evident. During the third year of growth, one mowing shall be performed in late July. No rotary mowers shall be used. All cuttings should be removed and disposed of away from the planted area until the grassland habitat is fully established.

No fertilizers shall be used after planting. The low nitrogen available from the soil is an important factor in suppressing many potential invasive species from establishing in the grassland restoration areas.

Herbicides shall only be used where non-grass herbaceous species comprise more than 30 percent of vegetative cover based as determined from monitoring. Appropriate broad-leaf herbicides should be used only according to their directions.

Supplemental Seeding shall be done in areas where the primary seeding has not been

### **DRAINAGE REPORT**

Parcel G Distribution Center Northborough & Marlborough, MA A&M Project # 1145-08A Issued April 6, 2018 Revised through May 14, 2020

successful as directed by the monitor.

### **Maintenance Phase**

By the fourth growing season, the planted grasslands should be reaching maturity. At this time, half of the grassland habitat area should be mown annually in mid- August to maintain the grassland habitat, limiting the opportunity for shrubs and late-blooming forbs to spread, and allowing the grasses time to recover before dormancy.

### MANAGEMENT OF DEICING CHEMICALS AND SNOW

It will be the responsibility of the snow removal contractor to properly dispose of transported snow according to the Massachusetts DEP, Bureau of Resource Protection – Snow Disposal Guideline #BRPG01-0, governing the proper disposal of snow. It will be the responsibility of the snow removal contractor to follow these guidelines and all applicable laws and regulations. A copy of the MA DEP Snow Disposal Guideline #BRPG01-01 has been included at the end of Section 2 for reference.

The sites maintenance staff (or its designee) will be responsible for the clearing of the sidewalk and building entrances. The site may be required to use a de-icing agent such as potassium chloride (or approved equal) to maintain a safe walking surface; however, these are to be used at the minimum amount practicable. The de-icing agent for the walkways and building entrances will be kept within the storage rooms located within the buildings. Deicing agents will not be stored outside. All slopes leading to forested and wetland areas shall be inspected and cleaned weekly of all trash and debris.

### **OPERATION & MAINTENANCE PLAN SCHEDULE**

Project: Parcel G Distribution Center Development

Address: 150 Hayes Memorial Drive

Northoborough & Marlborough, MA

Party Responsible for O & M Plan: The Gutierrez Company
Address: 200 Summit Drive, Suite 400

Burlington, MA 01803

303

 Date:
 4/6/2018

 Revised:
 5/6/2020

Phone: 781-272-7000

Structure or Task	Maintenance Activity	Schedule/Notes	Annual Maintenance Cost	Inspection	Performed
Structure of Task	waintenance Activity	Schedule/Notes	Aimuai Maimteriance Cost	Date:	Ву:
Street Sweeping	Sweep, power broom or vacuum paved areas.	Sweep paved areas as needed, but not less than four times annually.	\$2,000		
Submi		Submit information that confirms that all street sweepings have been disposed in accordance with state and local requirements	Ψ2,000		
Doon Sumn Catch		Inspect at least twice annually. Clean when sediment is within 2.5 feet of the outlet invert.			
Deep Sump Catch Basins(s)  Vacuum sumps		Submit information that confirms that all catch basin sediments have been disposed in accordance with state and local requirements	\$500		
Oil Absorbent Pillows		Pillows shall be inspected a minimum of once per year, and replaced as needed.			
(Or approved equal) (IF Inspect pillows for deterioration and replace as needed. Install pillows in accordance with manufacturer's recommendation.		Deteriorated, used or torn pillows shall be properly disposed of, and additional pillows shall be obtianed and installed.	Varies		
	Vactor trucks or manual cleaning. Clean units in accordance with manufacturers recommendations and requirements. Clam shell not recommended for these units.	Inspect in accordance with manufacturers requirements, but no less than monthly for the first year following installation, and no less than once a year thereafter. Remove sediment and other trapped pollutants at frequency or level specified by manufacturer or when the sediment depth in the chamber reaches 12 inches.	\$2,000		
Storm Water Management System					
	Inspect to ensure it is draining properly. Inspect inlets, outlets and riprap and repair immediately	Perform every other month as well as after every storm event over 1/2". See also note #1 below.	44.44		
Surface Basins	Side slopes mowed at least twice during growing season	On a semi-annual basis.	\$2,000		
Outlet Control Structure(s)	Inspect system bottoms and remove any accumulated sediment greater than 6 inches Vacuum.	Periodic cleaning of Outlet Control Structures as needed.	\$500		
Mosquito Control	CB management targeted larviciding treatment to CB's and all storm drains to control mosquitoes in their aquatic stages.	Surveillance is a non chemical inspection method that involves classification of mosquito breeding sites, larval presents, and survey.	\$100		
	Debris shall be cleared from the site and properly disposed of at the end of the snow season, but shall be cleared no later than May 15.	See Site Plan for appropriate locations. For additional snow storage guidelines see the 2019 MassDEP Snow Disposal Guidance document when determinining snow storage locations.	\$500		

Note #1 - During the first year of operation, all of the BMP's shall be inspected during and after large storm events to ensure they are functioning properly.



### **Product Data Sheet**

**Product Number: PIL10** 

**Product Name:** Sorbent Pillow (Oil Only)

Item #	Amount	Length	Width	Height	Depth	Weight
PIL10	Up to 40 gallons	-	-	-	-	9 lbs/bale

**Dimensions:** 3" x 18" x 24"

### **Description and Application**

Ideal for catch basins and sumps. Provides containment and adsorption while repelling water.

### **Features and Benefits**

- Waterproof packaging
- Hydrophobic
- Non-toxic
- Incinerable 11,000 High BTU, .02% Low Ash Content
- 25 x weight adsorption capacity
- Zero trace elements
- 10/cs

### Composition

• Meltblown Polypropylene



### **SAFETY DATA SHEET**

SECTION 1: IDENTIFICATION OF PRODUCT AND COMPANY INFORMATION

PRODUCT NAME: OIL ONLY ABSORBENT

PRODUCT USE: SORBENT MEDIA USED TO ABSORB OIL-BASED CHEMICALS WHICH INCLUDE BUT NOT LIMITED TO DIESEL FUEL, OIL, GASOLINE

AND KEROSENE WHILE REPELLING WATER AND WATER BASED PRODUCTS.

SPECIFIC PRODUCT TYPE: ABSORBENT PADS. SOCK. PILLOW, NONWOVEN

PRODUCT CODE:

ALL BP, Q, ODT, BEP, SSB, BR, BSR,BER, QB, QR, P, EP, SS, L, R, SR, ER, LR, SLR, QEP, WD, QL, SW, QSR, QER, BB, B, SAK, PS,

PIL, BPIL, COT

COMPANY INFORMATION: COMPLETE ENVIRONMENTAL PRODUCTS, INC. PHONE:

 3500 PASADENA FREEWAY
 FAX:
 713-921-9767

 PASADENA, TX 77503
 EMER:
 713-921-7900

713-921-7900

### **SECTION 2: HAZARDS IDENTIFICATION**

CLASSIFICATION (GHS-US)

THIS PRODUCT IS NOT DANGEROUS IN ITS UNUSED FORM AND CONTAINS NO HAZARDOUS INGREDIENTS.

NOT CLASSIFIED

### **SECTION 3: COMPOSITION/INFORMATION ON INGREDIENTS**

MATERIALS	PERCENT	CAS#
POLYPROPYLENE:	>97%	9003-07-0
ANTI STATIC AGENT	<0.3%	NONE
WHITE PIGMENT	< 1%	NONE
PINK PIGMENT	<1%	NONE
BLUE PIGMENT	< 1%	NONE

### **SECTION 4: FIRST AID MEASURES**

NO SPECIAL PROCEDURES REQUIRED

**SECTION 5: FIRE AND EXPLOSION HAZARD DATA** 

FLASH POINT: >315 DEGREES CELCIUS ( ASTM D93)

FLAMMABLE LIMITS: NOT YET DETERMINED

**EXTINGUISHING MEDIA:** WATER, FOAM, CO2, DRY CHEMICAL

SPECIAL FIRE FIGHTING PROCEDURES: STANDARD PROCEDURE FOR CLASS A FIRES

UNUSUAL FIRE AND EXPLOSION HAZARD: SOME CARBON MONOXIDE UNDER LEAN OXYGEN CONDITIONS

### **SECTION 6: ACCIDENTAL RELEASE MEASURES**

NO SPECIAL STEPS ARE TO BE TAKEN IF MATERIAL IS RELEASED OR SPILLED

### **SECTION 7: HANDLING AND STORAGE**

STORE IN DRY AREA. DO NOT STORE NEAR OPEN FLAME, HIGH HEAT OR STRONG OXIDANTS. POLYPROPYLENE, WHEN HEATED, BECOMES VERY STICKY AND WILL BURN. USE SELF-CONTAINED AIR MASK TO ENTER SMOKY AREA IN THE EVENT OF FIRE.

### SECTION 8: EXPOSUR CONTROLS/PERSONAL PROTECTIVE EQUIPMENT

EXPOSURE LIMITS: OSHA PEL: N/A ACGIH TLV: N/A

RESPIRATORY PROTECTION:

VENTILATION:

NONE REQUIRED

PROTECTIVE GLOVES: NONE REQUIRED ONLY IF MOLTAN

EYE PROTECTION: NONE REQUIRED OTHER PROTECTIVE EQUIPMENT (SPECIFY): NONE REQUIRED

### **SECTION 9: PHYSICAL AND CHEMICAL PROPERTIES**

 COLOR:
 WHITE, BLUE

 DENSITY:
 0.04 - 0.06 gram/cc

 ODOR:
 NO ODOR

 SPECIFIC GRAVITY:
 0.88 - 0.92

 FLASH POINT:
 NOT APPLICABLE

BOILING POINT: NOT APPLICABLE

MELTING POINT: > 160 DEGREES CELSIUS
SOLUBILITY IN WATER: INSOLUABLE

PERCENT VOLATILE:

EVAPORATION RATE:

VAPOR PRESSURE ( mm Hg):

VAPOR DENSITY (Air = 1):

NOT APPLICABLE

NOT APPLICABLE

**AUTO IGNITION TEMPERATURE** >675 DEGREES FAHRENHEIT

### **SECTION 10: STABILITY AND REACTIVITY DATA**

STABILITY: STABLE INCOMPATIBILITY (conditions to avoid): NONE

INCOMPATIBILITY (materials to avoid): NITRIC ACID, PERCHLORIC ACID, SULFURIC ACID OR 98% SULFURIC ACID

HAZARDOUS DECOMPOSITON: WHEN HEATED, IT MAY EMIT TOXIC

HAZARDOUS POLYMERAZATION: WILL NOT OCCURE

### **SECTION 11: TOXOCOLOGICAL INFORMATION**

HEALTH HAZARDS (acute or chronic):

SIGNS OR SYSMPTOMS OF EXPOSURE:

MEDICAL CONDITIONS GENERRALLY AGGRAVATED BY EXPOSURE:

NONE

**DATE ISSUED:** September 14, 2015

PREPARED BY: WORLDWIDE SORBENT PRODUCTS, INC.

### **SECTION 12 TO SECTION 15 NOT APPLICABLE**

### **SECTION 16: OTHER INFORMATION**

SDS REVISION DATE: September 1, 2018


: 0 - EXPOSURE UNDER FIRE CONDITIONS WOULD OFFER NO HAZARD BEYOND

NFPA HEALTH HAZARD THAT OF ORDINARY COMBUSTIBLE MATERIALS.

NFPA FIRE HAZARD : 1 - MUST BE PREHEATED BEFORE IGNITION CAN OCCUR.

NFPA REACTIVITY : 0 - NORMALLY STABLE, EVEN UNDER FIRE EXPOSURE CONDITIONS, AND ARE

THE INFORMATION CONTAINED HEREIN IS ACCCURATE TO THE BEST OF MY KNOWLEDGE. MY COMPANY MAKES NO WARRANTY OF ANY KIND, EXPRESS OR IMPLIED, CONCERNING THE SAFE USE OF THIS MATERIAL IN YOUR PROCESS OR IN COMBINATION WITH OTHER SUBSTANCES

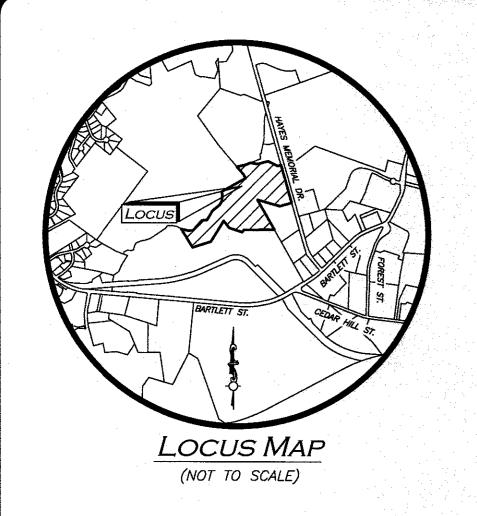

LOCUS REFERENCES

-DEED BOOK 72251, PAGE 340 --PLAN 1046 OF 2018 -OWNER OF RECORD: HAYES G, LLC

### PLAN REFERENCES

-PLAN 1046 OF 2018 -PLAN 13246 OF 1999 -LAND COUNT CASE 4247H -PLAN BOOK 246 PLAN 53 -PLAN BOOK 760 PLAN 55 -PLAN 999 OF 2008 -PLAN 945 OF 2003 -PLAN BOOK 335 PLAN 14 -"COMMONWEALTH OF MASSACHUSETTS HARBOR AND LAND COMMISSION, ATLAS OF THE BOUNDARIES OF THE CITY

OF MARLBOROUGH" DATED 1908


### NOTES

- 1. NORTH ARROW IS BASED ON MASSACHUSETTS GRID COORDINATE SYSTEM (MAINLAND ZONE) (NAD 83).
- 2. BOOK/PAGE AND PLAN REFERENCES ARE TAKEN FROM MIDDLESEX (SOUTH) REGISTRY OF DEEDS IN CAMBRIDGE, MA.
- 3. VERTICAL DATUM IS NAVD 88.
- 4. CONTOUR INTERVAL IS ONE FOOT (1').
- 5. ALL CURBING SHOWN HEREON IS CONCRETE UNLESS
- OTHERWISE NOTED. 6. UNDERGROUND ELECTRIC, GAS, SEWER FORCE MAIN, TELEPHONE AND WATER LINES SHOWN HEREON TAKEN FROM A PLAN ENTITLED "AS-BUILT" DATED DECEMBER 11, 2019. PREPARED BY BORGGAARD CONSTRUCTION CORPORATION.
- 7. WETLANDS DELINEATED BY GODDARD CONSULTING LLC AND FIELD LOCATED BY ALLEN & MAJOR ASSOCIATES, INC. ON OR BETWEEN 11-10-18, 02-09-27, 02-27-18 & 07-25-18.
- 8. ELEVATIONS SHOWN BELOW THE EDGE OF WATER LINE IN THE DETENTION BASIN (LOCATED ON THE NORTHBOROUGH PORTION OF THE PROPERTY) ARE TAKEN FROM A PLAN ENTITLED "AS-BUILT" DATED DECEMBER 11, 2019, PREPARED BY BORGGAARD CONSTRUCTION CORPORATION.

### UTILITY STATEMENT

THE UTILITIES SHOWN HAVE BEEN LOCATED FROM FIELD SURVEY INFORMATION AND EXISTING DRAWINGS. ALLEN & MAJOR ASSOCIATES, INC. (A&M) MAKES NO GUARANTEE THAT THE UTILITIES SHOWN HEREON COMPRISE ALL SUCH UTILITIES IN THE AREA. EITHER IN SERVICE OR ABANDONED. A&M FURTHER DOES NOT WARRANT THAT THE UTILITIES SHOWN ARE IN THE EXACT LOCATION INDICATED. A&M HAS NOT PHYSICALLY LOCATED THE UNDERGROUND UTILITIES.

### HAYES MEMORIAL DRIVE MEMUNIA (PUBLIC - 60 FEET WIDE) SMH RIM=281.85 INV(BC)=278.15

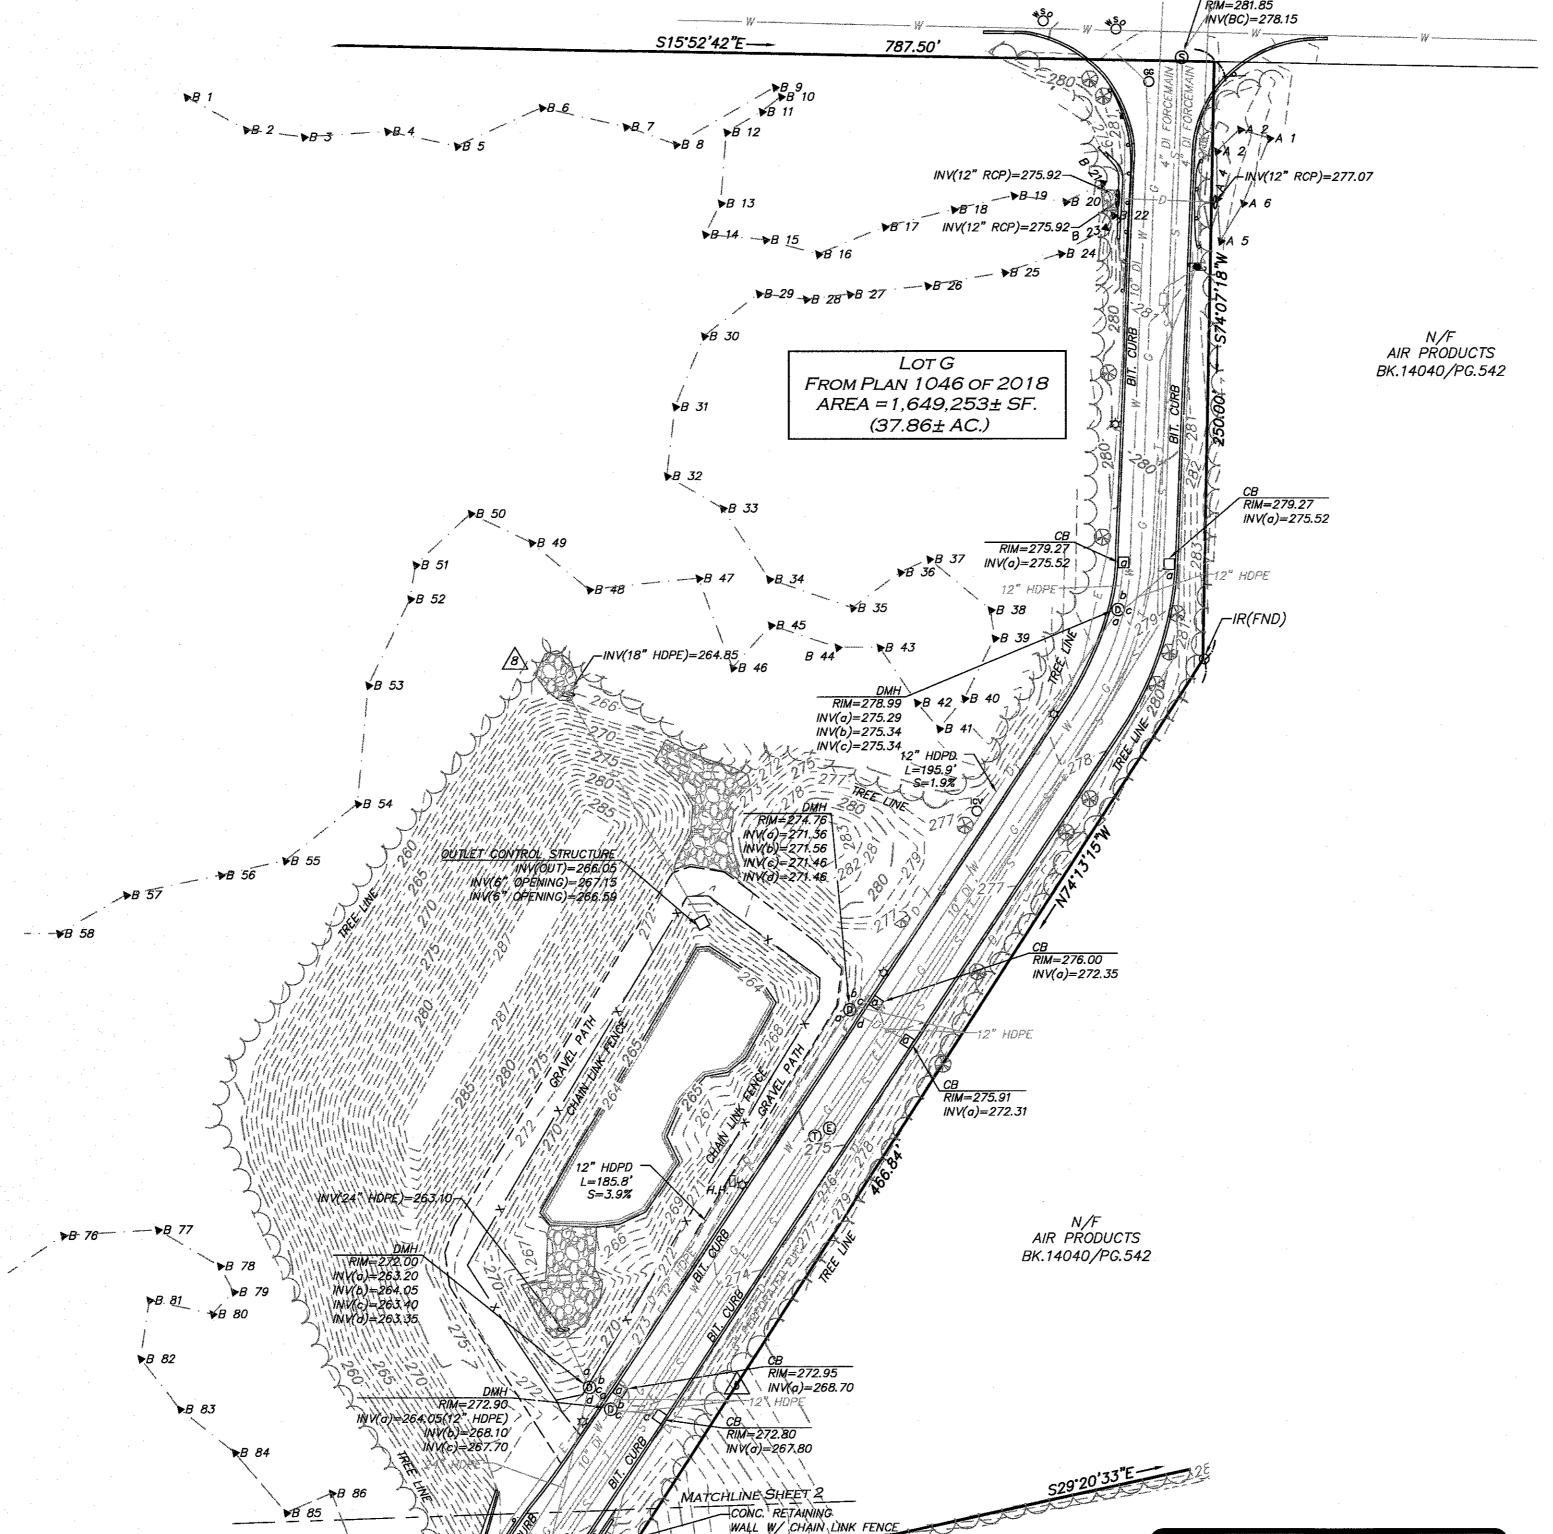

PARKING SUMMARY 162 STANDARD STALLS HANDICAPPED STALLS 169 TOTAL STALLS

TBM # ELEV. DESCRIPTION COTTON GIN SPINDLE 282.69 IN UTILITY POLE COTTON GIN SPINDLE 281.07 IN TREE COTTON GIN SPINDLE 265.00 IN TREE COTTON GIN SPINDLE 285.99 IN TREE X-CUT ON HYDRANT 272.59 FLANGE BOLT

BENCHMARK SUMMARY

### **LEGEND**

LEGEND	
IRON ROD (IR) CONCRETE BOUND SET BY OT CONCRETE BOUND SET IRON PIN SET BY OTHERS IRON PIN SET CONSERVATION RESTRICTION SED DRAIN MANHOLE (DMH) SEWER MANHOLE (SMH) ELECTRIC MANHOLE (EMH) MISC. MANHOLE (MH) TELEPHONE MANHOLE (TMH) CATCH BASIN (CB) UTILITY POLE W/RISER FIRE HYDRANT	
WATER GATE  GAS GATE  BOLLARD  CLEANOUT  INVERT (INV)  FLARED END SECTION  LIGHT	%) ( ) ⇔ ( ) ⇔ (
TREE SIGN TRANSFORMER DOWNSPOUT WETLAND FLAG HAND HOLE GAS METER	<ul> <li>₩</li> <li>□</li> <li>► A31</li> <li>□ H.H.</li> <li>Ø</li> </ul>
HANDICAPPED PARKING SPACE  PARKING SPACE COUNT  CONCRETE  RIP—RAP  BUILDING  WETLAND  1' CONTOUR  5' CONTOUR	66 2020202 
PROPERTY LINE ABUTTERS LINE TOWN LINE CONCRETE RETAINING WALL TREE LINE EDGE OF GRAVEL EDGE OF WATER	
CURB CHAIN LINK FENCE GUARDRAIL WATER LINE SEWER LINE DRAIN LINE GAS LINE ELECTRIC LINE	
TELEPHONE LINE  OVERHEAD WIRES  FINISHED FLOOR ELEVATION  BITUMINOUS  CONCRETE  GRANITE  BOTTOM CENTER	FFE BIT. CONC. GRAN. (BC)
REINFORCED CONCRETE PIPE POLYVINYL CHLORIDE PIPE DUCTILE IRON PIPE HIGH DENSITY POLYETHYLENE FOUND NOW OR FORMERLY BOOK PAGE	RCP PVC DI PIPE HDPE FND N/F BK. PG.

GRAPHIC SCALE ( IN FEET ) 1 inch = 40 ft.

N:\PROJECTS\1145-08A\SURVEY\DRAWINGS\S-1145-08A-AB.DWG


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BETWEEN MARCH 29, 2018 AND DECEMBER 13, THIS PLAN ACCURATELY DEPICTS THE AS-BUILT CONDITIONS AS THEY EXISTED AT THE TIME OF THE FIELD SURVEY. THE ABOVE IS CERTIFIED TO THE BEST OF MY PROFESSIONAL KNOWLEDGE, INFORMATION,

ALLEN & MAJOR ASSOCIATES, INC.


AND BELIEF.

ALLEN & MAJOR ASSOCIATES, INC.

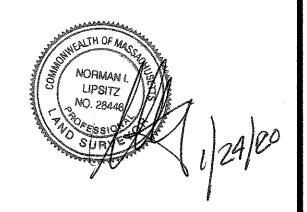

WE HEREBY CERTIFY THAT: THE AS-BUILT INFORMATION SHOWN ON THIS PLAN IS IN CONFORMANCE WITH THE APPROVED SITE PLANS DATED NOVEMBER 14, THE ABOVE IS CERTIFIED TO THE BEST OF

MY PROFESSIONAL KNOWLEDGE, INFORMATION, AND BELIEF.

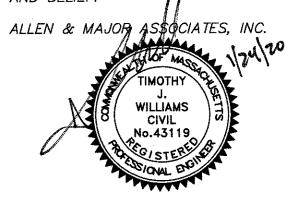

PROFESSIONAL ENGINEER FOR ALLEN & MAJOR ASSOCIATES, INC.

01/24/20 | VARIOUS REVISIONS

REV DATE DESCRIPTION

APPLICANT\OWNER:

THE GUTIERREZ COMPANY 200 SUMMIT DRIVE, SUITE 400 BURLINGTON, MA 01803

HAYES G DEVELOPMENT 150 HAYES MEMORIAL DRIVE MARLBOROUGH, MA & NORTHBOROUGH, MA

PROJECT NO. 1145-08A DATE: 12/20/19 1" = 40' DWG. NAME: S-1145-08A-AF SCALE: COB/KAC | CHECKED BY: DRAFTED BY:



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environmental consulting ◆ landscape architecture www.allenmajor.com 100 COMMERCE WAY WOBURN MA 01801-8501 TEL: (781) 935-6889 FAX: (781) 935-2896

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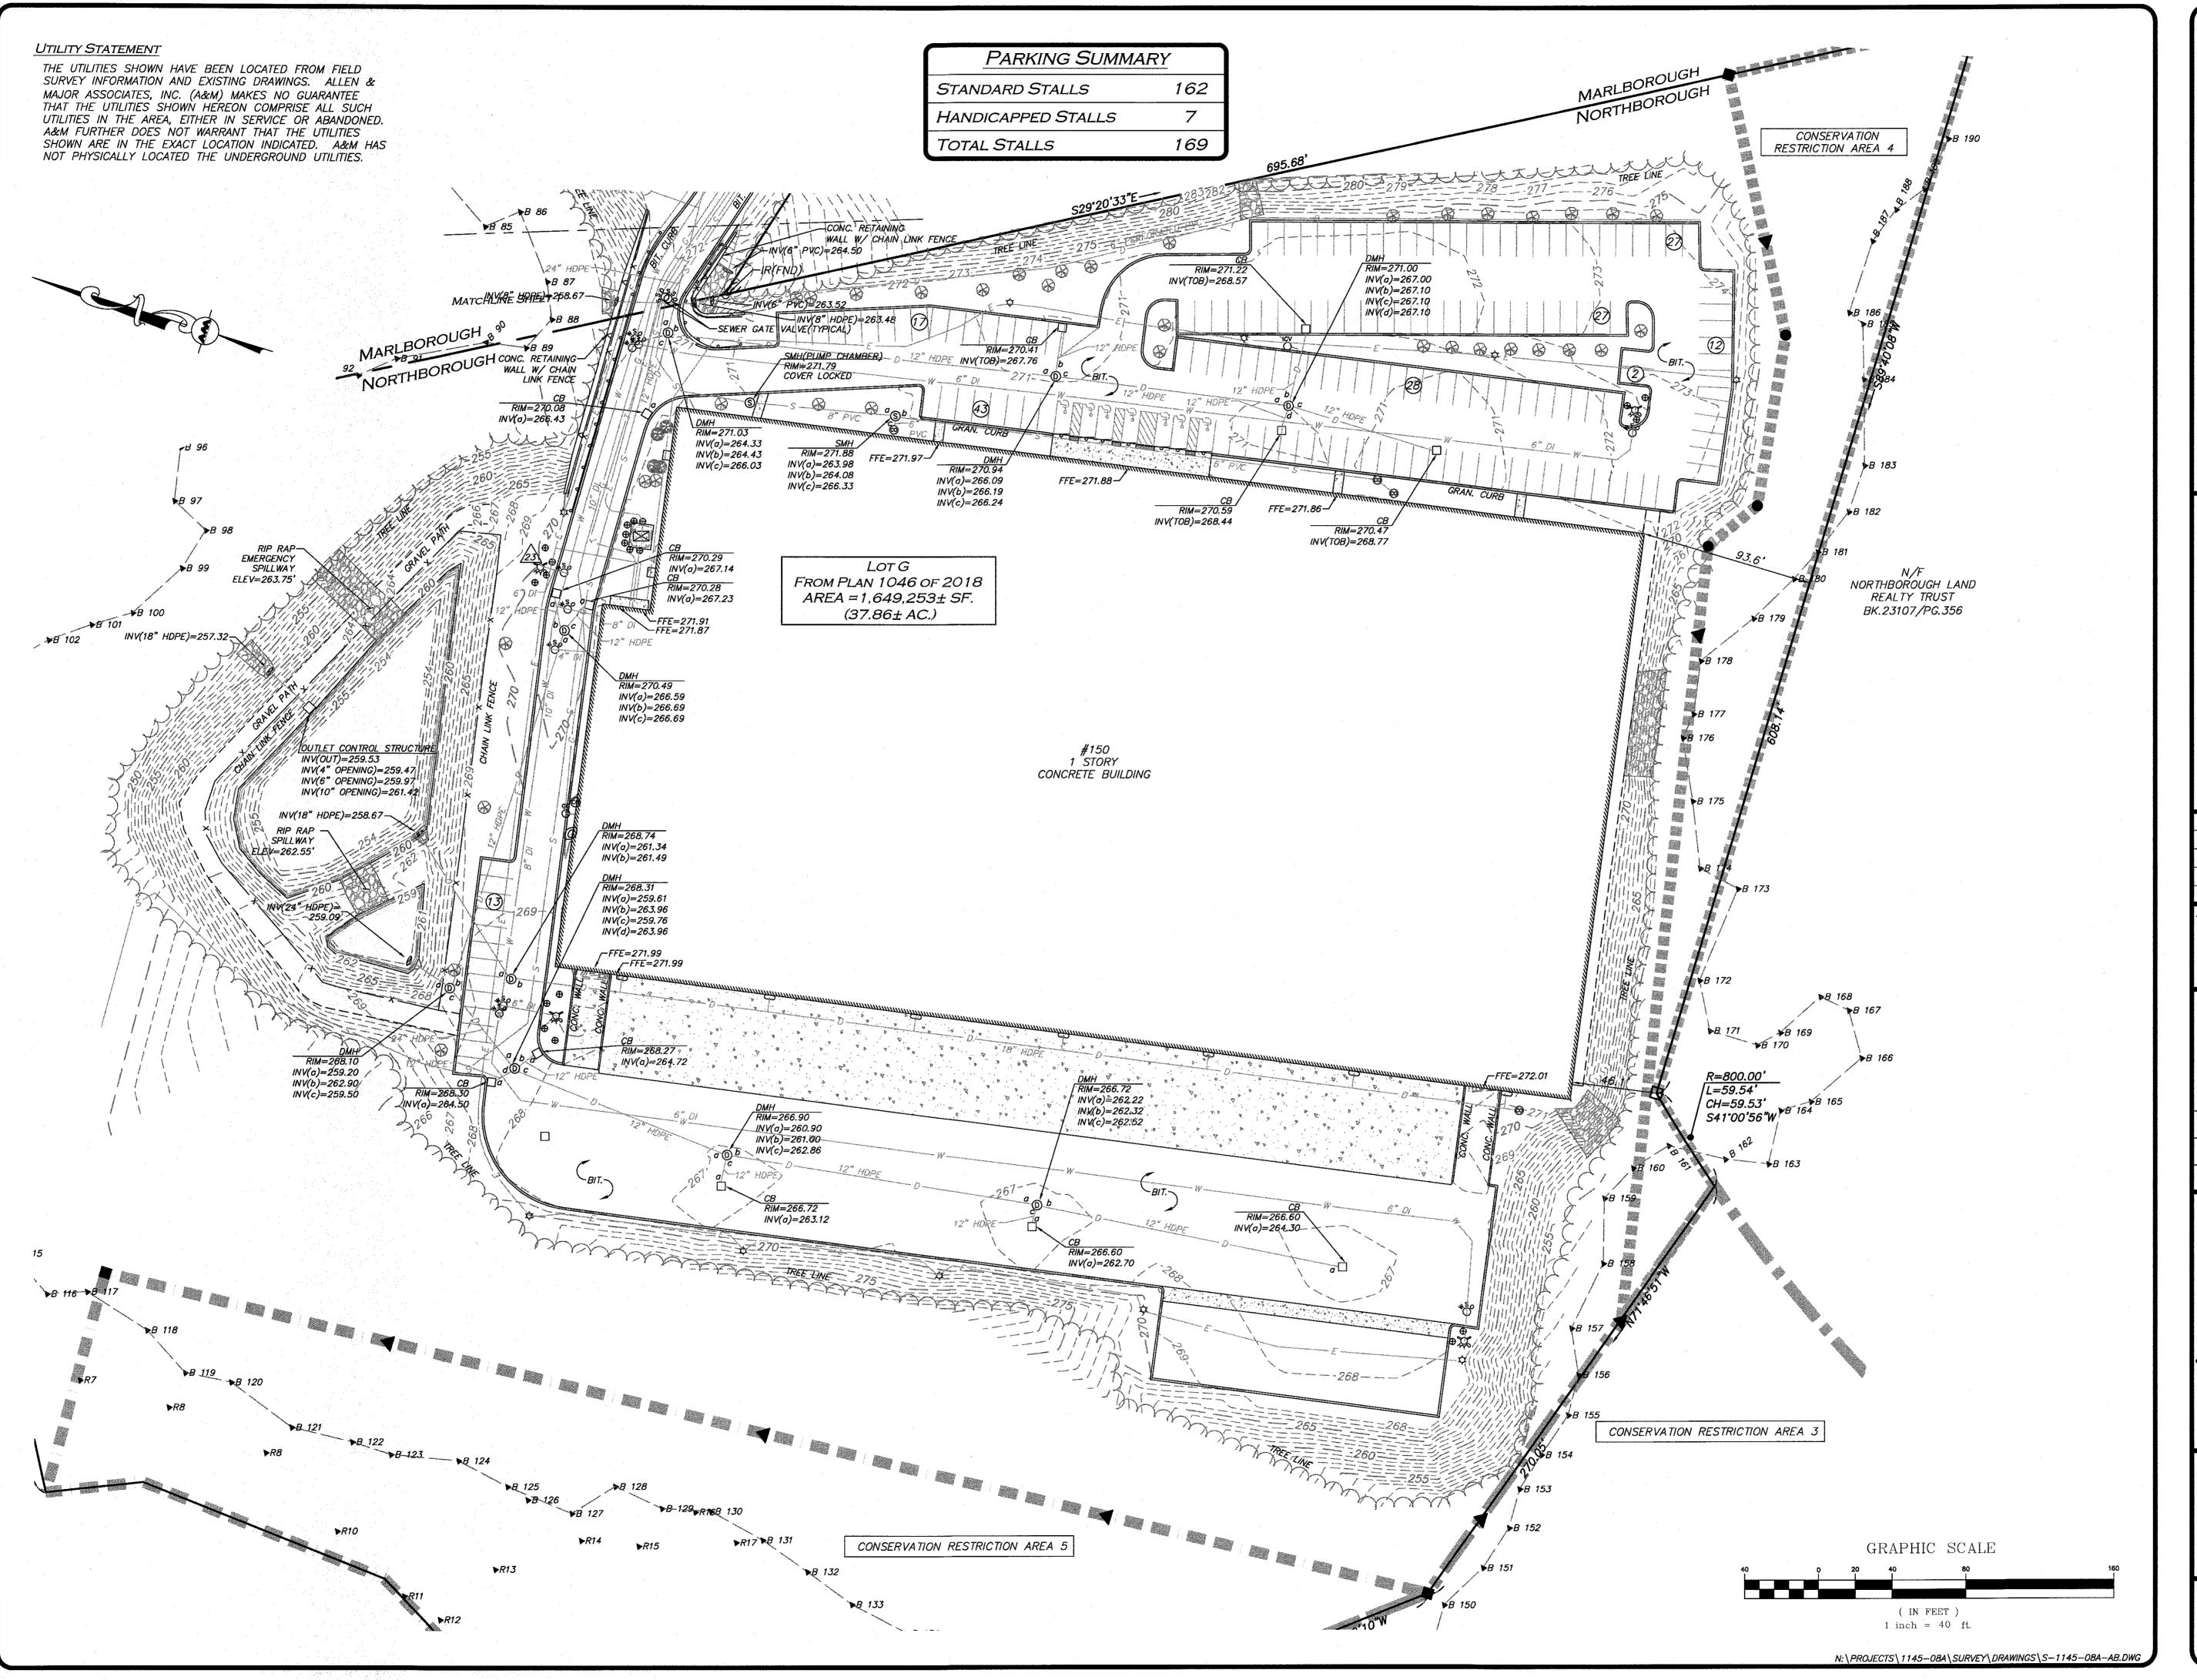
DRAWING TITLE:

**AS-BUILT** 

SHEET No.

1 OF 2

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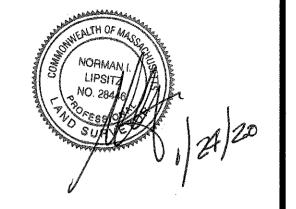
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ON THE GROUND SURVEY PERFORMED ON OR
BETWEEN MARCH 29, 2018 AND DECEMBER 13

THIS PLAN ACCURATELY DEPICTS THE AS—BUILT CONDITIONS AS THEY EXISTED AT THE TIME OF THE FIELD SURVEY.

THE ABOVE IS CERTIFIED TO THE BEST OF MY PROFESSIONAL KNOWLEDGE, INFORMATION, AND BELIEF.

ALLEN & MAJOR ASSOCIATES, INC.

PROFESSIONAL LAND SURVEYOR FOR 1 20 2 ALLEN & MAJOR ASSOCIATES, INC.




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APPROVED SITE PLANS DATED NOVEMBER 14,
2018.

THE ABOVE IS CERTIFIED TO THE BEST OF
MY PROFESSIONAL KNOWLEDGE, INFORMATION,

ALLEN & MAJOR ASSOCIATES, INC.

AND BELIEF.

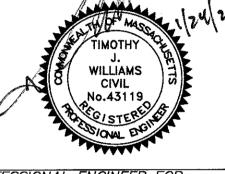

PROFESSIONAL ENGINEER FOR ALLEN & MAJOR ASSOCIATES, INC.

	1
1. 01/24/2	O VARIOUS REVISIONS
REV DATE	DESCRIPTION

THE GUTIERREZ COMPANY 200 SUMMIT DRIVE, SUITE 400 BURLINGTON, MA 01803

PROJECT:

HAYES G DEVELOPMENT
150 HAYES MEMORIAL DRIVE
MARLBOROUGH, MA &
NORTHBOROUGH, MA

PROJECT NO. 1145-08A DATE:

SCALE: 1" = 40' DWG. N

1" = 40' DWG. NAME: S-1145-08A-AI

12/20/19

DRAFTED BY: COB/KAC CHECKED BY:



ASSOCIATES, INC.

civil engineering • land surveying
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w w w . a l l e n m a j o r . c o m

100 COMMERCE WAY
WOBURN MA 01801-8501
TEL: (781) 985-6889
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**AS-BUILT** 

July 29, 2020

Attn. Israel Lopez The Gutierrez Company 200 Summit Drive, Suite 400 Burlington, MA 01803

Re: Memorandum: Wetland Finger Discovery and Restoration

Parcel 'L' Hayes Memorial Drive

Goddard Consulting, LLC is pleased to submit this memorandum on the wetland finger noted during test pit work at Parcel 'L' on Hayes Memorial Drive in Marlborough.

### Site Inspection

Goddard reviewed the low valley at the eastern end of the uplands on parcel 'L' and noted the valley had a very subtle and small spot were potential surface water overflowed from a low point into the previously delineated wetland line at GC78 and GC79. This connection was overlooked during the delineation under full-leaf out in the fall of 2019 due to the dense vegetation and became apparent after soil testing was completed in the area. This area has been flagged by Goddard. From Goddard's review the area should be restored to a natural condition.

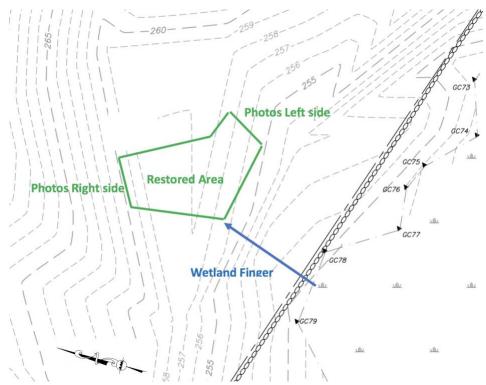


Figure 1: General Location of Area Restored (not to scale)

#### Area Restoration

Goddard supervised a work crew to restore the natural woody area that was disturbed during the soil testing. This included transplanting native vegetation from uplands areas outside the Buffer Zone to the area disturbed. Work occurred on July 8th and 10th.

During the work the following was completed:

- Soils from backfilled test pits was removed to expose existing topsoil.
- 4+ dozen Cinnamon, Sensitive, Intermediate woodfern, and Christmas ferns were transplanted
- 12+ Highbush blueberry, spicebush shrubs were transplanted
- Woody debris added for wildlife habitat
- Leaf duff added to provide natural forest ground cover
- Note: +/- 2 dozen Cinnamon and Sensitive ferns were already present within the area resorted and existing red maples are providing tree cover over this area. In addition small herbaceous vegetation is growing back in exposed topsoil.



Photo 1: Panoramic photo of restored area from upgradient corner (Photos 2-9 provide close ups from left/east to right/north)



Photo 2: Restored Area, far left (east), looking left to right



Photo 3: Restored Area, middle left, looking left to right.



Photo 4: Restored Area, middle, looking left to right.



Photo 6: Restored Area, middle right, looking left to right.



Photo 8: Restored Area, far right (north), looking left to right.



Photo 5: Restored Area, middle, looking left to right.



Photo 7: Restored Area, far right (north), looking left to right.



Photo 9: Restored Area, far right (north), looking left to right

#### Conclusion:

Goddard would find that the restoration work has exposed most of the natural soils and provided a good native vegetation to the restored area. The area should have 75% vegetative coverage that includes herbaceous, shrubs and trees once herbaceous vegetation currently coming up has fully grown back.

#### Peer Review Follow-up:

On July 18, 2020 the wetland line was reviewed by Scott Smyers from Oxbow Associates along with two Conservation Commission members. The revised flagging around the wetland finger was reviewed and the restoration work was found to be acceptable.

If there are any questions concerning this report, please do not hesitate to contact us.

Sincerely,

Goddard Consulting, LLC

By:

Scott G. Goddard, PWS

Professional Wetland Scientist

Bv:


Mark R. Arnold

BSc, Wetland Engineer

#### Distribution List via email:


- David M. Robinson, Allen & Major Associates, Inc., drobinson@allenmajor.com
- Joe Vasapolli, Gutierrez Construction Company, jvasapolli@gutierrezco.com
- Israel Lopez, Gutierrez Construction Company, ilopez@gutierrezco.com

# Hayes Memorial Drive @ 495 Center

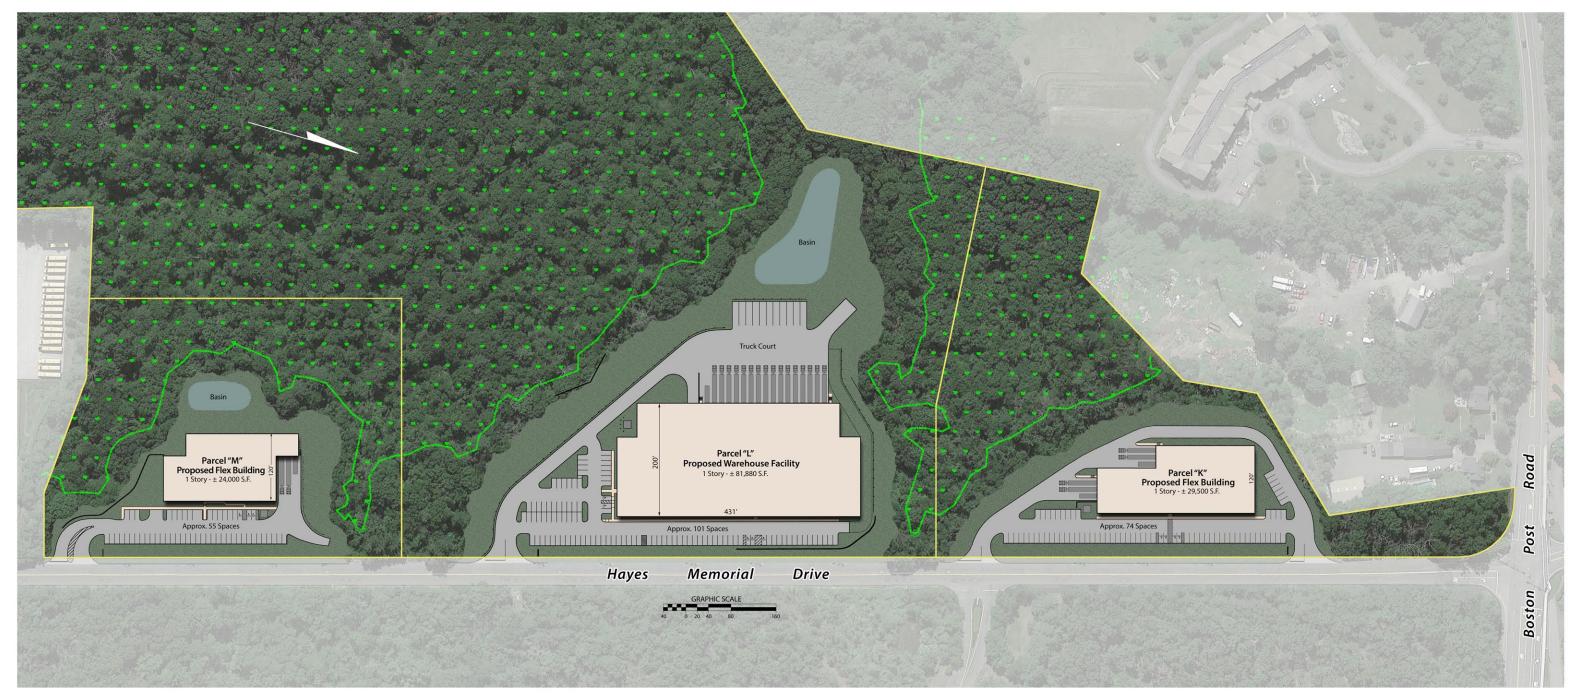

Overview - Lots M, L & K



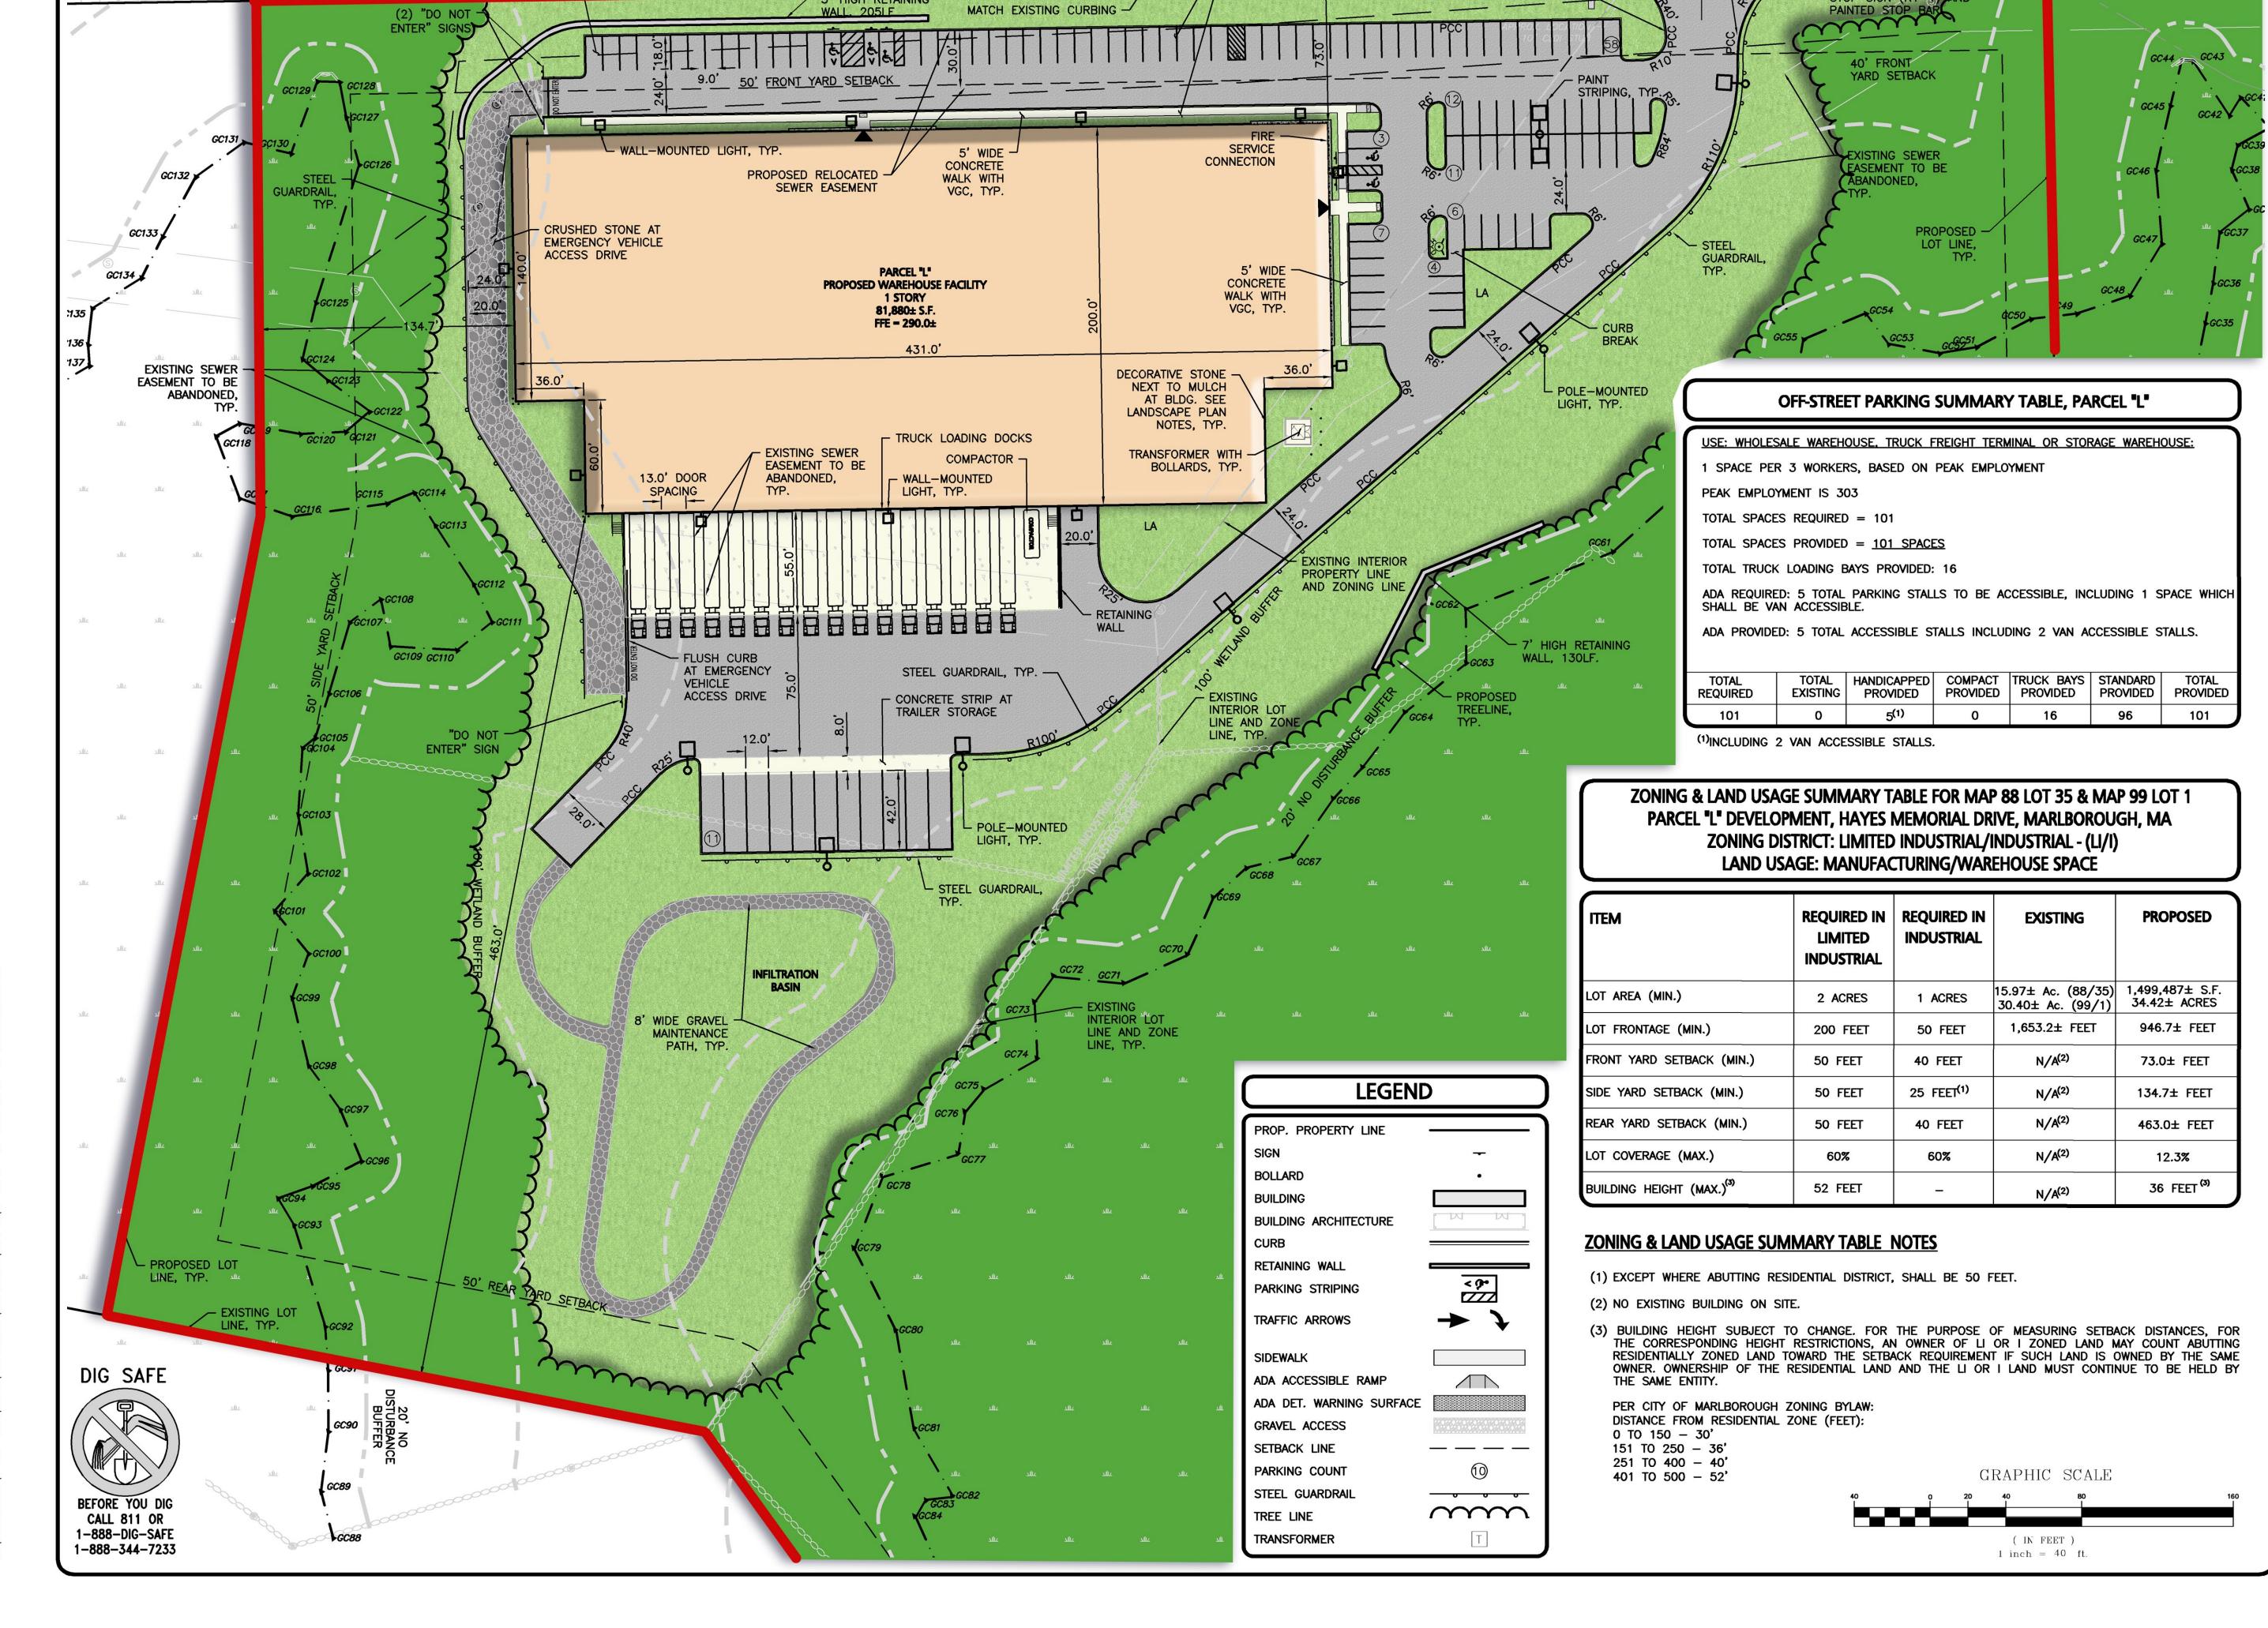

HAYES MEMORIAL DRIVE

(PUBLIC — 60' WIDE)

- MATCH EXISTING (1960 COUNTY LAYOUT — f.k.a. STIRRUP BROOK HIGHWAY)

VEHICULAR

TURN-AROUND


VGC AT CURB

RETURN, TYP.

- MONUMENT SIGN

ADA PAINT STRIPING &

VGC AT CURB RETURN, TYP.

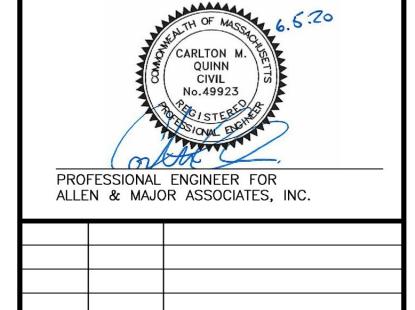

2020-06-05 REVISED PER CITY COMMENTS 2020-05-04 REVISED FOR SITE PLAN REVIEW DATE DESCRIPTION **REV** 

APPLICANT\OWNER:

THE GUTIERREZ COMPANY 200 SUMMIT DRIVE, SUITE 400 **BURLINGTON, MA 01803** 

PROJECT:

PARCEL L DEVELOPMENT **HAYES MEMORIAL DRIVE** MARLBOROUGH, MA

PROJECT NO.	1145-10A	DATE:	04/17/2020
SCALE:	1 <b>" -</b> 40¹	DWG. NAME:	C-1145-10A
DESIGNED BY:	DMR/SJL	CHECKED BY:	СМQ



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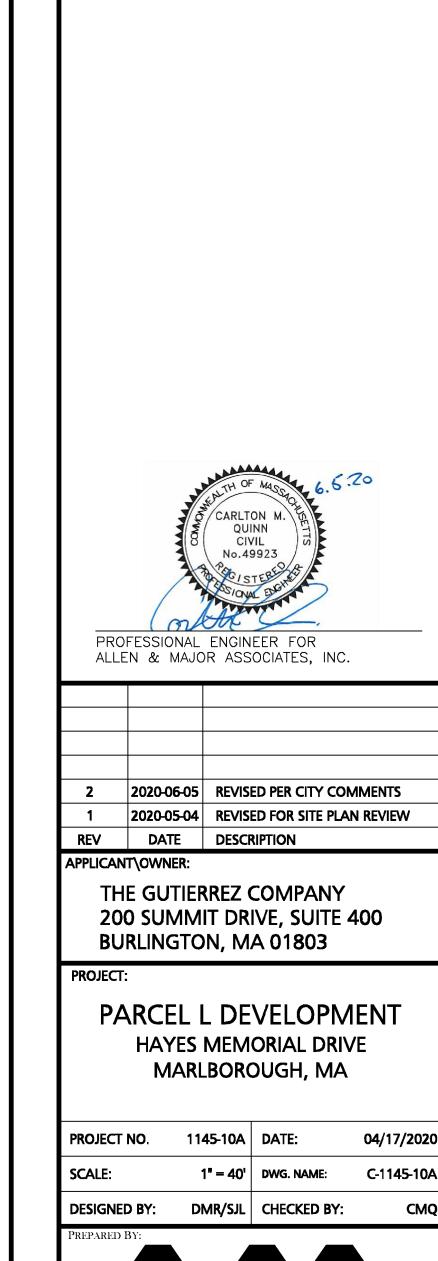
**DRAWING TITLE:** 

LAYOUT & MATERIALS PLAN | C-102

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SHEET No.

HAYES MEMORIAL DRIVE



ALLEN & MAJOR ASSOCIATES, INC.'S WORK PRODUCT. SHEET No. **DRAWING TITLE:** 

GRADING & DRAINAGE PLAN | C-103

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PROPOSED GAS SERVICE SHOWN

FOR COORDINATION PURPOSES

DETERMINE FINAL LOCATION, SIZE

PROPOSED SEWER MANHOLE -

 $INV.IN=278.3\pm(BUILDING)$ 

387 LF, 24"ø SDR 35 PVC

HAYES MEMORIAL DRIVE

(PUBLIC - 60' WIDE)

(1960 COUNTY LAYOUT - f.k.a. STIRRUP BROOK HIGHWAY)

30' WIDE

EASEMENT

PARCEL "L"

PROPOSED WAREHOUSE FACILITY

1 STORY

81,880± S.F.

FFE = 290.0±

RELOCATION

PROPOSED SEWER

PROPOSED SEWER MANHOLE

PROPOSED SEWER MANHOLE

INV.IN/OUY=270.4± 50LF, 24"ø SDR 35 PVC

SMH-02 RIM=288.5±

S=0.15%

SMH-03

S=0.15%

 $RIM = 287.07 \pm$ 

 $RIM = 287.0 \pm$ 

 $INV.IN/OUT=270.3\pm$ 

76LF, 24"ø SDR 35 PVC

EXISTING SEWER MANHOLE

 $INV.IN/OUT=270.1\pm(EX.)$ 

CORE HOLE FOR 24" INLET

GC128

GC127

GC126

GC123

GC121

 $IN/OUT(BC)=271.0\pm$ 

 $RIM = 289.0 \pm$ 

S=0.15%

35LF, 8" PVC, ~

SEWER SERVICE -

INV.=279.0±

S=2.00%

ONLY. GAS PROVIDER TO

GAS METER/SERVICE -

4" DOMESTIC WATER SERVICE -

TRANSFORMER WITH -

**ELECTRIC SERVICE -**

BOLLARDS INSTALLED PER SERVICE PROVIDER, TYP.

TELE/DATA SERVICE ·

WITH 4" GATE VALVE

6" FIRE SERVICE .

WITH 6" PIV

AND MATERIAL OF SERVICE.

- INSTALL RISER CONNECTION ON EXISTING UTILITY POLE FOR PRIMARY

PROVIDER SPECIFICATION). RUN ELECTRIC & TELE-DATA UNDERGROUND

TO TRANSFORMER AS SHOWN. SERVICE PROVIDER TO DETERMINE FINAL

- WATERLINE REDUCER

45° BEND WITH

THRUST BLOCK

CONNECT PROPOSED 8" CLDI

WATER SERVICE TO EXISTING

GATE VALVE AS SHOWN.

THE MARLBOROUGH DPW.

10" STUB WITH REDUCER AND

COORDINATE INSTALLATION WITH

MAN TO THE

 $RIM = 288.46 \pm (EX.)$ 

 $IN/OUT=271.5\pm(BC)$ 

 $INV.IN=279.2\pm(a)$ 

ELECTRIC & TELECOMMUNICATIONS CONNECTIONS (PER SERVICE

LOCATION, SIZE AND MATERIAL OF SERVICE.

8" CLDI WATERLINE

HYDRANT WITH


6" GATE VALVE

EASEMENT TO BE RELOCATED

VALVE



— онw —

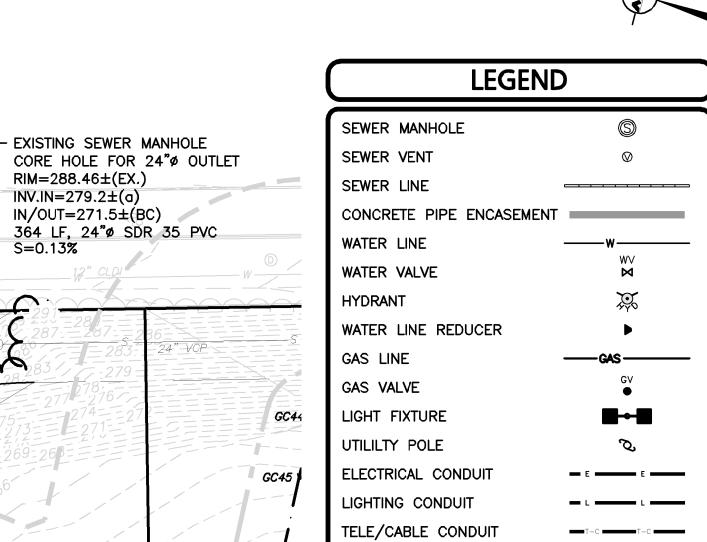


1. THE LOCATIONS OF EXISTING UNDERGROUND UTILITIES ARE SHOWN IN AN APPROXIMATE WAY ONLY AND HAVE NOT BEEN INDEPENDENTLY VERIFIED BY THE OWNER OR IT'S REPRESENTATIVE. THE CONTRACTOR SHALL DETERMINE THE EXACT LOCATION OF ALL EXISTING UTILITIES BEFORE COMMENCING WORK, AND AGREES TO BE FULLY RESPONSIBLE FOR ANY AND ALL DAMAGES WHICH MIGHT BE OCCASIONED BY THE CONTRACTOR'S FAILURE TO EXACTLY LOCATE AND PRESERVE ANY AND ALL UNDERGROUND UTILITIES.

OVERHEAD WIRE

- BUILDING SEWER SERVICE LOCATIONS TO BE BASED ON FINAL BUILDING PLANS. CONNECTION POINTS SHALL BE AS SHOWN HEREON.
- PIPE DIMENSIONS ARE MEASURED FROM THE INSIDE FACE OF THE STRUCTURE.
- 4. NATURAL GAS DISTRIBUTION SHOWN HEREON ARE FOR COORDINATION PURPOSES ONLY. FINAL LAYOUT TO BE COORDINATED WITH UTILITY PROVIDER.
- THE INFORMATION SHOWN ON THIS PLAN IS THE SOLE PROPERTY OF ALLEN & MAJOR ASSOCIATES INC. IT'S INTENDED USE IS TO PROVIDE INFORMATION. ANY ALTERATION, MISUSE, OR RECALCULATION OF INFORMATION OR DATA WITHOUT THE EXPRESSED, WRITTEN CONSENT OF ALLEN & MAJOR ASSOCIATES, INC. IS STRICTLY PROHIBITED.
- 6. ALL TRENCH WORK IN HAYES MEMORIAL DRIVE SHALL BE FILLED WITH FLOWABLE FILL.
- WHEN WATER AND SEWER CROSSINGS ARE LESS THAN 18" VERTICAL AND/OR LESS THAN 10 HORIZONTAL, THE CROSSING SHALL BE ENCASED IN CONCRETE WITH FLOWABLE FILL.
- 8. SEWER INSTALLATION SHALL BE IN COMPLIANCE WITH THE CITY OF MARLBOROUGH ZONING BYLAWS CHAPTER 510 SEWERS AND MA DEP REVIEW OF SEWER LINE / WATER SUPPLY PROTECTION POLICY #: BRP/DWM/WS/P03-1.
- 9. ALL SEWER LINES AND APPURTENANCES SHALL BE DESIGNED AND CONSTRUCTED FOR MAXIMUM WATERTIGHTNESS.
- 10. SEWERS SHALL BE TESTED BY APPROVED METHODS WHICH WILL ACHIEVE TEST RESULTS FOR INFILTRATION AND EXFILTRATION OF LESS THAN 100 GALLONS / INCH DIAMETER / MILE / 24
- 11. A MINIMUM OF CLASS B BEDDING AS DEFINED BY WATER POLLUTION CONTROL FEDERATION (WPCF  $\mathsf{MOP} = \# \ 9$ ) MANUAL OF PRACTICE NO. 9 — SEWER DESIGN AND CONSTRUCTION MUST BE USED FOR ALL PIPING.
- 12. SEWER CONNECTIONS (LATERALS AND HOUSE CONNECTIONS) SHALL BE RIGIDLY INSPECTED BY THE CITY OF MARLBOROUGH DPW AND CERTIFIED INSPECTION REPORTS SHALL BE SUBMITTED TO THE MA DEP.
- 13. APROXIMATE LOCATION OF FIRE DEPARTMENT KNOX BOX. PER MARLBOROUGH FIRE DEPARTMENT, KNOX BOXES TO CONTAIN ALL KEYS, INCLUDING: ENTRY KEYS, FIRE ALARM PANEL KEYS, RADIO BOX KEYS, SPRINKLER BOX KEYS, ETC. CONTRACTOR TO COORDINATE WITH ARCHITECT AND MARLBOROUGH FIRE DEPARTMENT FOR EXACT LOCATION ON OUTSIDE OF BUILDING.
- 14. PER MARLBOROUGH FIRE DEPARTMENT, FIRE DEPARTMENT CONNECTION IS TO BE A 4" DIA., STORTZ STYLE, WITH A 30 DEGREE DOWN ANGLE. CONTRACTOR TO COORDINATE WITH MEP ENGINEER.
- 15. PER MARLBOROUGH FIRE DEPARTMENT, FIRE ALARM MASTER RADIO BOX TO BE LOCATED I CLUBHOUSE BUILDING. CONTRACTOR TO COORDINATE WITH MARLBOROUGH FIRE DEPARTMENT ARCHITECT, AND MEP ENGINEER FOR LOCATION AND REQUIRMENTS. PER MARLBOROUGH FIRE DEPARTMENT, FIRE ALARM MASTER RADIO BOX TO BE A 16 ZONE BOX, EITHER KING FISHER RADIO BOX FROM MAMMOTH FIRE COMPANY OR DIGITIZE RADIO BOX FROM RB ALLEN COMPANY. THERE ARE 4 RESIDENTIAL BUILDINGS AND THE CLUBHOUSE BUILDING WITH THE FOLLOWING RADIO BOX ZONE BREAKDOWNS: 1 ZONE PER BUILDING FOR FIRE ALARM NOTIFICATION, 1 ZONE PER BUILDING FOR WATER FLOW, 1 ZONE PER BUILDING FOR CARBON MONOXIDE ALARM.
- 16. REFERENCE PLUMBING PLANS FOR FIRE DEPARTMENT CONNECTIONS AT BUILDINGS.
- 17. ALL HYDRANT BRANCHES SHALL BE SIX (6) INCH CAST IRON.
- 18. SEE DETAIL SHEET(S) FOR ADDITIONAL CITY OF MARLBOROUGH SEWER AND WATER NOTES.
- 19. CITY OF MARLBOROUGH STANDARDS REQUIRES SEWER MAINS GREATER THAN 10' DEPTH TO BE DUCTILE IRON.
- 20. THE CONTRACTOR SHALL OBTAIN A STREET OPENING PERMIT PRIOR TO ANY CONSTRUCTION WITHIN THE CITY RIGHT-OF-WAY.
- 21. ALL WATER AND SEWER MATERIAL AND CONSTRUCTION SHALL CONFORM TO CITY OF MARLBOROUGH REQUIREMENTS (SEE STREET OPENING PERMIT).
- 22. ALL WATER AND SEWER CONSTRUCTION SHALL BE INSPECTED BY THE CITY OF MARLBOROUGH BEFORE BACKFILLING.
- 23. THE CITY SHALL BE NOTIFIED AT LEAST 24 HOURS PRIOR TO THE REQUIRED INSPECTIONS.

( IN FEET ) 1 inch = 40 ft.

GRAPHIC SCALE

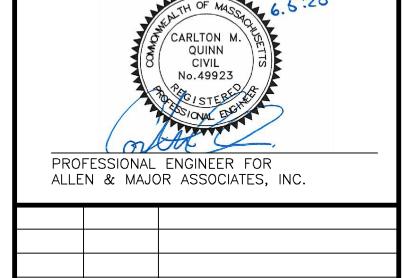

2020-06-05 REVISED PER CITY COMMENTS 2020-05-04 REVISED FOR SITE PLAN REVIEW

DATE DESCRIPTION REV APPLICANT\OWNER:

> THE GUTIERREZ COMPANY 200 SUMMIT DRIVE, SUITE 400 **BURLINGTON, MA 01803**

PROJECT:

PARCEL L DEVELOPMENT HAYES MEMORIAL DRIVE MARLBOROUGH, MA

PROJECT NO.	1145-10A	DATE:	04/17/2020
SCALE:	1" = 40'	DWG. NAME:	C-1145-10A
DESIGNED BY:	DMR/SJL	CHECKED BY:	CMQ



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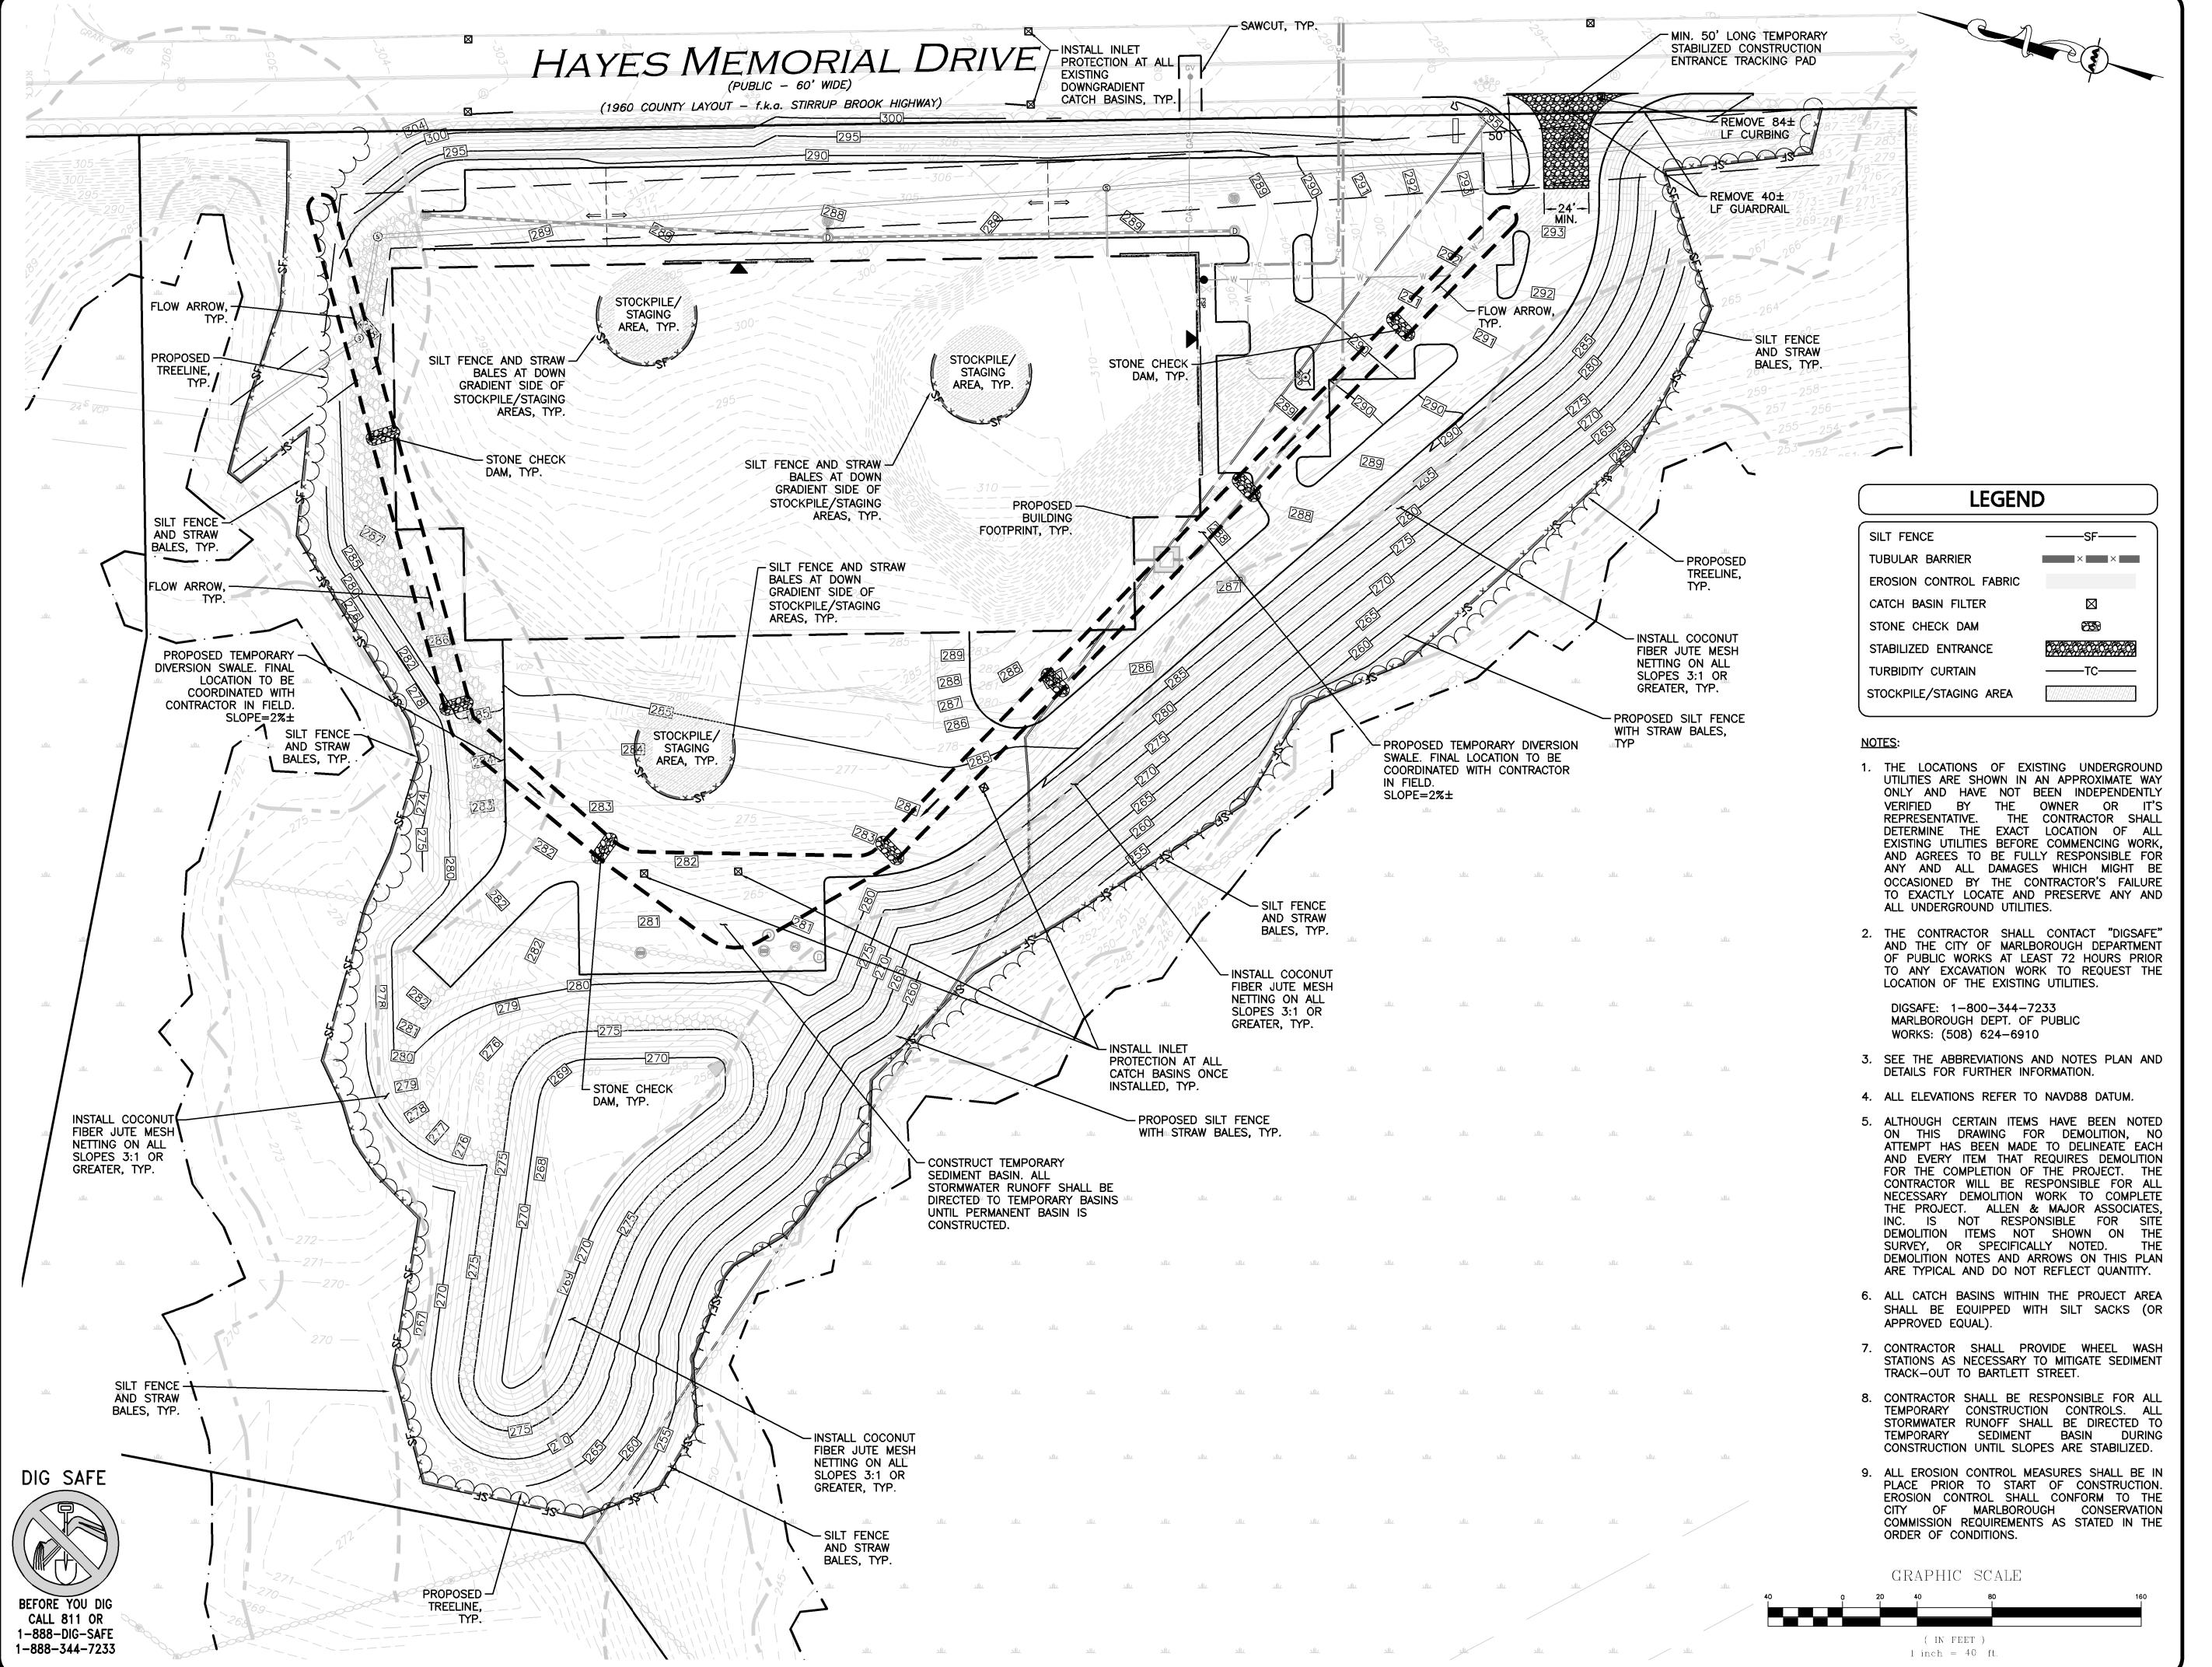
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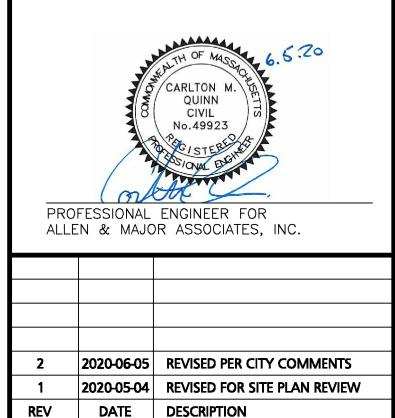
DRAWING TITLE:

SHEET No.

C-104

**UTILITIES PLAN** 





200 SUMMIT DRIVE, SUITE 400 BURLINGTON, MA 01803

THE GUTIERREZ COMPANY

PROJECT:

APPLICANT\OWNER:

PARCEL L DEVELOPMENT HAYES MEMORIAL DRIVE MARLBOROUGH, MA

PROJECT NO. 1145-10A DATE: 04/17/2020 1" = 40' DWG. NAME: C-1145-10A DMR/SJL | CHECKED BY: DESIGNED BY:



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DRAWING TITLE:

C-101 **EROSION CONTROL PLAN** 

SHEET No.

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#### GENERAL LAWN MIX

6" LOAM & SEED ─

FOR AREAS

BLDG.

GENERAL LAWN MIX

DIRECTLY NEXT TO

APPROXIMATE LIMIT

OF TREE CLEARING

REMAIN, TYP. SEE

GRADING PLAN FOR

ALIMITS OF

FOR OUTSIDE PERIMETER OF LOT.

PATHS, RIPRAP OR MOWED LAWN

AND ARE 2:1 SLOPE OR LESS, 6"

RESTORATION MIX FOR DRY SITES.

TYP. SEE NOTE 22 ON L-102 &

AREAS THAT ARE NOT STONE

LOAM & SEED AT DISTURBED

AREAS. USE NEW ENGLAND

EROSION CONTROL

SEED SPEC. ON PLAN

(UNMOWED).

RE-GRADING.

SCIENTIFIC NAME	COMMON NAME BY WEIGHT	<u>PROPORTION</u>	PERCENT <u>PURITY</u>	PERC GERM
FESTUCA RUBRA "RUBRA"	CREEPING RED FESCUE	37%	95%	90%
PAO PRAENTENSIS "BARON"	BARON KENTUCKY BLUEGRASS	40%	85%	90%
LOLIUM PERENNE "PALMER"	PALMER PERENNIAL RYEGRASS	15%	95%	90%
FESTUCA RUBRA COMMUTATA WILMA	WILMA CHEWINGS	8%	95%	80%

FOR OUTSIDE PERIMETER OF LOT,

THAT ARE 2:1 SLOPE OR LESS, 6" LOAM & SEED AT DISTURBED AREAS.

USE NEW ENGLAND EROSION CONTROL

RESTORATION MIX FOR DRY SITES,

TYP. SEE NOTE 22 ON L-102 &

SEED SPEC. ON PLAN (UNMOWED)

1. SEED TO BE SPREAD AT MINIMUM RATE OF 5 LBS. PER 1000 SQ. FT.

HAYES MEMORIAL DRIVE

12 SA

6" LOAM & SEED

GENERAL LAWN MIX

FOR AREAS

DIRECTLY NEXT TO

BLDG.

PARCEL "L"

PROPOSED WAREHOUSE FACILITY

1 STORY

81,880± S.F.

FFE - 290.0±

6" LOAM & SEED GENERAL LAWN MIX -

FOR AREAS DIRECTLY NEXT TO BLDG.

ALL SEEDING (INCLUDING NEW ENGLAND WETLAND MIX SEEDS) TO BE COMPLETED "IN SEASON" BETWEEN APRIL 1 TO JUNE 15 OR AUGUST 15 TO OCTOBER 1, EXCEPT FOR RE-SEEDING OF BARE SPOTS. AT ALL SLOPED AREAS CONTRACTOR TO INSTALL COCONUT FIBER JUTE MESH NETTING ON ALL SLOPES 3:1 AND OVER, HYDROSEED ALL EXPOSED AREAS, ADD SOIL STABILIZER "FLUX TERRA HP-FGM SOIL STABILIZER" AS MANUFACTURED BY "PROFILE" TO HYDROSEED (AT RATE OF 3,000 LBS PER ACRE), AT NO ADDITIONAL COST TO THE OWNER. CONTRACTOR TO ALSO BE RESPONSIBLE FOR RE-GRADING AND RE-SEEDING ALL DISTURBED, ERODED, OR BARE SPOTS AT NO ADDITIONAL COST TO OWNER & UNTIL SLOPES ARE FULLY STABLE. CONTRACTOR RESPONSIBLE FOR ALL MAINTENANCE UNTIL FINAL ACCEPTANCE OF LAWN AREAS INCLUDING: WATERING, ADDING FERTILIZERS AND LIME AND MOWING AT NO ADDITIONAL COST TO OWNER. AFTER SEEDING, SEEDED AREAS TO BE LIGHTLY MULCHED WITH WEED FREE STRAW & CONTINUALLY WATERED EVERY DAY FOR 2 MONTHS (USE NO HAY) SO THAT SEED IS KEPT MOIST.

3. COMMERCIAL FERTILIZER SHALL BE APPLIED AT THE RATE OF 25 POUNDS PER 1000 SQ. FT. OR AS RECOMMENDED BY THE TESTING AGENCY. LIME TO BE SPREAD AT THE RATE OF 100 POUNDS PER 1000 SQ. FT OR AS RECOMMENDED BY THE TESTING AGENCY. COMMERCIAL FERTILIZER SHALL BE A COMPLETE FERTILIZER CONTAINING AT LEAST 50% OF THE NITROGEN OF WHICH IS DERIVED FROM NATURAL ORGANIZE SOURCES OF UREAFORM. IT SHALL CONTAIN THE FOLLOWING PERCENTAGES BY WEIGHT: NITROGEN (N) 10%, PHOSPHORUS (P) 6%, POTASH (K) 4%. LIME SHALL BE AN APPROVED AGRICULTURAL LIMESTONE CONTAINING NOT LESS THAN 85% OF TOTAL CARBONATES. LIMESTONE SHALL BE GROUND TO SUCH FINENESS THAT 50% WILL PASS A 100 MESH SIEVE AND 90% WILL PASS THROUGH A 20 MESH SIEVE.

4. LAWN AREAS TO BE SEEDED BY SOWING EVENLY WITH AN APPROVED MECHANICAL SEEDER AT THE RATE OF TEN POUNDS PER 1000 SQUARE FEET.

CONTRACTOR RESPONSIBLE FOR WATERING, MOWING, AND RESEEDING OF LAWN BARE SPOTS UNTIL A UNIFORM, HEALTHY STAND OF GRASS IS ESTABLISHED AND ACCEPTED.

18" WIDTH OF DECORATIVE -

— 21 FL

- 2 MDĎ

1 AG

ZONING REQUIREMENT:

SECTION 650-47

LANDSCAPING AND SCREENING

DECIDUOUS SHADE TREES MIN. 2" CAL.

E. STREET FRONTAGE PLANTING AREA

ADJACENT TO STREET ROW WITH A MIN.

D. (5) PLANTING QUANTITY & SPACING

AT LEAST 1 SHRUB PER 5 LINEAR FT.

OR 35 S.F. OF GROUND WHICHEVER IS

MIN. 1 TREE PER 40 LINEAR FT. OF

50% OF SHRUBS IN FRONTAGE MAY

I. PARKING LOT PLANTING AREA

(1) PERIMETER PARKING LOT. ON AT

LEAST THREE SIDES THERE SHALL BE A

LANDSCAPE STRIP WITH REQUIRED SIDE

LINE PLANTING AREAS UNDER SECTION I

H. (2)(B) INTERIOR OF PARKING LOT

MIN 3% OF PARKING AREA W/>50

LANDSCAPED ISLANDS MIN 7' WIDE

H. (2)(B) A MIN. OF 1 TREE & 4

INTERIOR OF THE PARKING LOT.

SHRUBS FOR EVERY 12 CARS IN THE

SPACES, MUST BE PLANTED AS

PLANTING AREA LENGTH.

BE SUBSTITUTED FOR LAWN.

D. (4) PLANTING TYPE AND SIZE

CONTINUOUS LANDSCAPED STRIP

WIDTH OF 15 FT. WITH PLANTINGS.

& SHRUBS 12" HT.

GREATER.

LOAM & SEED GENERAL LAWN

HH & 12 EC

STONE REQUIRED BETWEEN BLG.

& ALL MULCH BEDS, TYP. SEE

NOTE #19 & DETAIL ON L-102.

\_\_\_ 21 FL \_\_\_ 2 BN

FOR OUTSIDE PERIMETER OF LOT, AREAS

MOWED LAWN AND ARE 2:1 SLOPE OR

LESS, 6" LOAM & SEED AT DISTURBED

CONTROL / RESTORATION MIX FOR DRY

SITES, TYP. SEE NOTE 22 ON L-102 &

" LOAM & SEED BOTTOM, TOP, & SIDE

AREAS. USE NEW ENGLAND EROSION

SEED SPEC. ON PLAN (UNMOWED).

SLOPES OF BASIN WITH BOTH NEW

NEW ENGLAND EROSION CONTROL /

NOTE #22 ON SHEET L-102 & SEED

SPECIFICATIONS ON L-101. IMPORTANT TO GRADE & SEED AT EARLY STAGE IN

CONSTRUCTION TO ALLOW SEED MIN. (

PRIOR TO DISCHARGING STORMWATER.

MONTHS TO ESTABLISH & MIN. EROSION

ENGLAND EROSION CONTROL MIX FOR

DETENTION BASINS & MOIST SITES AND

RESTORATION MIX FOR DRY SITES. SEE

THAT ARE NOT STONE PATHS, RIPRAP OR

#### ADDITIONAL SEED MIX SPECIFICATIONS FOR SLOPES AREAS (AS NOTED ON THE PLAN):

#### SEE NOTE #22 ON SHEET L-102 FOR RATE OF APPLICATION & ADDITIONAL INFORMATION

WWW.NEWP.COM OR

0 0000

Ph: (413) 548-8000 | Fx: (413) 549-4000 | info@newp.com New England Wetland Plants, Inc. 820 West Street

Amherst, MA 01002

- NEW ENGLAND EROSION CONTROL / RESTORATION MIX FOR DRY SITES (BY NEW ENGLAND WETLAND PLANTS INC.):
- 1. UPLAND BENTGRASS 2. ROUGH BENTGRASS/TICKLEGRASS
- BLUE GRAMA CANADA WILD RYE
- CREEPING RED FESCUE 6. ANNUAL RYEGRASS (NATURALIZED)

— 15 SA & 15 AN

— 15 HH & 15 EC

- PERRENIAL RYEGRASS (NATURALIZED) 8. LITTLE BLUESTEM 9. INDIAN GRASSS
- AGROSTIS SCABRA **BOUTELOUA GRACILIS ELYMUS CANADENSIS** FESTUCA RUBRA LOLIUM MULTIFLORUM LOLIUM PERENNE SCHIZACHYRIUM SCOPARIUM

SORGHASTRUM NUTANS

- FOR OUTSIDE PERIMETER

RIPRAP OR MOWED LAWN

AND ARE 2:1 SLOPE OR

LESS, 6" LOAM & SEED

AT DISTURBED AREAS.

RESTORATION MIX FOR

NOTE 22 ON L-102 &

SEED SPEC. ON PLAN

APPROXIMATE LIMIT OF

TREE CLEARING & EXIST.

TREES TO REMAIN, TYP. SEE GRADING PLAN FOR

LIMITS OF RE-GRADING.

PROVIDED

PROVIDED TREES & SHRUBS ARE AT

LEAST 2" CAL. AND 12" HT. OR

GREATER

STREET FRONTAGE LANDSCAPING IS

GREATER THAN 15 FT. WIDE AT

& SHRUB PLANTINGS.

18 TREES PROVIDED

101 NEW SHRUBS PROVIDED.

ADDITIONAL SHRUBS PROVIDED

THROUGH EXISTING WOODED AREAS

GREATER THAN 7 FT. PLANTING STRIPS

ON FRONT, SIDE, & REAR OF LOT.

ADDITIONAL EXIST. TREES & SHRUBS

WITHIN WOODS TO REMAIN AT SIDES &

REAR OF LOT.

GREATER THAN 10% IS PROVIDED

9 TREES PROVIDED

ALONG FRONTAGE TO REMAIN.

24 FT. OR GREATER WITH BOTH TREE

(UNMOWED).

6" LOAM &

SEED

CITY OF MARLBOROUGH LANDSCAPE REGULATIONS

REQUIRED

REQUIREMENT

AS NOTED

THERE IS APPROX. 665 LF

OF FRONTAGE LANDSCAPED

PARKING) NOT WOODED OR

AREA (BETWEEN ROW &

UTILIZED FOR VEHICULAR

 $728 \text{ LF} \pm /40 = 18 \text{ TREES}$ 

 $728 \text{ LF} \pm /5 = 146 \text{ SHRUBS}$ 

420 SHRUBS REQUIRED AS

LARGER THAN 146 SHRUBS

REDUCING FRONTAGE SHRUBS

BY 50% AND REPLACING WITH

LAWN=210 SHRUBS REQUIRED

FOR NON-RES. USES

A MIN. 7 FT. SIDELINE

PLANTING AREA STRIP

IS REQUIRED.

REQUIREMENT

AS NOTED

101 STALLS/ 12 =8 TREES

101 CARS/ 12X4=34

34 SHRUBS REQUIRED

REQUIRED

 $14,700 \text{ S.F.} \pm / 35 =$ 

ENTRANCES.

REQUIRED

GENERAL

LAWN MIX

DRY SITES, TYP. SEE

USE NEW ENGLAND

EROSION CONTROL

NOT STONE PATHS.

AGROSTIS PERENNANS

(BY NEW ENGLAND WETLAND PLANTS INC:) EROSION CONTROL/RESTORATION MIX FOR DETENTION BASINS AND MOIST SITES


- A. ELYMUS VIRGINICUS
- B. FESTUCA RUBRA **FESCUE** C. SCHIZACHYRIUM SCOPARIUM
- ANDROPOGON GERARDII PANICUM VIRGATUM VERBENA HASTATA AGROSTIS SCABRA
- ASTER NOVAE-ANGLIAE EUPATORIUM MACULATUM
- EUPATORIUM PERFOLIATUM K. JUNCUS EFFUSUS L. SCIRPUS CYPERINUS

VIRGINIA WILD RYE CREEPING RED

LITTLE BLUESTEM BIG BLUESTEM SWITCH GRASS BLUE VERVAIN **ROUGH BENTGRASS** NEW ENGLAND ASTER SPOTTED JOE PYE WEED **BONESET** SOFT RUSH


WOOL GRASS




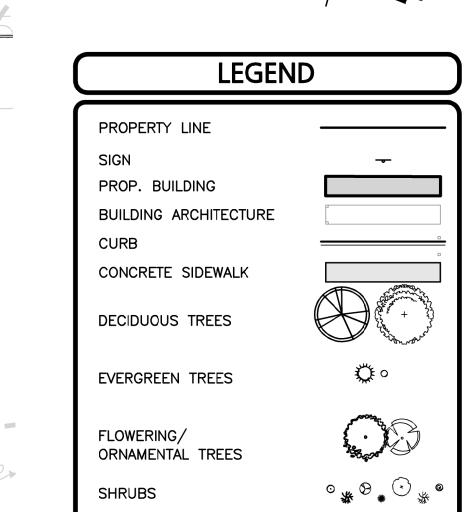

### **GENERAL NOTES:**


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- ALL LANDSCAPED AREAS WITH SHRUBS, TREES, AND PERENNIALS TO HAVE 18" MINIMUM DEPTH OF TOPSOIL. EIGHTEEN INCHES OF TOPSOIL AROUND TREES AND SHRUBS DOES TREE / SHRUB PIT FOR FULL DEPTH OF ROOTBÁLLS. SEE PLANTING DETAILS FOR PLANTING DEPTH AT SHRUBS AND TREES. SOD TO HAVE 6" MINIMUM DEPTH OF TOPSOIL. TOPSOIL TO BE TESTED BY CONTRACTOR, AND OR PLACEMENT. GENERAL CONTRACTOR, DEMOLITION CONTRACTOR, AND LANDSCAPE CONTRACTOR TO COORDINATE PROPER DEPTH OF EXISTING MATERIAL REMOVAL ACROSS SITE SO THAT 18" MINIMUM AND 6" MINIMUM DEPTHS OF PROPOSED TOPSOIL NOTED ABOVE ARE MET AT NO ADDITIONAL COST TO OWNER.
- SEE SHEET L-102 FOR ADDITIONAL LANDSCAPE NFORMATION.

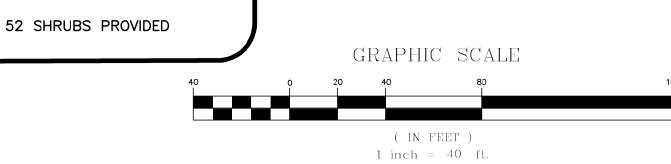

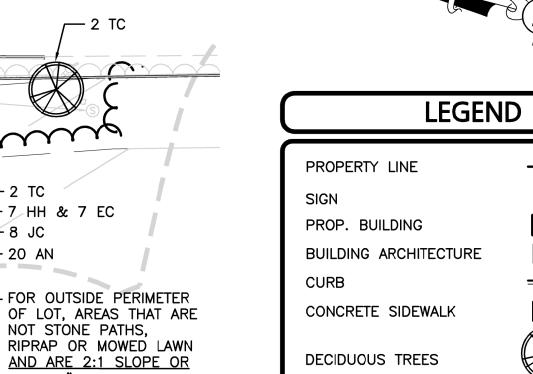

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- NOT INCLUDE AMENDED PLANTING SOIL WITHIN ALL AREAS OF LOAM AND SEED OR LOAM & APPROVED BY A&M PRIOR TO PURCHASE AND SEE TOPSOIL DETAIL.

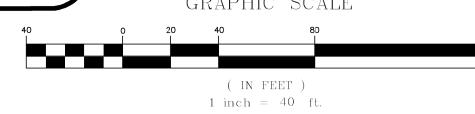

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REGISTERED (ANDSCAPE ARCHITECT FOR

2020-06-05 REVISED PER CITY COMMENTS

2020-05-04 REVISED FOR SITE PLAN REVIEW

ALLEN & MAJOR ASSOCIATES, INC.

DATE DESCRIPTION

THE GUTIERREZ COMPANY

BURLINGTON, MA 01803

200 SUMMIT DRIVE, SUITE 400

PARCEL L DEVELOPMENT

HAYES MEMORIAL DRIVE

MARLBOROUGH, MA

1145-10A DATE:

ALLEN & MAJOR

ASSOCIATES, INC.

nvironmental consulting + landscape architectur

www.allenmajor.com

100 COMMERCE WAY, SUITE 5

WOBURN MA 01801

TEL: (781) 935-6889

FAX: (781) 935-2896

WOBURN, MA ◆ LAKEVILLE, MA ◆ MANCHESTER,

THIS DRAWING HAS BEEN PREPARED IN DIGITAL FORMA

DESIGNED BY: RB/DMR/SJL | CHECKED BY:

1"=40' DWG. NAME:

04/17/2020

C-1145-10A

REV


APPLICANT\OWNER:

PROJECT NO.

LANDSCAPE PLAN

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**DRAWING TITLE:** 

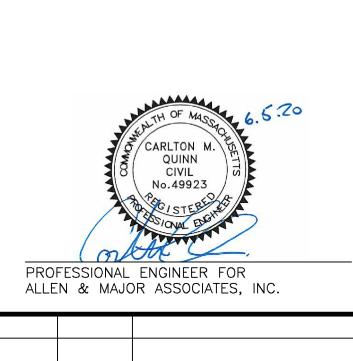

2 2020-06-05 REVISED PER CITY COMMENTS 2020-05-04 REVISED FOR SITE PLAN REVIEW DATE DESCRIPTION REV

APPLICANT\OWNER:

THE GUTIERREZ COMPANY 200 SUMMIT DRIVE, SUITE 400 **BURLINGTON, MA 01803** 

PROJECT:

PARCEL L DEVELOPMENT HAYES MEMORIAL DRIVE MARLBOROUGH, MA

PROJECT NO.	1145-10A	DATE:	04/17/202
SCALE:	1" = 40'	DWG. NAME:	C-1145-10/
DESIGNED BY:	DMR/SJL	CHECKED BY:	СМ



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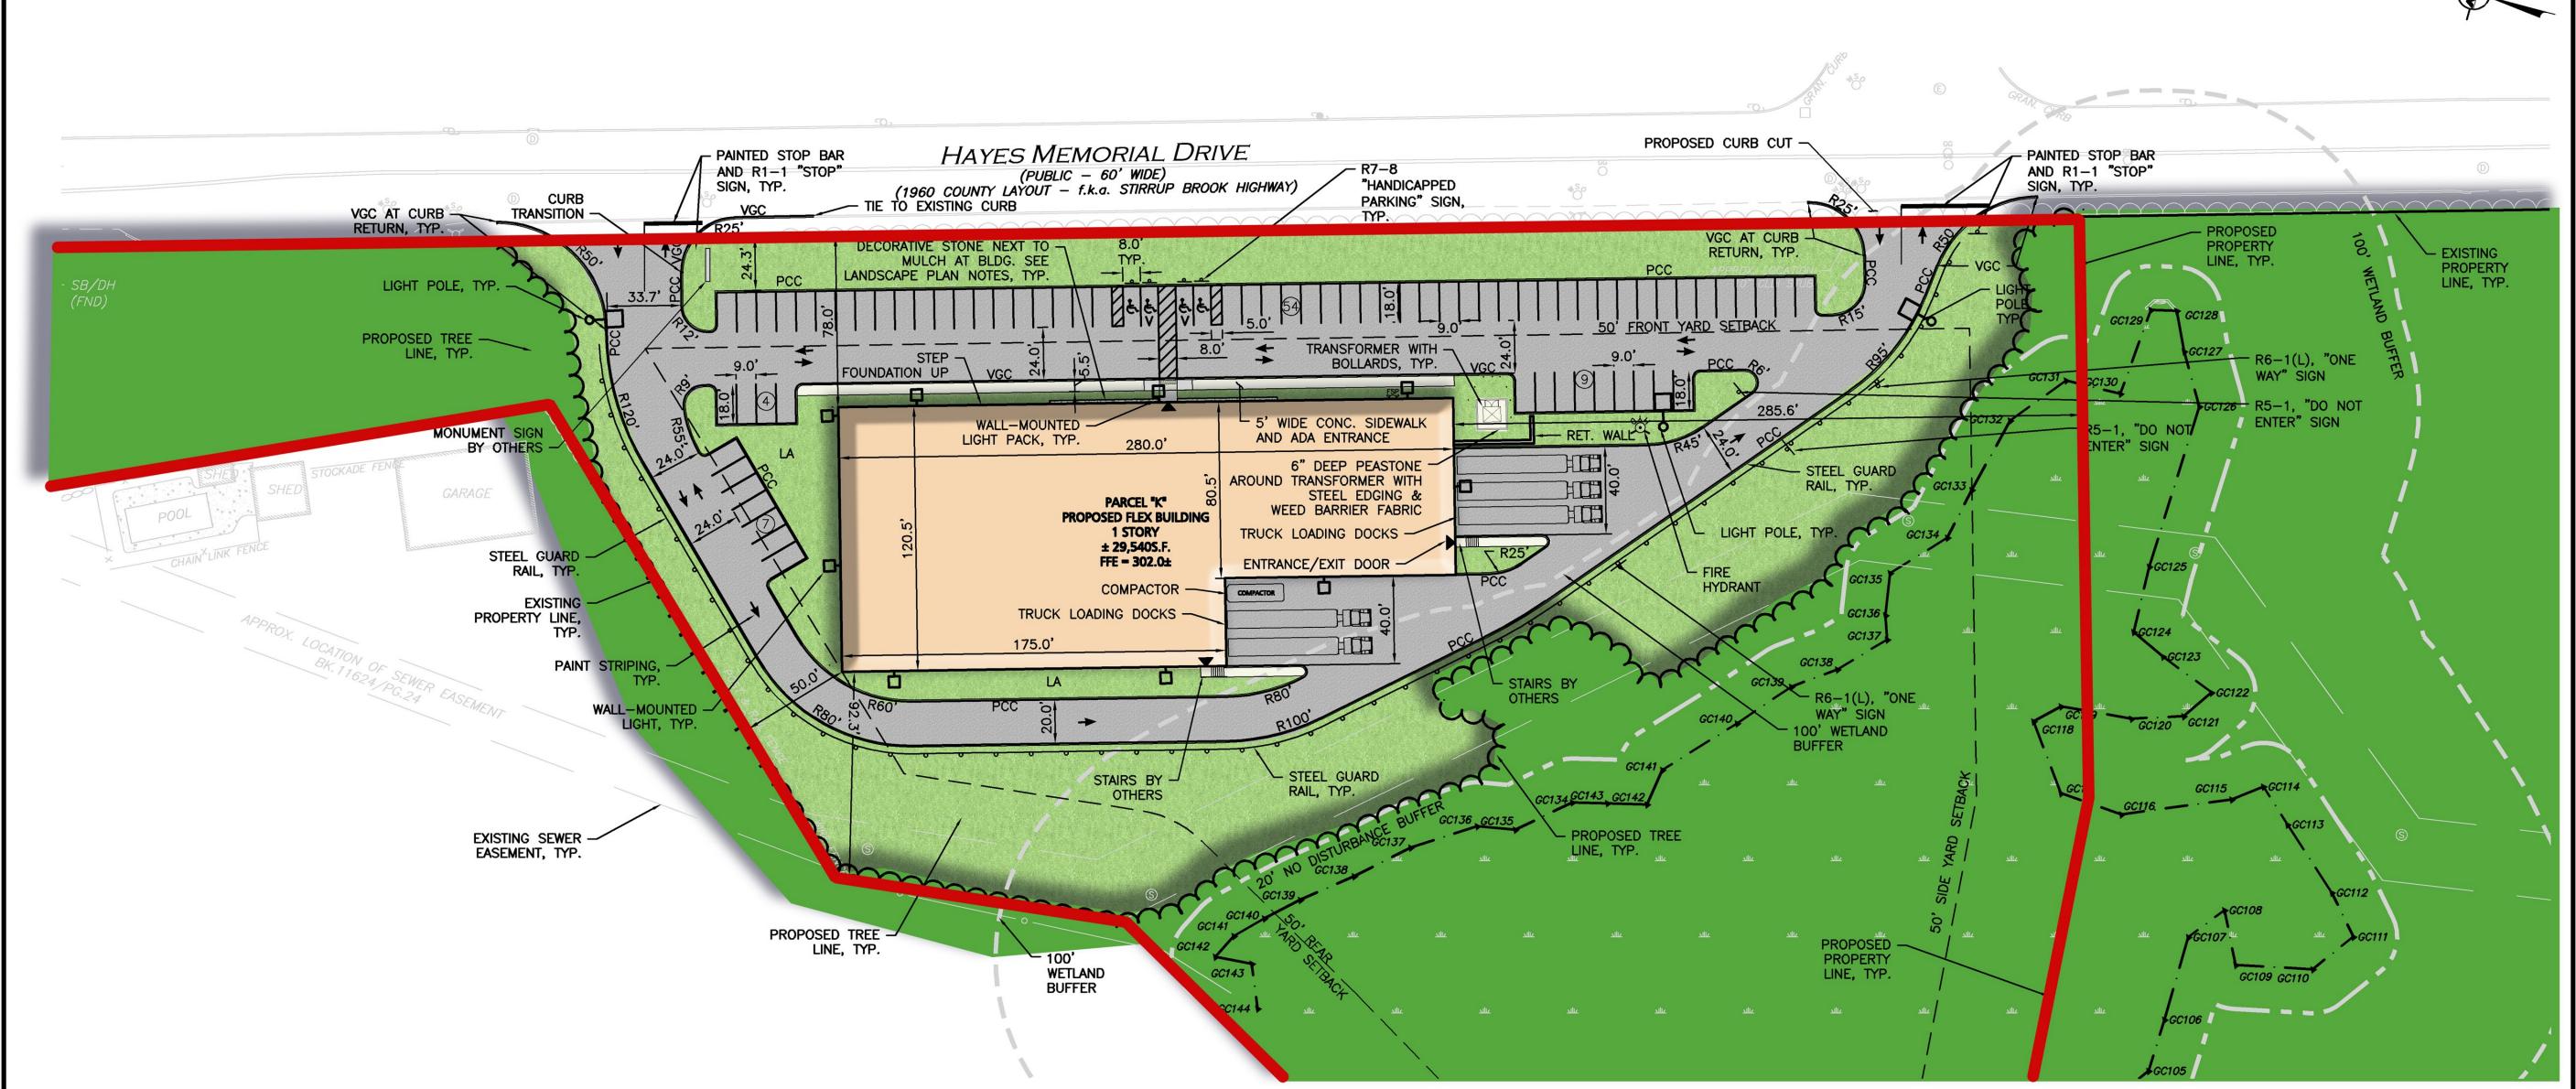
**DRAWING TITLE:** 

1 inch = 40 ft.

SHEET No. C-108

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SNOW STORAGE PLAN



**ZONING & LAND USAGE SUMMARY TABLE FOR MAP 88 LOT 35** PARCEL "K" DEVELOPMENT, HAYES MEMORIAL DRIVE, MARLBOROUGH, MA **ZONING DISTRICT: LIMITED INDUSTRIAL - (LI)** LAND USAGE: MANUFACTURING / WAREHOUSE SPACE

ПЕМ	REQUIRED	EXISTING	PROPOSED
LOT AREA (MIN.)	2 ACRES	15.97± ACRES	326,054± S.F. 7.49± ACRES
LOT FRONTAGE (MIN.)	200 FEET	1,653.2± FEET	928± FEET
FRONT YARD SETBACK (MIN.)	50 FEET	N/A <sup>(2)</sup>	78.0± FEET
SIDE YARD SETBACK (MIN.)	50 FEET	N/A <sup>(2)</sup>	50.0± FEET
REAR YARD SETBACK (MIN.)	50 FEET	N/A <sup>(2)</sup>	92.3± FEET
LOT COVERAGE (MAX.)	60%	N/A <sup>(2)</sup>	25.3%
BUILDING HEIGHT (MAX.) (3)(4)	30 FEET	N/A <sup>(2)</sup>	32 FEET <sup>(3)</sup>

#### **ZONING & LAND USAGE SUMMARY TABLE NOTES**

- (1) FRONTAGE PROVIDED ALONG HAYES MEMORIAL DRIVE.
- (2) NO EXISTING BUILDING ON-SITE.
- (3) BUILDING HEIGHT SUBJECT TO CHANGE.

(4) FOR THE PURPOSE OF MEASURING SETBACK DISTANCES, FOR THE CORRESPONDING HEIGHT RESTRICTIONS, AN OWNER OF LI OR I ZONED LAND MAY COUNT ABUTTING RESIDENTIALLY ZONED LAND TOWARD THE SETBACK REQUIREMENT IF SUCH LAND IS OWNED BY THE SAME OWNER. OWNERSHIP OF THE RESIDENTIAL LAND AND THE LI OR I LAND MUST CONTINUE TO BE HELD BY THE SAME ENTITY.

PER CITY OF MARLBOROUGH ZONING BYLAW: DISTANCE FROM RESIDENTIAL ZONE (FEET):

0 TO 150 - 30' 151 TO 250 - 36' 251 TO 400 - 40° 401 TO 500 - 52'

### OFF-STREET PARKING SUMMARY TABLE, PARCEL "K"

USE: WHOLESALE WAREHOUSE, TRUCK FREIGHT TERMINAL OR STORAGE WAREHOUSE:

1 SPACE PER 3 WORKERS, BASED ON PEAK EMPLOYMENT

PEAK EMPLOYMENT IS 222

TOTAL SPACES REQUIRED = 74

TOTAL SPACES PROVIDED = 74 SPACES TOTAL TRUCK LOADING BAYS PROVIDED: 5

ADA REQUIRED: 4 TOTAL PARKING STALLS TO BE ACCESSIBLE, INCLUDING 1 SPACE WHICH

SHALL BE VAN ACCESSIBLE.

ADA PROVIDED: 4 TOTAL ACCESSIBLE STALLS INCLUDING 2 VAN ACCESSIBLE STALLS.

TOTAL HANDICAPPED COMPACT TRUCK BAYS STANDARD **REQUIRED EXISTING** PROVIDED | PROVIDED PROVIDED PROVIDED PROVIDED 4(1) 74 0 74 (1)INCLUDING 2 VAN ACCESSIBLE STALLS.


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- 4. ALL ELEVATIONS REFER TO NAVD 88.

PROHIBITED.

- 5. ANY MINOR MODIFICATIONS (AS DETERMINED BY THE CITY ENGINEER) TO THE INFORMATION SHOWN ON THE APPROVED PLAN SETS SHALL BE SUBMITTED TO THE CITY ENGINEER AS A MINOR PLAN REVISION FOR APPROVAL PRIOR TO THE WORK BEING PERFORMED.
- 6. ANY WORK AND MATERIAL WITHIN HE CITY RIGHT-OF-WAY SHALL CONFORM TO THE CITY OF MARLBOROUGH REQUIREMENTS.
- 7. ALL HANDICAP PARKING, RAMPS, AND ACCESS SHALL CONFORM TO AAB REQUIREMENTS.
- 8. ALL PAVEMENT MARKINGS AND SIGNS SHALL CONFORM TO MUTCD REQUIREMENTS.



**LEGEND** 

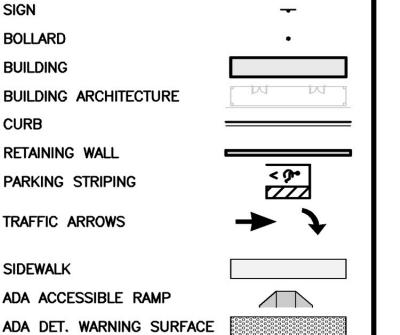PROP. PROPERTY LINE

ADA ACCESSIBLE RAMP ADA DET. WARNING SURFACE GRAVEL ACCESS SETBACK LINE \_ \_ \_ \_ 10 PARKING COUNT STEEL GUARDRAIL  $\sim$ TREE LINE TRANSFORMER

GRAPHIC SCALE ( IN FEET ) 1 inch = 40 ft.

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PROFESSIONAL ENGINEER FOR ALLEN & MAJOR ASSOCIATES, INC.

DATE DESCRIPTION

THE GUTIERREZ COMPANY

**BURLINGTON, MA 01803** 

200 SUMMIT DRIVE, SUITE 400

PARCEL K DEVELOPMENT

**HAYES MEMORIAL DRIVE** 

MARLBOROUGH, MA

1145-10A DATE:

1" = 40' DWG. NAME:

DMR/SJL | CHECKED BY:

4/17/2020

C-1145-10A

SHEET No.

**REV** 

PROJECT:

PROJECT NO.

**DESIGNED BY:** 

APPLICANT\OWNER:

2020-06-04 REVISED PER CITY COMMENTS

**DRAWING TITLE:** 

LAYOUT & MATERIALS PLAN | C-102

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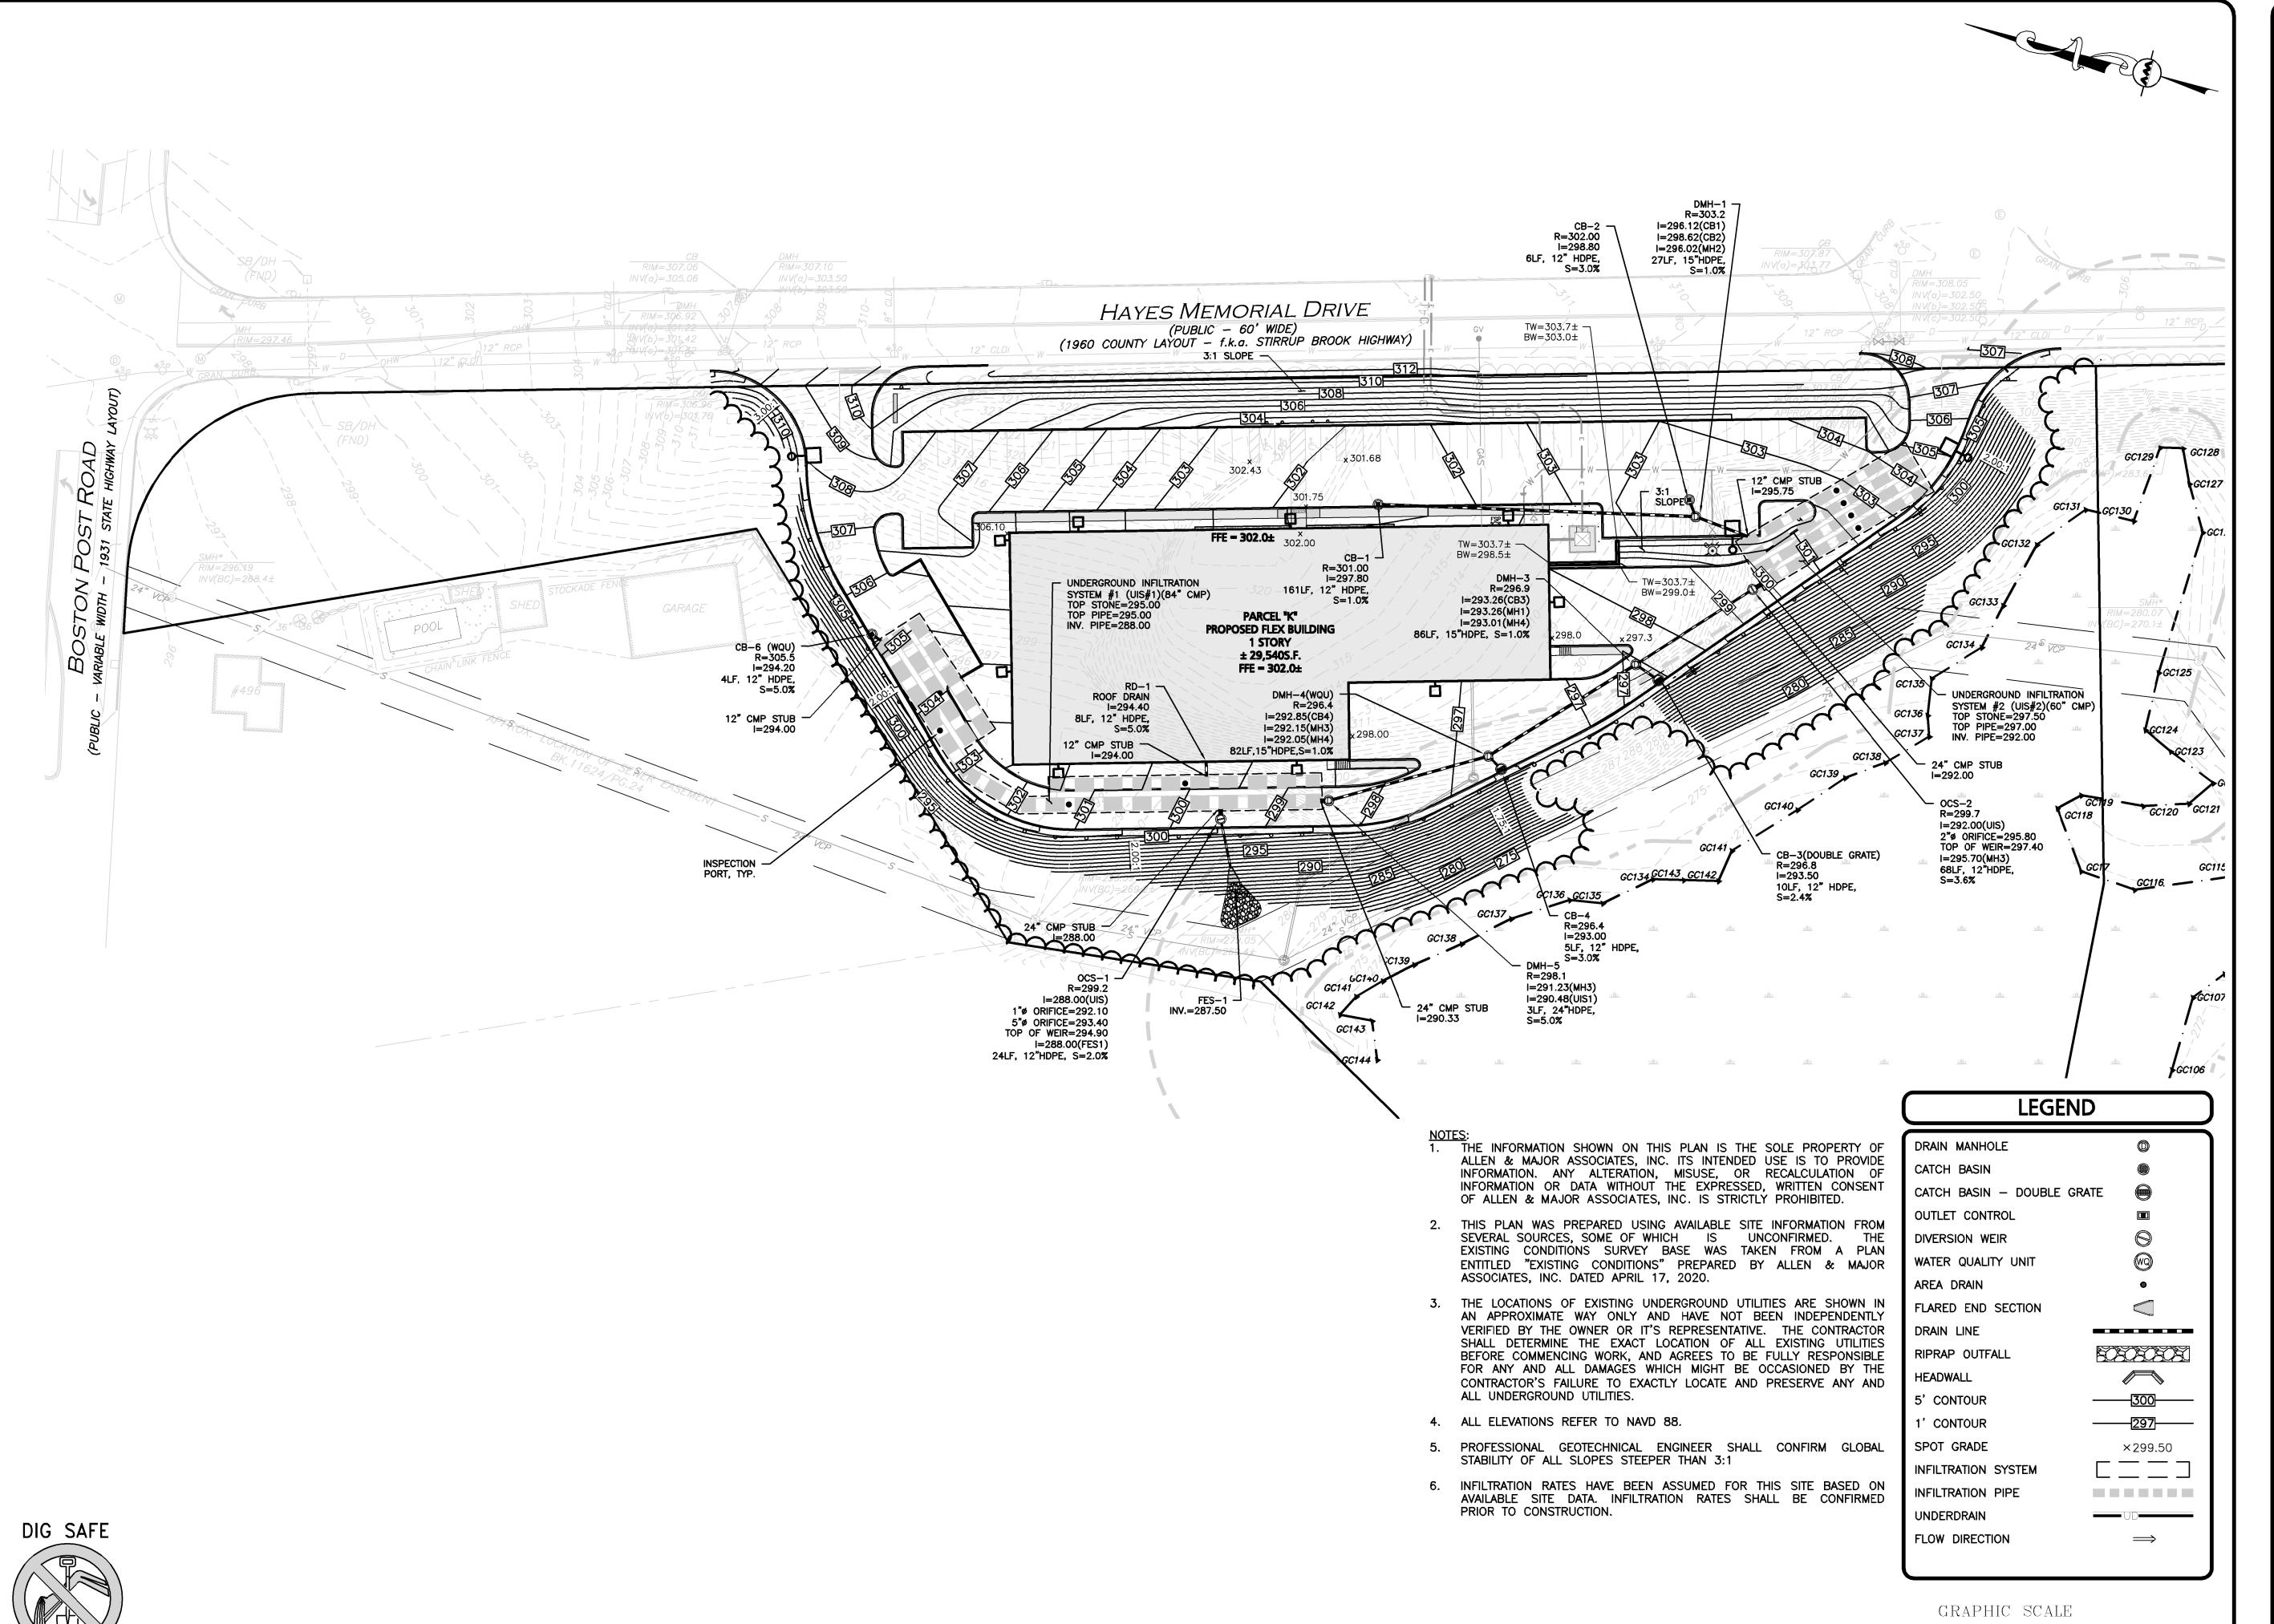
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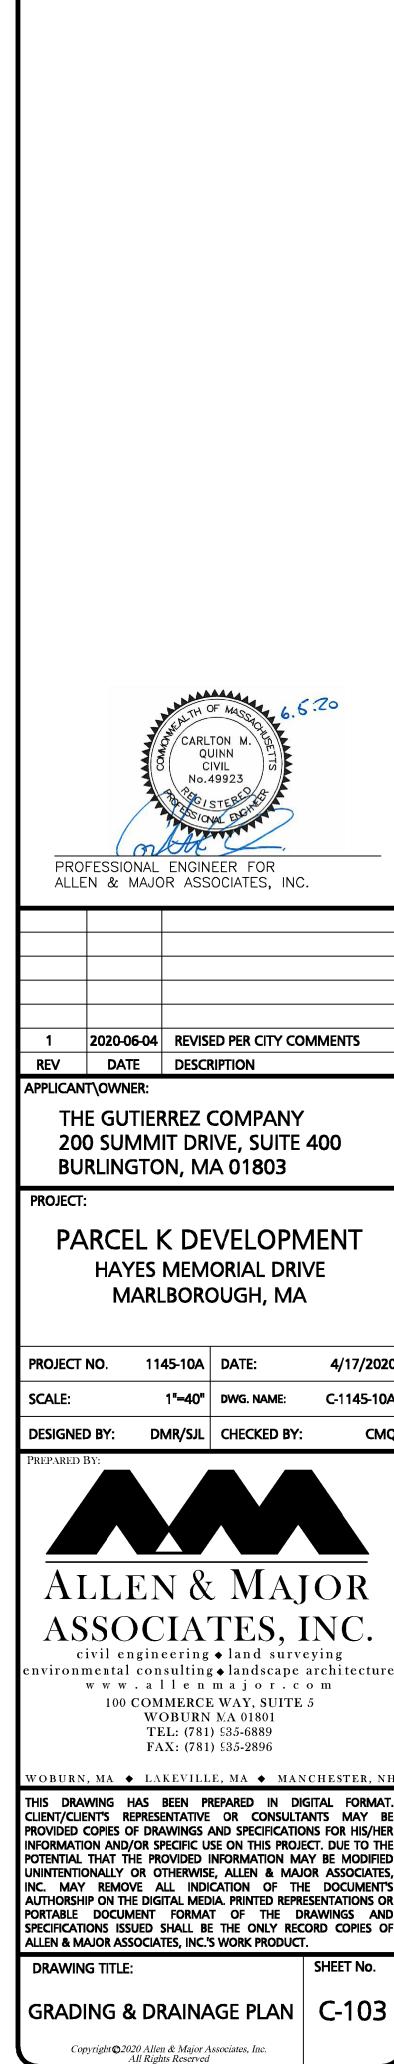
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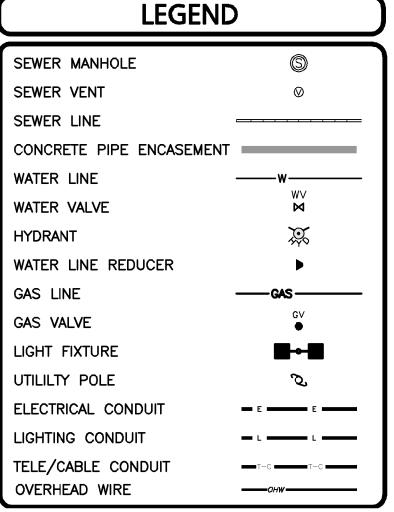
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1 inch = 40 ft.

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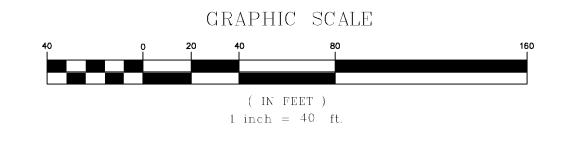
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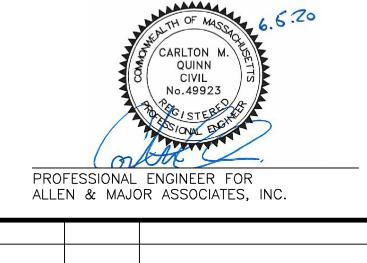
SHEET No.



THE LOCATIONS OF EXISTING UNDERGROUND UTILITIES ARE SHOWN IN AN APPROXIMATE WAY ONLY AND HAVE NOT BEEN INDEPENDENTLY VERIFIED BY THE OWNER OR IT'S REPRESENTATIVE. THE CONTRACTOR SHALL DETERMINE THE EXACT LOCATION OF ALL EXISTING UTILITIES BEFORE COMMENCING WORK, AND AGREES TO BE FULLY RESPONSIBLE FOR ANY AND ALL DAMAGES WHICH MIGHT BE OCCASIONED BY THE CONTRACTOR'S FAILURE TO EXACTLY LOCATE AND PRESERVE ANY AND ALL UNDERGROUND UTILITIES.

- BUILDING SEWER SERVICE LOCATIONS TO BE BASED ON FINAL BUILDING PLANS. CONNECTION POINTS SHALL BE AS SHOWN HEREON.
- PIPE DIMENSIONS ARE MEASURED FROM THE INSIDE FACE OF THE STRUCTURE.
- 4. NATURAL GAS DISTRIBUTION SHOWN HEREON ARE FOR COORDINATION PURPOSES ONLY. FINAL LAYOUT TO BE COORDINATED WITH UTILITY PROVIDER.
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- 6. ALL TRENCH WORK IN HAYES MEMORIAL DRIVE SHALL BE FILLED WITH FLOWABLE FILL.
- 7. WHEN WATER AND SEWER CROSSINGS ARE LESS THAN 18" VERTICAL AND/OR LESS THAN 10' HORIZONTAL, THE CROSSING SHALL BE ENCASED IN CONCRETE WITH FLOWABLE FILL.
- 8. SEWER INSTALLATION SHALL BE IN COMPLIANCE WITH THE CITY OF MARLBOROUGH ZONING BYLAWS CHAPTER 510 SEWERS AND MA DEP REVIEW OF SEWER LINE / WATER SUPPLY PROTECTION POLICY #: BRP/DWM/WS/P03-1.
- 9. ALL SEWER LINES AND APPURTENANCES SHALL BE DESIGNED AND CONSTRUCTED FOR MAXIMUM WATERTIGHTNESS.
- 10. SEWERS SHALL BE TESTED BY APPROVED METHODS WHICH WILL ACHIEVE TEST RESULTS FOR INFILTRATION AND EXFILTRATION OF LESS THAN 100 GALLONS / INCH DIAMETER / MILE / 24
- 11. A MINIMUM OF CLASS B BEDDING AS DEFINED BY WATER POLLUTION CONTROL FEDERATION (WPCF MOP - # 9) MANUAL OF PRACTICE NO. 9 - SEWER DESIGN AND CONSTRUCTION MUST BE USED FOR ALL PIPING.
- 12. SEWER CONNECTIONS (LATERALS AND HOUSE CONNECTIONS) SHALL BE RIGIDLY INSPECTED BY THE CITY OF MARLBOROUGH DPW AND CERTIFIED INSPECTION REPORTS SHALL BE SUBMITTED TO THE MA DEP.
- APROXIMATE LOCATION OF FIRE DEPARTMENT KNOX BOX. PER MARLBOROUGH FIRE DEPARTMENT, KNOX BOXES TO CONTAIN ALL KEYS, INCLUDING: ENTRY KEYS, FIRE ALARM PANEL KEYS, RADIO BOX KEYS, SPRINKLER BOX KEYS, ETC. CONTRACTOR TO COORDINATE WITH ARCHITECT AND MARLBOROUGH FIRE DEPARTMENT FOR EXACT LOCATION ON OUTSIDE OF
- 14. PER MARLBOROUGH FIRE DEPARTMENT, FIRE DEPARTMENT CONNECTION IS TO BE A 4" DIA., STORTZ STYLE, WITH A 30 DEGREE DOWN ANGLE. CONTRACTOR TO COORDINATE WITH MEP
- REFERENCE PLUMBING PLANS FOR FIRE DEPARTMENT CONNECTIONS AT BUILDINGS.
- 16. ALL HYDRANT BRANCHES SHALL BE SIX (6) INCH CAST IRON.
- 17. SEE DETAIL SHEET(S) FOR ADDITIONAL CITY OF MARLBOROUGH SEWER AND WATER NOTES.
- 18. CITY OF MARLBOROUGH STANDARDS REQUIRES SEWER MAINS GREATER THAN 10' DEPTH TO BE DUCTILE IRON.
- 19. THE CONTRACTOR SHALL OBTAIN A STREET OPENING PERMIT PRIOR TO ANY CONSTRUCTION WITHIN THE CITY RIGHT-OF-WAY.
- 20. ALL WATER AND SEWER MATERIAL AND CONSTRUCTION SHALL CONFORM TO CITY OF MARLBOROUGH REQUIREMENTS (SEE STREET OPENING PERMIT).
- 21. ALL WATER AND SEWER CONSTRUCTION SHALL BE INSPECTED BY THE CITY OF MARLBOROUGH BEFORE BACKFILLING.
- 22. THE CITY SHALL BE NOTIFIED AT LEAST 24 HOURS PRIOR TO THE REQUIRED INSPECTIONS.





2020-06-04 REVISED PER CITY COMMENTS

REV DATE DESCRIPTION APPLICANT\OWNER:

> THE GUTIERREZ COMPANY 200 SUMMIT DRIVE, SUITE 400 **BURLINGTON, MA 01803**

PROJECT:

PARCEL K DEVELOPMENT HAYES MEMORIAL DRIVE MARLBOROUGH, MA

PROJECT NO.	1145-10A	DATE:	4/17/202
SCALE:	1 <b>" =</b> 40'	DWG. NAME:	C-1145-10/
DESIGNED BY:	DMR/SJL	CHECKED BY:	СМ



ASSOCIATES, INC. civil engineering • land surveying environmental consulting • landscape architecture www.allenmajor.com

100 COMMERCE WAY, SUITE 5 WOBURN MA 01801 TEL: (781) 935-6889 FAX: (781) 935-2896

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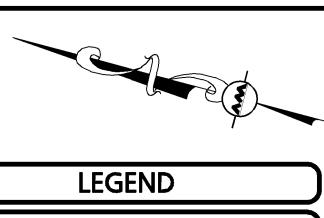
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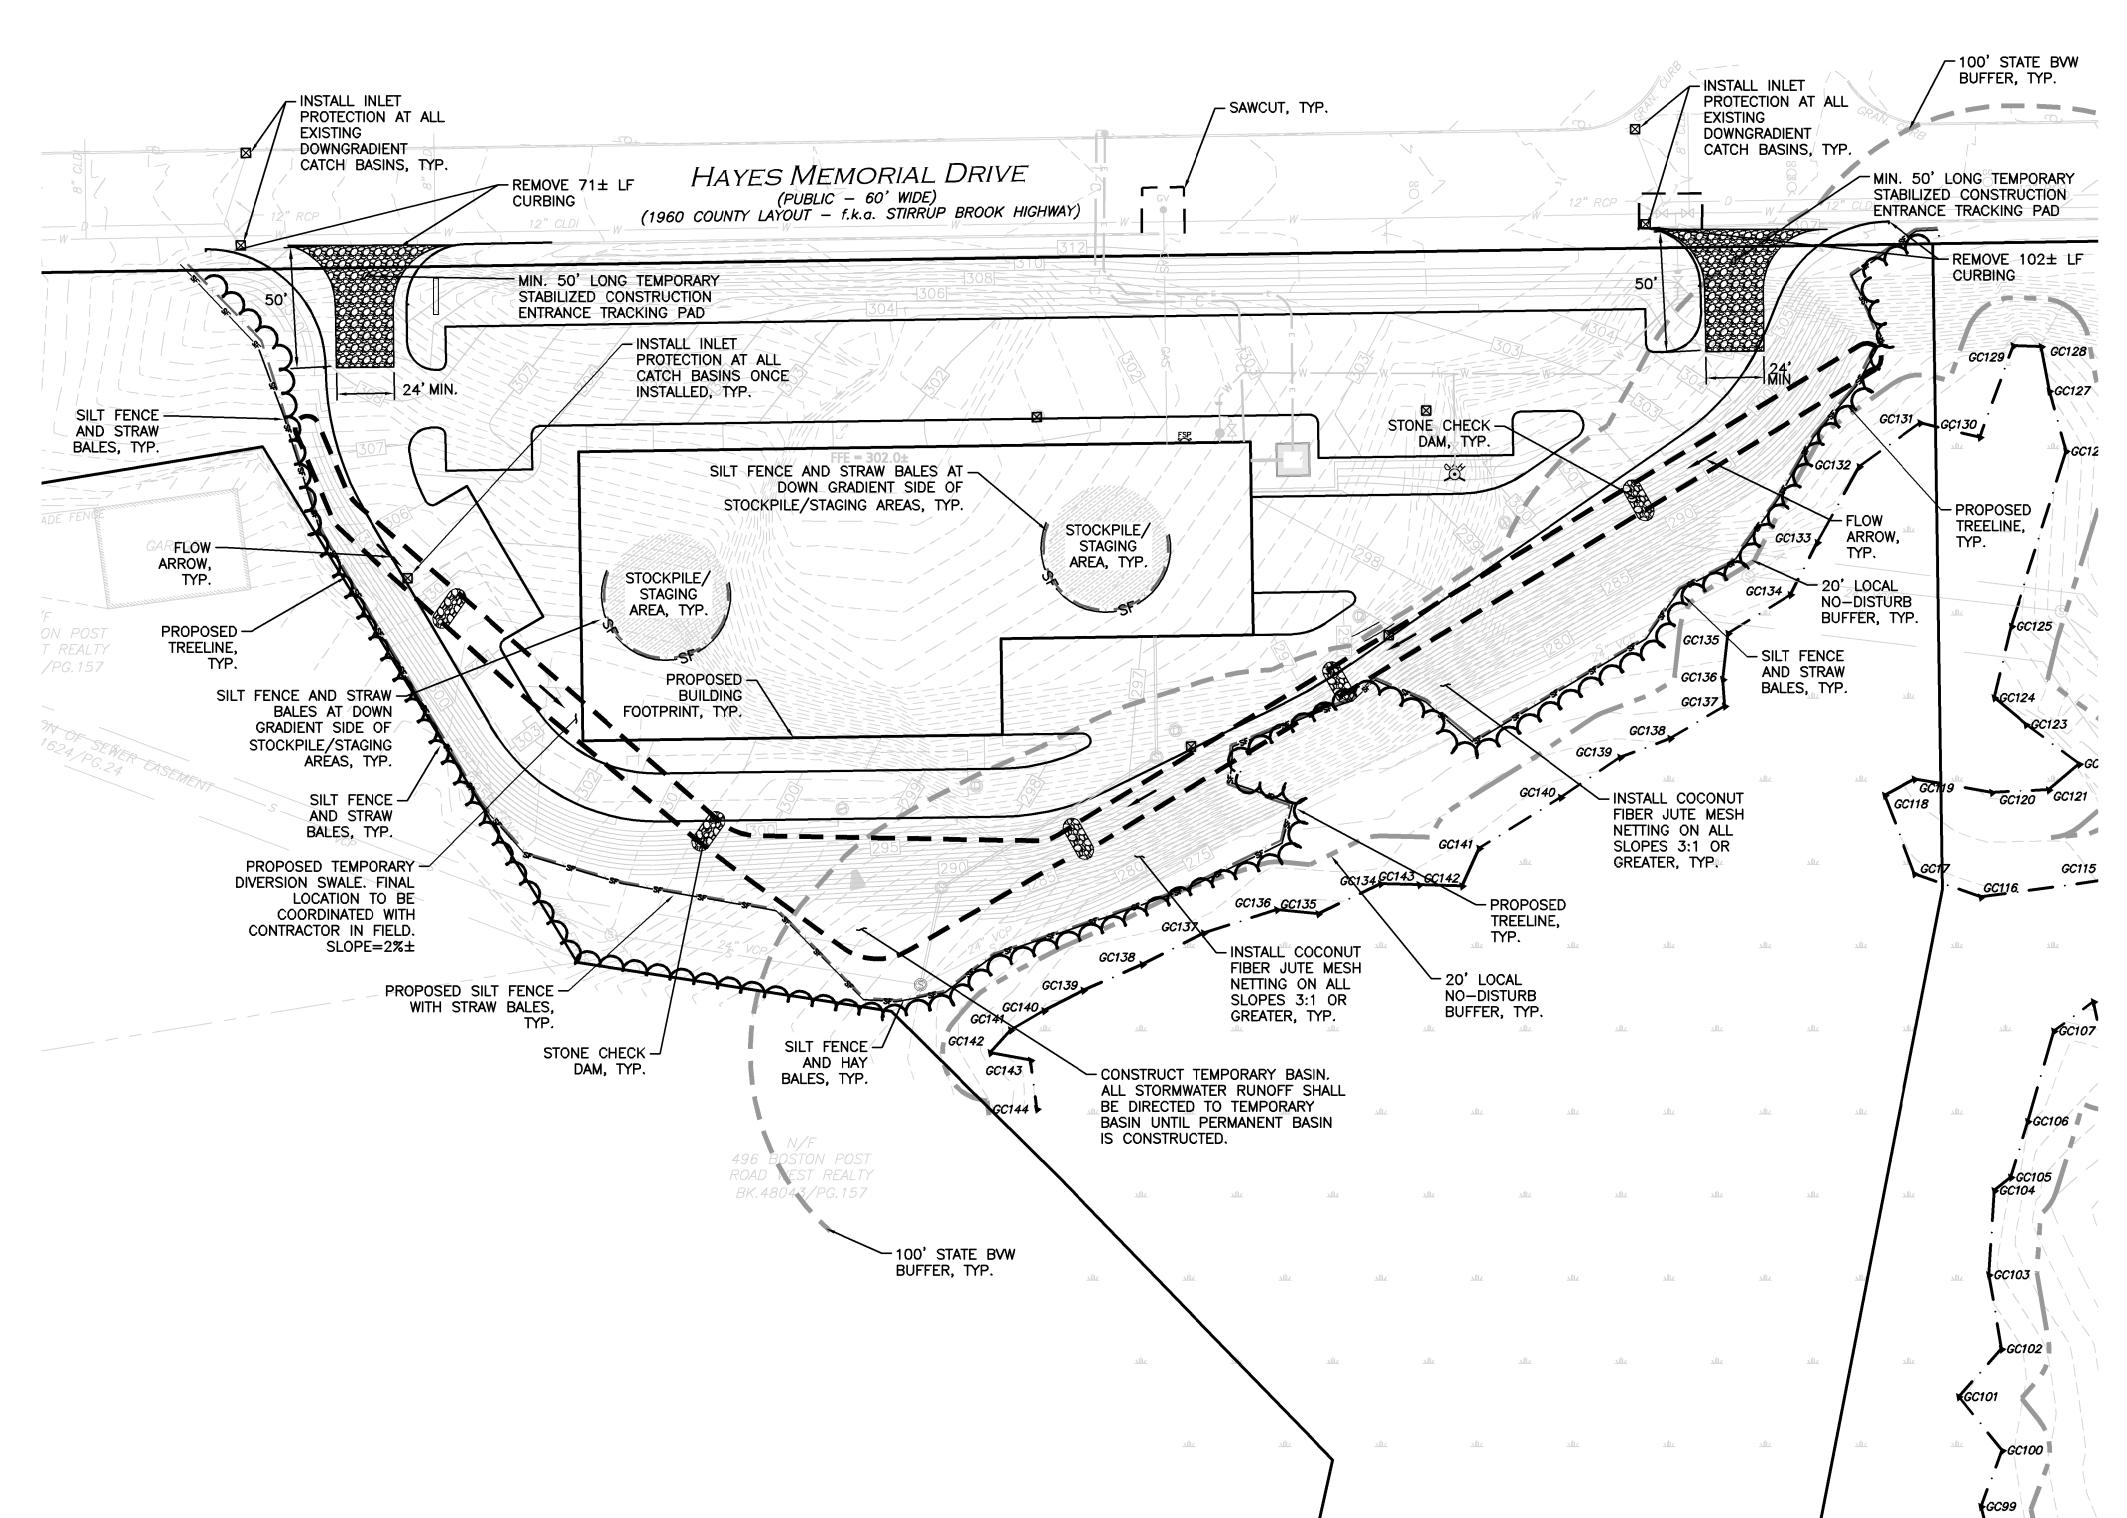
BEFORE YOU DIG CALL 811 OR

1-888-DIG-SAFE

1-888-344-7233

**UTILITIES PLAN** 






SILT FENCE \_\_\_\_SF\_\_\_\_ TUBULAR BARRIER EROSION CONTROL FABRIC CATCH BASIN FILTER  $\boxtimes$ **333** STONE CHECK DAM STABILIZED ENTRANCE

STOCKPILE/STAGING AREA

- 1. THE LOCATIONS OF EXISTING UNDERGROUND UTILITIES ARE SHOWN IN AN APPROXIMATE WAY ONLY AND HAVE NOT BEEN INDEPENDENTLY VERIFIED BY THE OWNER OR IT'S REPRESENTATIVE. THE CONTRACTOR SHALL DETERMINE THE EXACT LOCATION OF ALL EXISTING UTILITIES BEFORE COMMENCING WORK, AND AGREES TO BE FULLY RESPONSIBLE FOR ANY AND ALL DAMAGES WHICH MIGHT BE OCCASIONED BY THE CONTRACTOR'S FAILURE TO EXACTLY LOCATE AND PRESERVE ANY AND ALL UNDERGROUND UTILITIES.
- 2. THE CONTRACTOR SHALL CONTACT "DIGSAFE" AND THE CITY OF MARLBOROUGH DEPARTMENT OF PUBLIC WORKS AT LEAST 72 HOURS PRIOR TO ANY EXCAVATION WORK TO REQUEST THE LOCATION OF THE EXISTING UTILITIES.

DIGSAFE: 1-800-344-7233 MARLBOROUGH DEPT. OF PUBLIC WORKS: (508) 624-6910

- 3. SEE THE ABBREVIATIONS AND NOTES PLAN AND DETAILS FOR FURTHER INFORMATION.
- 4. ALL ELEVATIONS REFER TO NAVD88 DATUM.
- 5. ALTHOUGH CERTAIN ITEMS HAVE BEEN NOTED ON THIS DRAWING FOR DEMOLITION, NO ATTEMPT HAS BEEN MADE TO DELINEATE EACH AND EVERY ITEM THAT REQUIRES DEMOLITION FOR THE COMPLETION OF THE PROJECT. THE CONTRACTOR WILL BE RESPONSIBLE FOR ALL NECESSARY DEMOLITION WORK TO COMPLETE THE PROJECT. ALLEN & MAJOR ASSOCIATES, INC. IS NOT RESPONSIBLE FOR SITE DEMOLITION ITEMS NOT SHOWN ON THE SURVEY, OR SPECIFICALLY NOTED. DEMOLITION NOTES AND ARROWS ON THIS PLAN ARE TYPICAL AND DO NOT REFLECT QUANTITY.
- 6. ALL CATCH BASINS WITHIN THE PROJECT AREA SHALL BE EQUIPPED WITH SILT SACKS (OR APPROVED EQUAL).
- 7. CONTRACTOR SHALL PROVIDE WHEEL WASH STATIONS AS NECESSARY TO MITIGATE SEDIMENT TRACK-OUT TO BARTLETT STREET.
- 8. CONTRACTOR SHALL BE RESPONSIBLE FOR ALL TEMPORARY CONSTRUCTION CONTROLS. ALL STORMWATER RUNOFF SHALL BE DIRECTED TO TEMPORARY SEDIMENT BASIN DURING CONSTRUCTION UNTIL SLOPES ARE STABILIZED.
- 9. ALL EROSION CONTROL MEASURES SHALL BE IN PLACE PRIOR TO START OF CONSTRUCTION. EROSION CONTROL SHALL CONFORM TO THE CITY OF MARLBOROUGH CONSERVATION COMMISSION REQUIREMENTS AS STATED IN THE ORDER OF CONDITIONS.

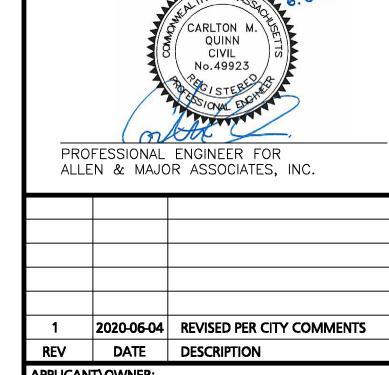

APPLICANT\OWNER:

THE GUTIERREZ COMPANY 200 SUMMIT DRIVE, SUITE 400 **BURLINGTON, MA 01803** 

PROJECT:

PROJECT NO.

SCALE:

PARCEL K DEVELOPMENT HAYES MEMORIAL DRIVE MARLBOROUGH, MA

1145-10A DATE:

1" = 40' DWG. NAME:

**DESIGNED BY:** DMR/SJL | CHECKED BY: ALLEN & MAJOR ASSOCIATES, INC.

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**DRAWING TITLE:** 

SHEET No.

4/17/2020

C-1145-10A

**EROSION CONTROL PLAN** 

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GRAPHIC SCALE ( IN FEET ) 1 inch = 40 ft.

C-101

#### GENERAL LAWN MIX

SCIENTIFIC NAME	COMMON NAME BY WEIGHT PUR	PROPORTION ITY GER	PERCENT <u>MINATION</u>	PERCENT
FESTUCA RUBRA "RUBRA"	CREEPING RED FESCUE	37%	95%	90%
PAO PRAENTENSIS "BARON"	BARON KENTUCKY BLUEGRASS	40%	85%	90%
LOLIUM PERENNE "PALMER"	PALMER PERENNIAL RYEGRASS	15%	95%	90%
FESTUCA RUBRA COMMUTATA WILMA	WILMA CHEWINGS	8%	95%	80%

1. SEED TO BE SPREAD AT MINIMUM RATE OF 5 LBS. PER 1000 SQ. FT.

2. ALL SEEDING (INCLUDING NEW ENGLAND WETLAND MIX SEEDS) TO BE COMPLETED "IN SEASON" BETWEEN APRIL 1 TO JUNE 15 OR AUGUST 15 TO OCTOBER 1, EXCEPT FOR RE-SEEDING OF BARE SPOTS. AT ALL SLOPED AREAS CONTRACTOR TO INSTALL COCONUT FIBER JUTE MESH NETTING ON ALL SLOPES 3:1 AND OVER, HYDROSEED ALL EXPOSED AREAS, ADD SOIL STABILIZER "FLUX TERRA HP-FGM SOIL STABILIZER" AS MANUFACTURED BY "PROFILE" TO HYDROSEED (AT RATE OF 3,000 LBS PER ACRE), AT NO ADDITIONAL COST TO THE OWNER. CONTRACTOR TO ALSO BE RESPONSIBLE FOR RE-GRADING AND RE-SEEDING ALL DISTURBED, ERODED, OR BARE SPOTS AT NO ADDITIONAL COST TO OWNER & UNTIL SLOPES ARE FULLY STABLE. CONTRACTOR RESPONSIBLE FOR ALL MAINTENANCE UNTIL FINAL ACCEPTANCE OF LAWN AREAS INCLUDING: WATERING, ADDING FERTILIZERS AND LIME AND MOWING AT NO ADDITIONAL COST TO OWNER. AFTER SEEDING, SEEDED AREAS TO BE LIGHTLY MULCHED WITH WEED FREE STRAW & CONTINUALLY WATERED EVERY DAY FOR 2 MONTHS (USE NO HAY) SO THAT SEED IS KEPT MOIST.

3. COMMERCIAL FERTILIZER SHALL BE APPLIED AT THE RATE OF 25 POUNDS PER 1000 SQ. FT. OR AS RECOMMENDED BY THE TESTING AGENCY. LIME TO BE SPREAD AT THE RATE OF 100 POUNDS PER 1000 SQ. FT OR AS RECOMMENDED BY THE TESTING AGENCY. COMMERCIAL FERTILIZER SHALL BE A COMPLETE FERTILIZER CONTAINING AT LEAST 50% OF THE NITROGEN OF WHICH IS DERIVED FROM NATURAL ORGANIZE SOURCES OF UREAFORM. IT SHALL CONTAIN THE FOLLOWING PERCENTAGES BY WEIGHT: NITROGEN (N) 10%. PHOSPHORUS (P) 6%, POTASH (K) 4%. LIME SHALL BE AN APPROVED AGRICULTURAL LIMESTONE CONTAINING NOT LESS THAN 85% OF TOTAL CARBONATES. LIMESTONE SHALL BE GROUND TO SUCH FINENESS THAT 50% WILL PASS A 100 MESH SIEVE AND 90% WILL PASS THROUGH A 20 MESH SIEVE.

4.LAWN AREAS TO BE SEEDED BY SOWING EVENLY WITH AN APPROVED MECHANICAL SEEDER AT THE RATE OF TEN POUNDS PER 1000

5. CONTRACTOR RESPONSIBLE FOR WATERING, MOWING, AND RESEEDING OF LAWN BARE SPOTS UNTIL A UNIFORM, HEALTHY STAND OF GRASS IS ESTABLISHED AND ACCEPTED.

25 SHRUBS REQUIRED

1-888-DIG-SAFE

1-888-344-7233

### ADDITIONAL SEED MIX SPECIFICATIONS FOR SLOPES AREAS (AS NOTED ON THE PLAN):

#### SEE NOTE #22 ON SHEET L-102 FOR RATE OF APPLICATION & ADDITIONAL INFORMATION

WWW.NEWP.COM OR

Amherst, MA 01002

Ph: (413) 548-8000 | Fx: (413) 549-4000 | info@newp.com New England Wetland Plants, Inc. 820 West Street

## NEW ENGLAND EROSION CONTROL / RESTORATION MIX FOR DRY SITES:

- 1. UPLAND BENTGRASS 2. ROUGH BENTGRASS/TICKLEGRASS
- 3. BLUE GRAMA
- 4. CANADA WILD RYE 5. CREEPING RED FESCUE
- 6. ANNUAL RYEGRASS (NATURALIZED)
- 7. PERRENIAL RYEGRASS (NATURALIZED)
- 8. LITTLE BLUESTEM

9. INDIAN GRASSS

AGROSTIS PERENNANS AGROSTIS SCABRA **BOUTELOUA GRACILIS ELYMUS CANADENSIS** FESTUCA RUBRA LOLIUM MULTIFLORUM LOLIUM PERENNE SCHIZACHYRIUM SCOPARIUM

SORGHASTRUM NUTANS

(BY NEW ENGLAND WETLAND PLANTS INC) EROSION CONTROL/RESTORATION MIX FOR DETENTION BASINS AND

- A. ELYMUS VIRGINICUS
- B. FESTUCA RUBRA SCHIZACHYRIUM SCOPARIUM ANDROPOGON GERARDII
- PANICUM VIRGATUM
- . VERBENA HASTATA
- G. AGROSTIS SCABRA H. ASTER NOVAE-ANGLIAE
- EUPATORIUM MACULATUM . EUPATORIUM PERFOLIATUM
- K. JUNCUS EFFUSUS L. SCIRPUS CYPERINUS
- VIRGINIA WILD RYE CREEPING RED FESCUE LITTLE BLUESTEM BIG BLUESTEM SWITCH GRASS BLUE VERVAIN ROUGH BENTGRASS NEW ENGLAND ASTER

SPOTTED JOE PYE WEED BONESET SOFT RUSH WOOL GRASS

## **LEGEND** PROPERTY LINE SIGN PROP. BUILDING **BUILDING ARCHITECTURE** CURB CONCRETE SIDEWALK DECIDUOUS TREES Ų٥ **EVERGREEN TREES** FLOWERING/ ORNAMENTAL TREES SHRUBS MULCH BED


PERENNIALS




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- 3. ALL LANDSCAPED AREAS WITH SHRUBS, TREES, AND PERENNIALS TO HAVE 18" MINIMUM DEPTH OF TOPSOIL. EIGHTEEN INCHES OF TOPSOIL AROUND TREES AND SHRUBS DOES NOT INCLUDE AMENDED PLANTING SOIL WITHIN TREE / SHRUB PIT FOR FULL DEPTH OF ROOTBALLS. SEE PLANTING DETAILS FOR PLANTING DEPTH AT SHRUBS AND TREES. ALL AREAS OF LOAM AND SEED OR LOAM & SOD TO HAVE 6" MINIMUM DEPTH OF TOPSOIL. TOPSOIL TO BE TESTED BY CONTRACTOR, AND APPROVED BY A&M PRIOR TO PURCHASE AND OR PLACEMENT. GENERAL CONTRACTOR, DEMOLITION AND LANDSCAPE CONTRACTOR TO CONTRACTOR, COORDINATE PROPER DEPTH OF EXISTING MATERIAL REMOVAL ACROSS SITE SO THAT 18" MINIMUM AND 6" MINIMUM DEPTHS OF PROPOSED TOPSOIL NOTED ABOVE ARE MET AT NO ADDITIONAL COST TO OWNER. SEE TOPSOIL DETAIL.
- <u>L-102</u> <u>FOR</u> <u>ADDITIONAL</u> <u>LANDSCAPE</u>

1 inch = 40 ft.



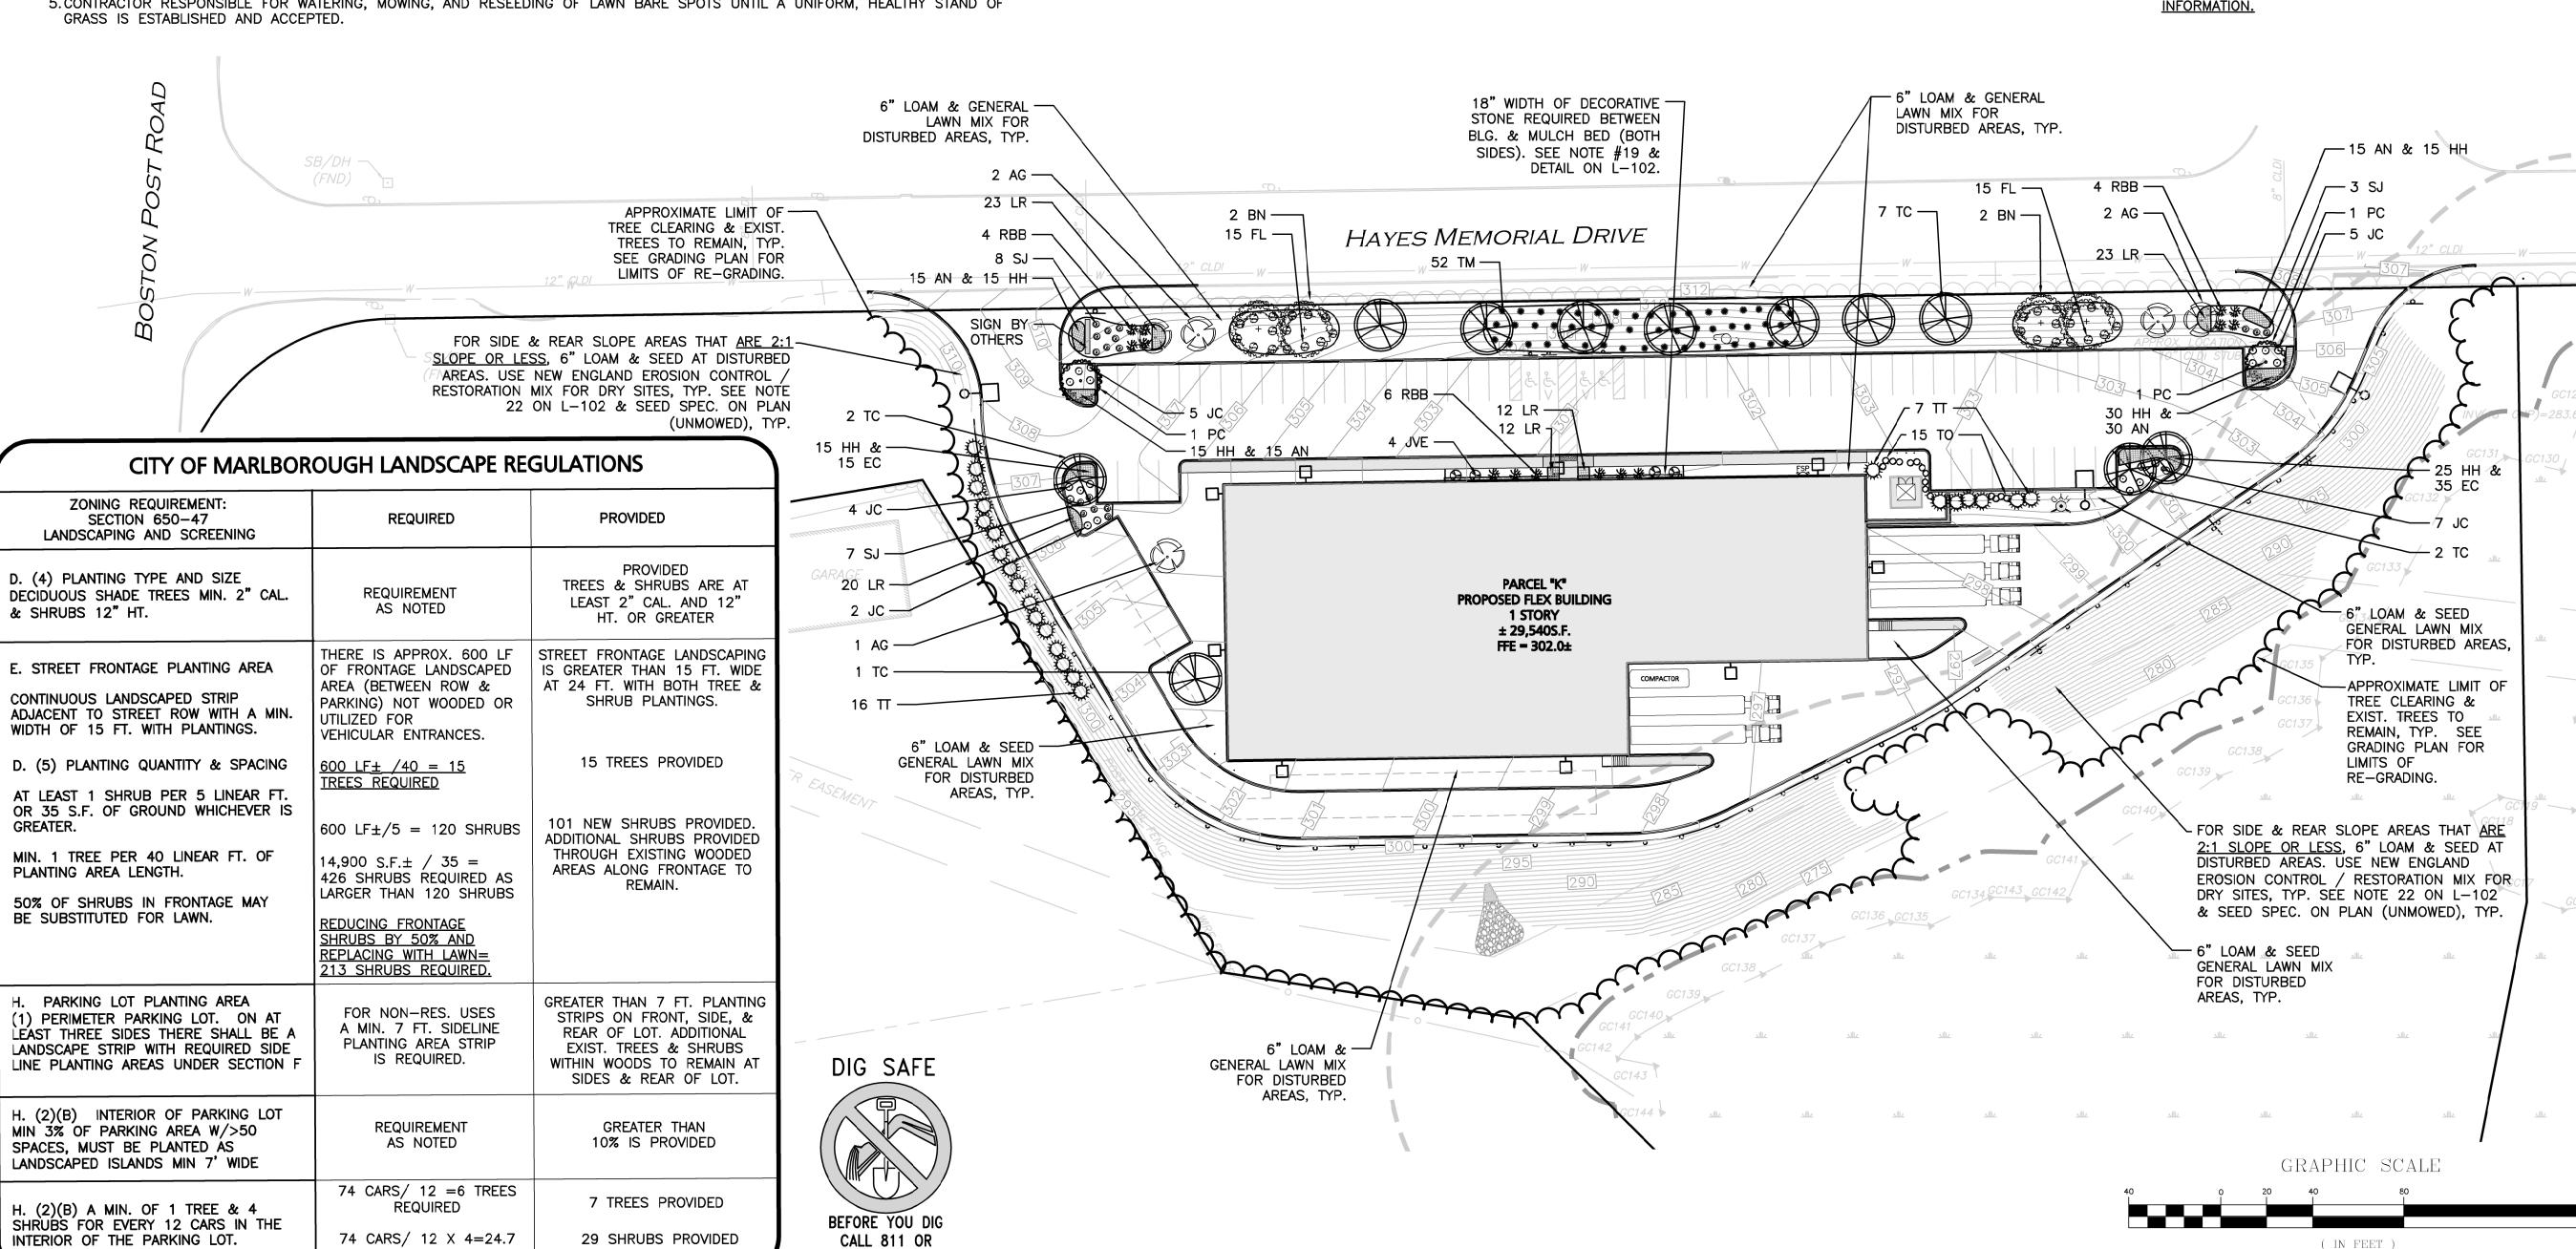

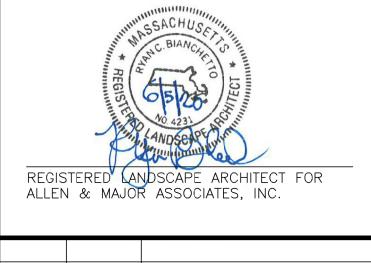2020-06-04 REVISED PER CITY COMMENTS DATE DESCRIPTION

#### REV APPLICANT\OWNER:

THE GUTIERREZ COMPANY 200 SUMMIT DRIVE, SUITE 400 **BURLINGTON, MA 01803** 

### PROJECT:

PARCEL K DEVELOPMENT HAYES MEMORIAL DRIVE MARLBOROUGH, MA

1145-10A DATE: PROJECT NO. 4/17/2020 1" = 40' DWG. NAME: C-1145-10A DESIGNED BY: RB/DMR/SJL | CHECKED BY:



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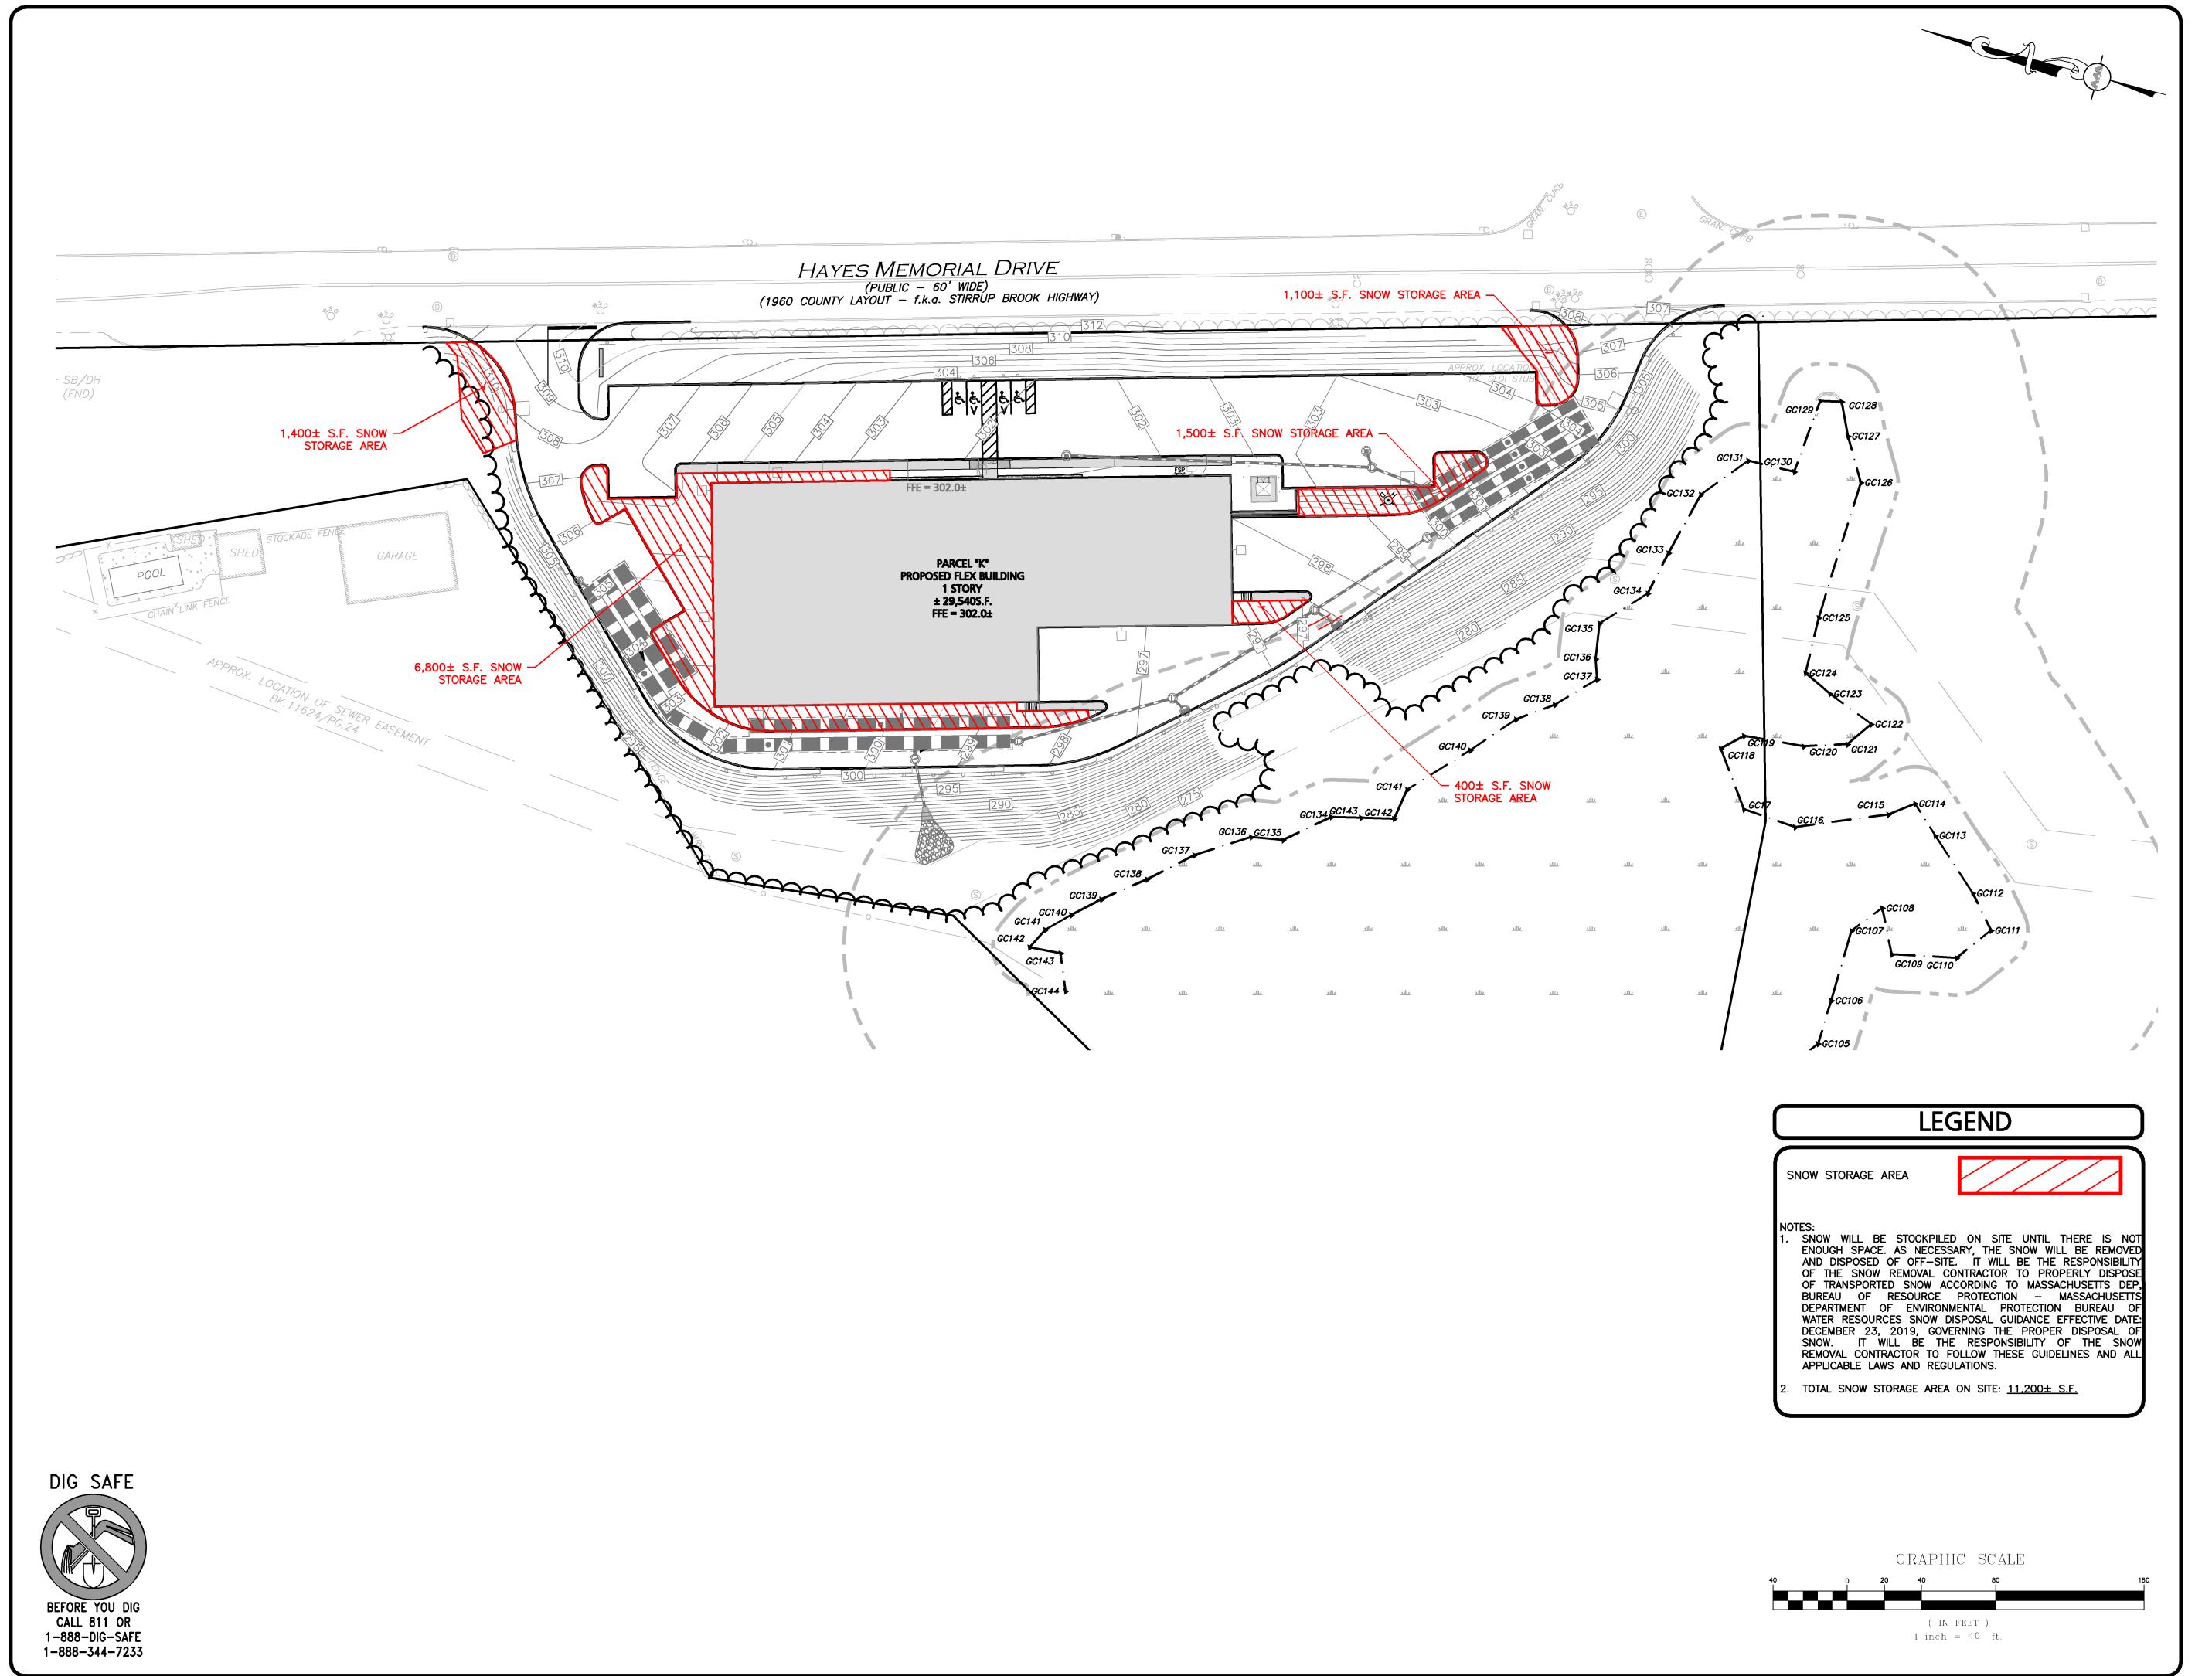
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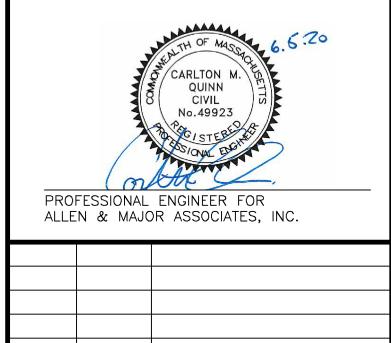
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**DRAWING TITLE:** 

SHEET No.

L-101 LANDSCAPE PLAN





2020-06-04 REVISED PER CITY COMMENTS DATE DESCRIPTION **REV** 

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THE GUTIERREZ COMPANY 200 SUMMIT DRIVE, SUITE 400 **BURLINGTON, MA 01803** 

PROJECT:

PARCEL K DEVELOPMENT HAYES MEMORIAL DRIVE MARLBOROUGH, MA

1145-10A DATE: PROJECT NO. 4/17/2020 SCALE: 1" = 40' DWG. NAME: C-1145-10A DESIGNED BY: DMR/SJL | CHECKED BY:



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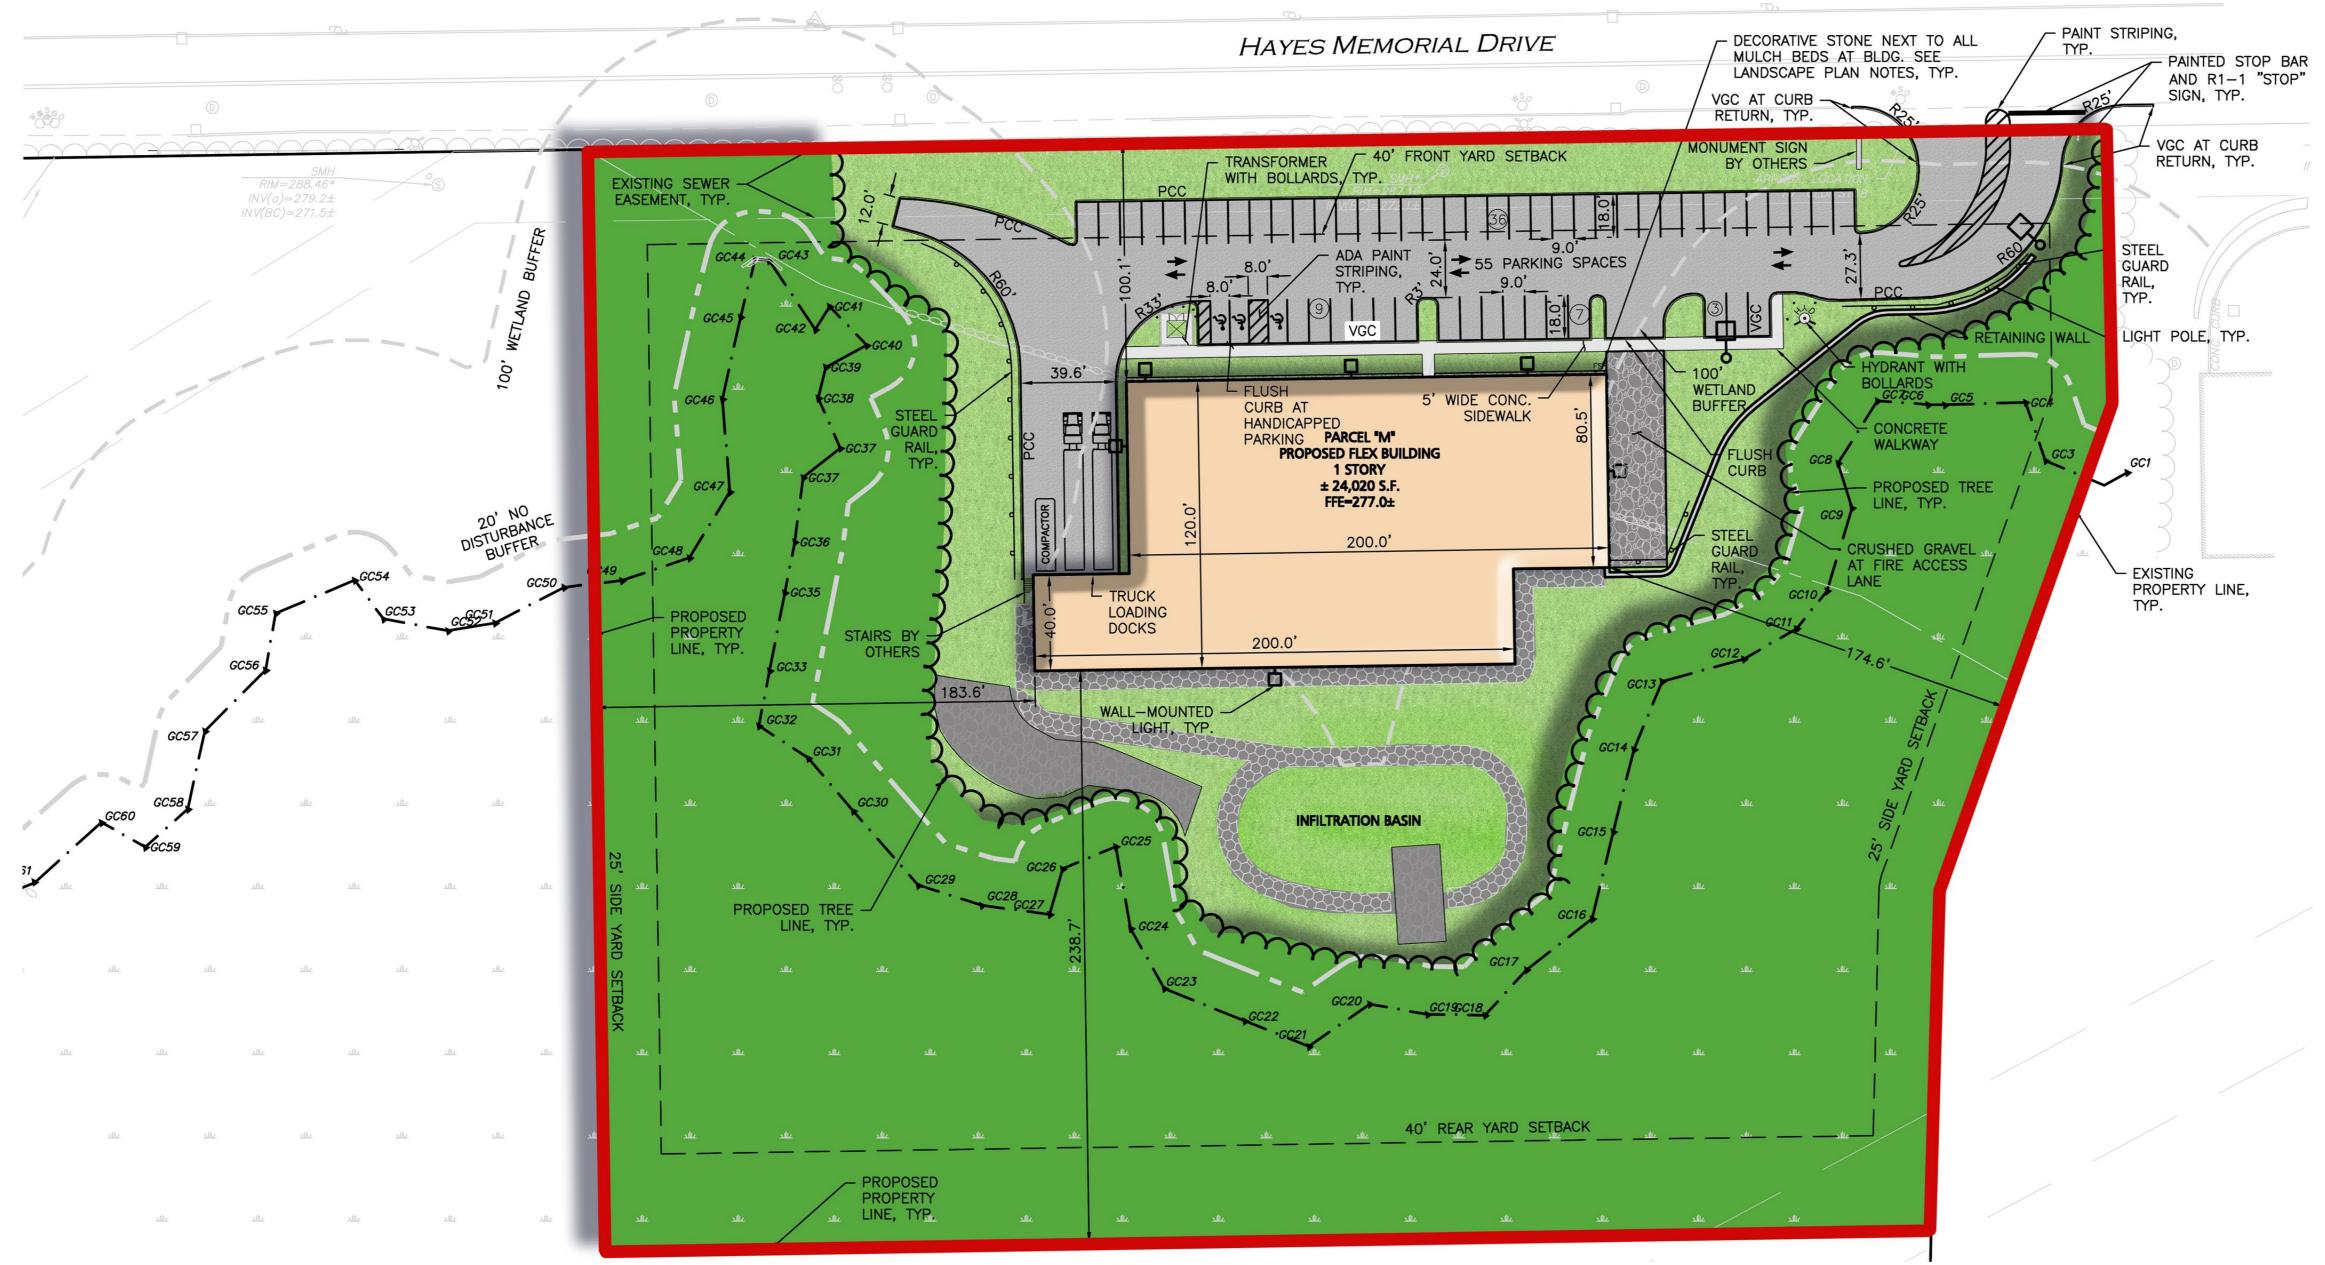
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**DRAWING TITLE:** 

SHEET No. C-108 **SNOW STORAGE PLAN** 



ZONING & LAND USAGE SUMMARY TABLE MAP 99 LOT 6 & MAP 99 LOT 1 PARCEL "M" DEVELOPMENT, HAYES MEMORIAL DRIVE, MARLBOROUGH, MA **ZONING DISTRICT: INDUSTRIAL - (I)** LAND USAGE:MANUFACTURING/WAREHOUSE SPACE

ITEM	REQUIRED	EXISTING	PROPOSED
LOT AREA (MIN.)	1 ACRES	1.79± Ac. (99/6) 30.40± Ac. (99/1)	272,301± S.F. 6.25± ACRES
LOT FRONTAGE (MIN.)	50 FEET	634.05± FEET	634.1± FEET
FRONT YARD SETBACK (MIN.)	40 FEET	N/A <sup>(5)</sup>	100.1± FEET
SIDE YARD SETBACK (MIN.)	25 FEET <sup>(1)</sup>	N/A <sup>(5)</sup>	174.6± FEET
REAR YARD SETBACK (MIN.)	40 FEET <sup>(2)</sup>	N/A <sup>(5)</sup>	238.7± FEET
LOT COVERAGE (MAX.)	60% <sup>(3)</sup>	N/A <sup>(5)</sup>	23.1%
BUILDING HEIGHT (MAX.)	_(4)	N/A <sup>(5)</sup>	30 FEET

### **ZONING & LAND USAGE SUMMARY TABLE NOTES**

- (1) EXCEPT WHERE ABUTTING RESIDENTIAL DISTRICT, SHALL BE 50 FEET.
- (2) EXCEPT FOR BUILDING EXTENDING THROUGH A BLOCK OR TO A RAILROAD SIDING.
- (3) MAXIMUM LOT COVERAGE FOR A LARGE TRACT DEVELOPMENT SHALL BE 50%.
- (4) BUILDINGS ON A LARGE TRACT DEVELOPMENT LOT, WHICH ARE MORE THAN 1,200 FEET FROM A RESIDENTIAL ZONE, MAY BE BUILT TO A MAXIMUM OF 85 FEET.
- (5) NO EXISTING BUILDING ON SITE.

### OFF-STREET PARKING SUMMARY TABLE, PARCEL "M"

USE: WHOLESALE WAREHOUSE, TRUCK FREIGHT TERMINAL OR STORAGE WAREHOUSE:

1 SPACE PER 3 WORKERS, BASED ON PEAK EMPLOYMENT

PEAK EMPLOYMENT IS 165

TOTAL SPACES REQUIRED = 55

TOTAL SPACES PROVIDED = 55 SPACES


TOTAL TRUCK LOADING BAYS PROVIDED: 2

ADA REQUIRED: 3 TOTAL PARKING STALLS TO BE ACCESSIBLE, INCLUDING 1 SPACE WHICH SHALL BE VAN ACCESSIBLE.

ADA PROVIDED: 3 TOTAL ACCESSIBLE STALLS INCLUDING 2 VAN ACCESSIBLE STALLS.

TOTAL EQUIRED	TOTAL EXISTING	HANDICAPPED PROVIDED	COMPACT PROVIDED	TRUCK BAYS PROVIDED	STANDARD PROVIDED	TOTAL PROVIDED
55	0	3 <sup>(1)</sup>	0	2	52	55

(1)INCLUDING 2 VAN ACCESSIBLE STALLS.

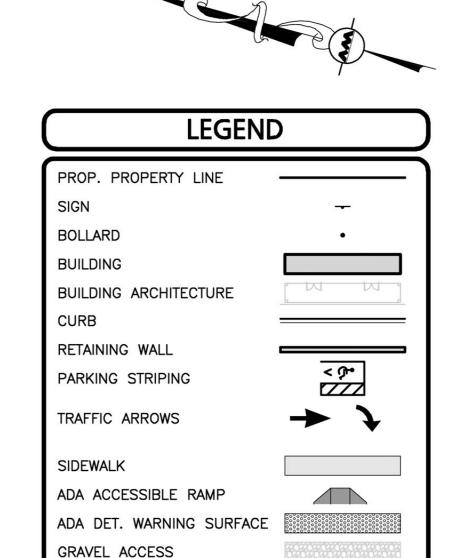

SETBACK LINE

PARKING COUNT

STEEL GUARDRAIL

TREE LINE

TRANSFORMER

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- 4. ALL ELEVATIONS REFER TO NAVD 88.
- 5. ANY MINOR MODIFICATIONS (AS DETERMINED BY THE CITY ENGINEER) TO THE INFORMATION SHOWN ON THE APPROVED PLAN SETS SHALL BE SUBMITTED TO THE CITY ENGINEER AS A MINOR PLAN REVISION FOR APPROVAL PRIOR TO THE WORK BEING PERFORMED.
- 6. ANY WORK AND MATERIAL WITHIN HE CITY RIGHT-OF-WAY SHALL CONFORM TO THE CITY OF MARLBOROUGH REQUIREMENTS.
- 7. ALL HANDICAP PARKING, RAMPS, AND ACCESS SHALL CONFORM TO AAB REQUIREMENTS.
- 8. ALL PAVEMENT MARKINGS AND SIGNS SHALL CONFORM TO MUTCD REQUIREMENTS.



CARLTON M.

QUINN

2020-06-05 REVISED PER CITY COMMENTS

PROFESSIONAL ENGINEER FOR

**REV** 

PROJECT:

PROJECT NO.

**DESIGNED BY:** 

SCALE:

APPLICANT\OWNER:

ALLEN & MAJOR ASSOCIATES, INC.

DATE DESCRIPTION

THE GUTIERREZ COMPANY

**BURLINGTON, MA 01803** 

200 SUMMIT DRIVE, SUITE 400

PARCEL M DEVELOPMENT

HAYES MEMORIAL DRIVE

MARLBOROUGH, MA

1145-10A DATE:

1" = 40' DWG. NAME:

DMR | CHECKED BY:

04-17-2020

C-1145-10A

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DRAWING TITLE:

GRAPHIC SCALE ( IN FEET ) 1 inch = 40 ft.

ALLEN & MAJOR WOBURN, MA ◆ LAKEVILLE, MA ◆ MANCHESTER, NE

> SHEET No. LAYOUT & MATERIALS PLAN | C-102



# **LEGEND**

DRAIN MANHOLE	
CATCH BASIN	
CATCH BASIN - DOUBLE	GRATE
OUTLET CONTROL	
DIVERSION WEIR	
WATER QUALITY UNIT	
AREA DRAIN	•
FLARED END SECTION	
DRAIN LINE	
RIPRAP OUTFALL	RORORORO
HEADWALL	
5' CONTOUR	
1' CONTOUR	<del></del> 277
SPOT GRADE	×275.50
INFILTRATION SYSTEM	
INFILTRATION PIPE	
DETENTION PIPE	
UNDERDRAIN	UD
FLOW DIRECTION	$\Longrightarrow$

NOTES:


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3. THE LOCATIONS OF EXISTING UNDERGROUND UTILITIES ARE SHOWN IN AN APPROXIMATE WAY ONLY AND HAVE NOT BEEN INDEPENDENTLY VERIFIED BY THE OWNER OR IT'S REPRESENTATIVE. THE CONTRACTOR SHALL DETERMINE THE EXACT LOCATION OF ALL EXISTING UTILITIES BEFORE COMMENCING WORK, AND AGREES TO BE FULLY RESPONSIBLE FOR ANY AND ALL DAMAGES WHICH MIGHT BE OCCASIONED BY THE CONTRACTOR'S FAILURE TO EXACTLY LOCATE AND PRESERVE ANY AND ALL UNDERGROUND UTILITIES.

4. ALL ELEVATIONS REFER TO NAVD 88.

PROFESSIONAL GEOTECHNICAL ENGINEER SHALL CONFIRM GLOBAL STABILITY OF ALL SLOPES STEEPER THAN 3:1



2020-06-05 REVISED PER CITY COMMENTS REV DATE DESCRIPTION

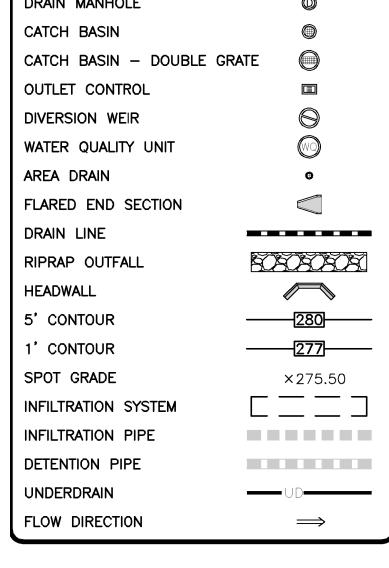PROFESSIONAL ENGINEER FOR ALLEN & MAJOR ASSOCIATES, INC.

APPLICANT\OWNER: THE GUTIERREZ COMPANY 200 SUMMIT DRIVE, SUITE 400

**BURLINGTON, MA 01803** 

PROJECT:

PROJECT NO.

SCALE:

PARCEL M DEVELOPMENT HAYES MEMORIAL DRIVE MARLBOROUGH, MA

1145-10A DATE:

1" = 40' DWG. NAME:

04-17-2020

C-1145-10A

DMR | CHECKED BY: **DESIGNED BY:** ALLEN & MAJOR ASSOCIATES, INC.

civil engineering ◆ land surveying environmental consulting • landscape architecture www.allenmajor.com 100 COMMERCE WAY, SUITE 5 WOBURN MA 01801

TEL: (781) 935-6889 FAX: (781) 935-2896


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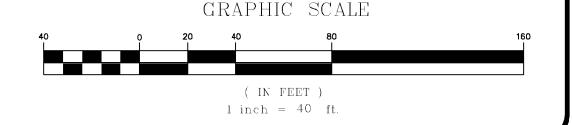
**DRAWING TITLE:** 

SHEET No.

GRADING & DRAINAGE PLAN | C-103





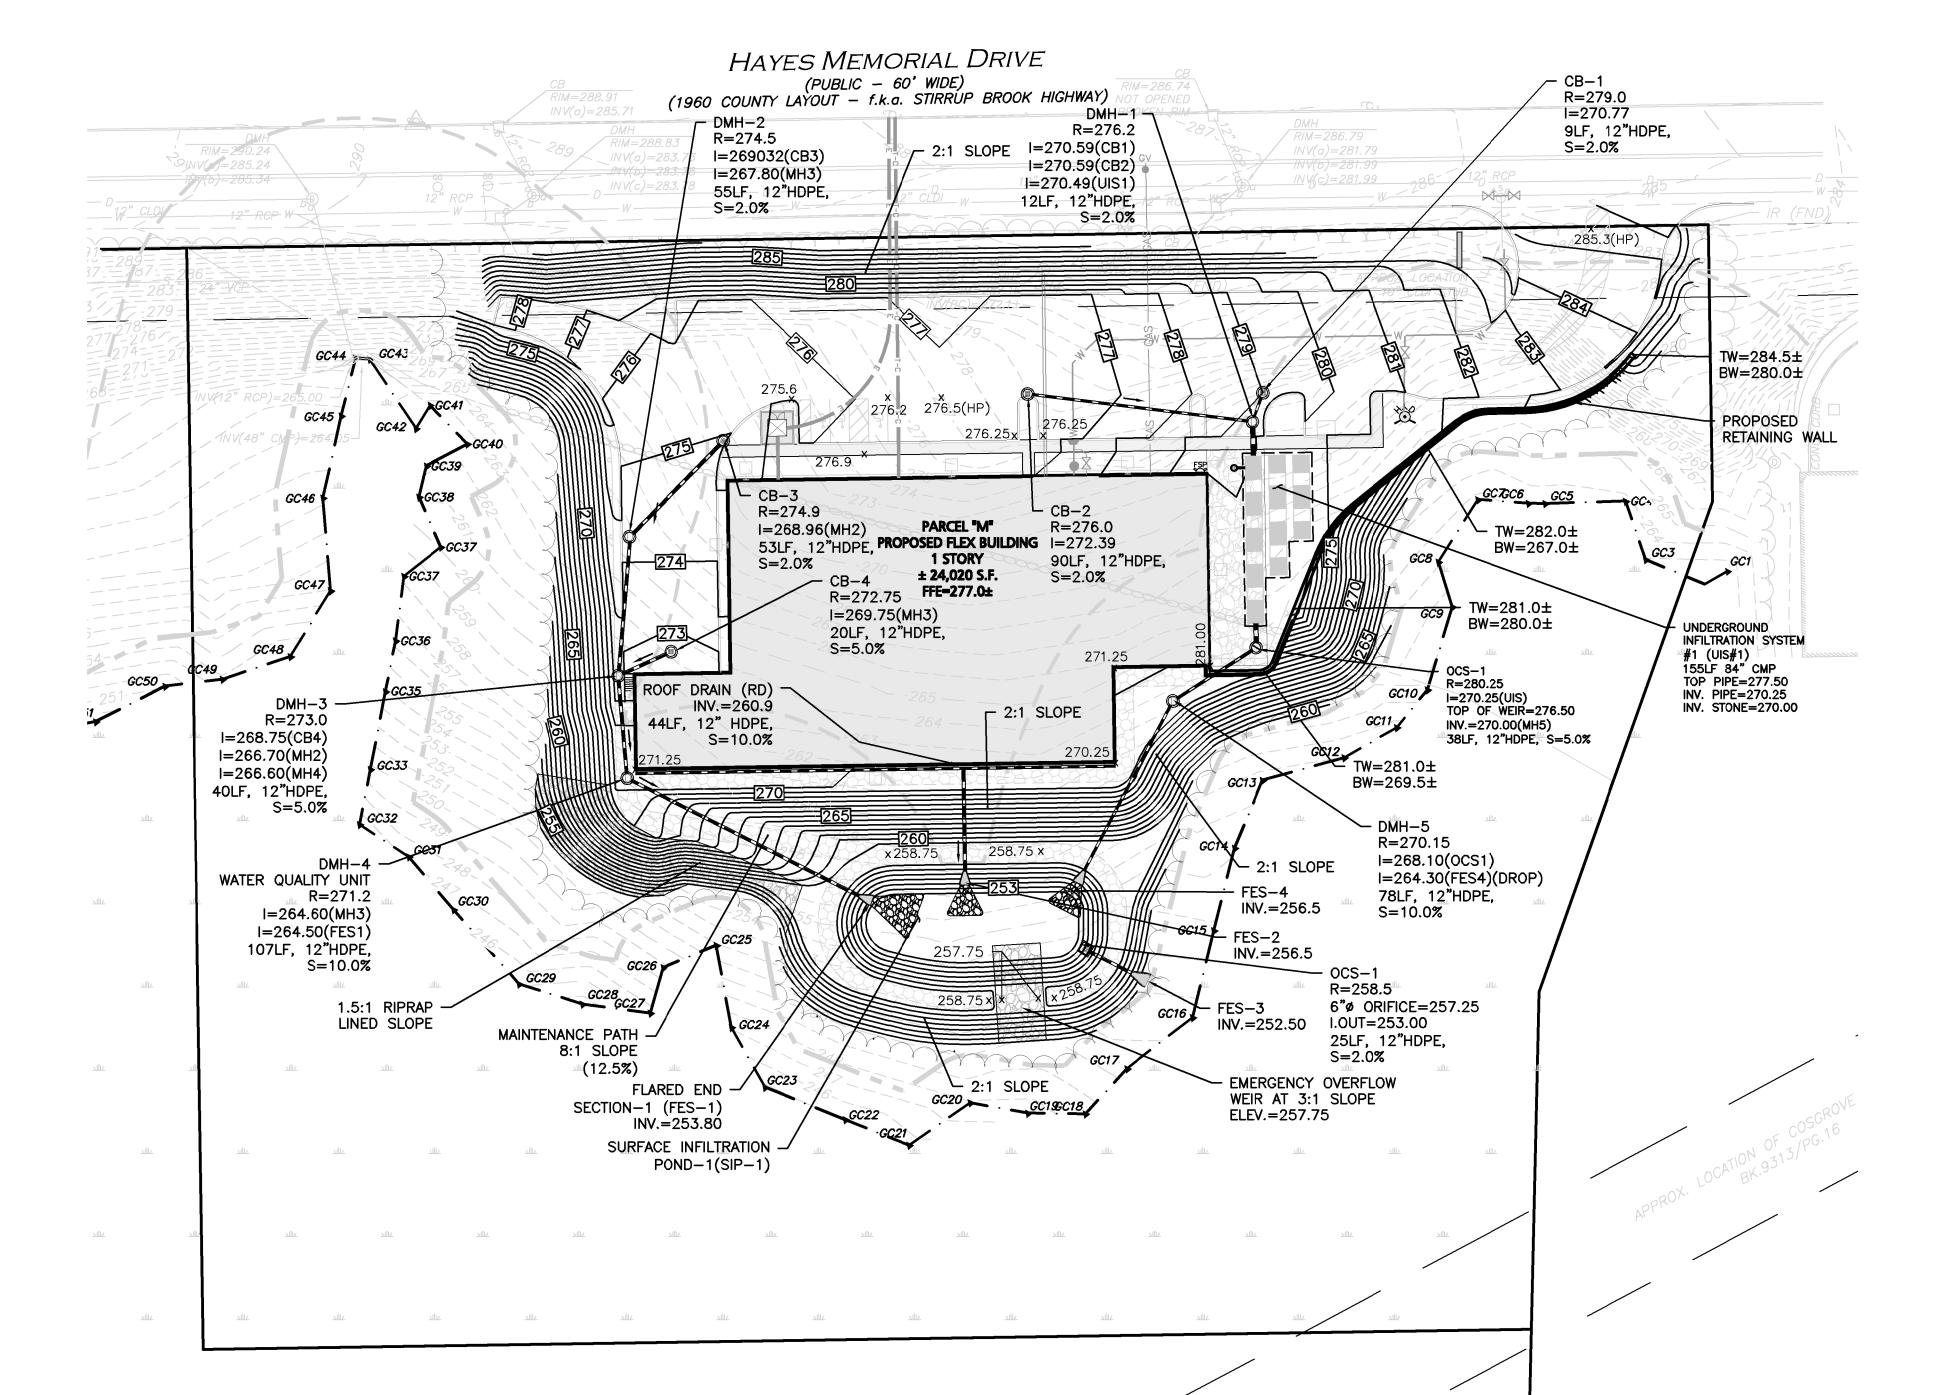



### **LEGEND** SEWER MANHOLE SEWER VENT SEWER LINE CONCRETE PIPE ENCASEMENT WATER LINE WATER VALVE HYDRANT WATER LINE REDUCER GAS LINE GAS VALVE LIGHT FIXTURE UTILILTY POLE ELECTRICAL CONDUIT OVERHEAD WIRE

TIE PROPOSED 8" CLDI WATER

WATER STUB. USE WATERLINE

REDUCER TO REDUCE FROM

10"ø TO 8"ø. COORDINATE

INSTALLATION WITH THE

MARLBORO DPW.

- WATER GATE

VALVE

CORE HOLE AT EXISTING SMH

 $RIM=287.19\pm(EXISTING)$ 

FINISHED GRADE

- PROPOSED GAS SERVICE

\_PURPOSES ONLY, GAS

MATERIAL OF SERVICE.

8"x8"x6" TEE

8% CLDI

WATERLINE

PROVIDER TO DETERMINE

PROP.  $RIM=283.6\pm$ 

| IN=272.18(BUILDING)

SHOWN FOR COORDINATION

FINAL LOCATION, SIZE AND

RIM TO BE ADJUSTED TO

IN/OUT=272.18(EXISTING)

FOR PROPOSED BUILDING SEWER

SERVICE TO EXISTING 10" CLDI

3-WAY GATE VALVE

MARLBOROUGH DPW.

INSTALLATION WITH THE

45° BEND WITH

THRUST BLOCK

CONFIGURATION. COORDINATE


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TELE/CABLE CONDUIT

- 2. BUILDING SEWER SERVICE LOCATIONS TO BE BASED ON FINAL BUILDING PLANS. CONNECTION POINTS SHALL BE AS SHOWN HEREON.
- 3. PIPE DIMENSIONS ARE MEASURED FROM THE INSIDE FACE OF THE STRUCTURE.
- 4. NATURAL GAS DISTRIBUTION SHOWN HEREON ARE FOR COORDINATION PURPOSES ONLY. FINAL LAYOUT TO BE COORDINATED WITH UTILITY PROVIDER.
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- 6. ALL TRENCH WORK IN HAYES MEMORIAL DRIVE SHALL BE FILLED WITH FLOWABLE FILL.
- 7. WHEN WATER AND SEWER CROSSINGS ARE LESS THAN 18" VERTICAL AND/OR LESS THAN 10' HORIZONTAL, THE CROSSING SHALL BE ENCASED IN CONCRETE WITH FLOWABLE FILL.
- 8. SEWER INSTALLATION SHALL BE IN COMPLIANCE WITH THE CITY OF MARLBOROUGH ZONING BYLAWS CHAPTER 510 SEWERS AND MA DEP REVIEW OF SEWER LINE / WATER SUPPLY PROTECTION POLICY #: BRP/DWM/WS/P03-1.
- 9. ALL SEWER LINES AND APPURTENANCES SHALL BE DESIGNED AND CONSTRUCTED FOR MAXIMUM WATERTIGHTNESS.
- 10. SEWERS SHALL BE TESTED BY APPROVED METHODS WHICH WILL ACHIEVE TEST RESULTS FOR INFILTRATION AND EXFILTRATION OF LESS THAN 100 GALLONS / INCH DIAMETER / MILE / 24
- 11. A MINIMUM OF CLASS B BEDDING AS DEFINED BY WATER POLLUTION CONTROL FEDERATION (WPCF  $\mathsf{MOP} - \# 9)$  MANUAL OF PRACTICE NO. 9 — SEWER DESIGN AND CONSTRUCTION MUST BE USED FOR ALL PIPING.
- 12. SEWER CONNECTIONS (LATERALS AND HOUSE CONNECTIONS) SHALL BE RIGIDLY INSPECTED BY THE CITY OF MARLBOROUGH DPW AND CERTIFIED INSPECTION REPORTS SHALL BE SUBMITTED TO THE MA DEP.
- 13. APROXIMATE LOCATION OF FIRE DEPARTMENT KNOX BOX. PER MARLBOROUGH FIRE DEPARTMENT, KNOX BOXES TO CONTAIN ALL KEYS, INCLUDING: ENTRY KEYS, FIRE ALARM PANEL KEYS, RADIO BOX KEYS, SPRINKLER BOX KEYS, ETC. CONTRACTOR TO COORDINATE WITH ARCHITECT AND MARLBOROUGH FIRE DEPARTMENT FOR EXACT LOCATION ON OUTSIDE OF BUILDING.
- 14. PER MARLBOROUGH FIRE DEPARTMENT, FIRE DEPARTMENT CONNECTION IS TO BE A 4" DIA., STORTZ STYLE, WITH A 30 DEGREE DOWN ANGLE. CONTRACTOR TO COORDINATE WITH MEP ENGINEER.
- 15. PER MARLBOROUGH FIRE DEPARTMENT, FIRE ALARM MASTER RADIO BOX TO BE LOCATED IN CLUBHOUSE BUILDING. CONTRACTOR TO COORDINATE WITH MARLBOROUGH FIRE DEPARTMENT, ARCHITECT, AND MEP ENGINEER FOR LOCATION AND REQUIRMENTS. PER MARLBOROUGH FIRE DEPARTMENT, FIRE ALARM MASTER RADIO BOX TO BE A 16 ZONE BOX, EITHER KING FISHER RADIO BOX FROM MAMMOTH FIRE COMPANY OR DIGITIZE RADIO BOX FROM RB ALLEN COMPANY. THERE ARE 4 RESIDENTIAL BUILDINGS AND THE CLUBHOUSE BUILDING WITH THE FOLLOWING RADIO BOX ZONE BREAKDOWNS: 1 ZONE PER BUILDING FOR FIRE ALARM NOTIFICATION, 1 ZONE PER BUILDING FOR WATER FLOW, 1 ZONE PER BUILDING FOR CARBON MONOXIDE ALARM.
- 16. REFERENCE PLUMBING PLANS FOR FIRE DEPARTMENT CONNECTIONS AT BUILDINGS.
- 17. ALL HYDRANT BRANCHES SHALL BE SIX (6) INCH CAST IRON.
- 18. SEE DETAIL SHEET(S) FOR ADDITIONAL CITY OF MARLBOROUGH SEWER AND WATER NOTES.
- 19. CITY OF MARLBOROUGH STANDARDS REQUIRES SEWER MAINS GREATER THAN 10' DEPTH TO BE DUCTILE IRON.
- 20. THE CONTRACTOR SHALL OBTAIN A STREET OPENING PERMIT PRIOR TO ANY CONSTRUCTION WITHIN THE CITY RIGHT-OF-WAY.
- 21. ALL WATER AND SEWER MATERIAL AND CONSTRUCTION SHALL CONFORM TO CITY OF MARLBOROUGH REQUIREMENTS (SEE STREET OPENING PERMIT).
- 22. ALL WATER AND SEWER CONSTRUCTION SHALL BE INSPECTED BY THE CITY OF MARLBOROUGH BEFORE BACKFILLING.
- 23. THE CITY SHALL BE NOTIFIED AT LEAST 24 HOURS PRIOR TO THE REQUIRED INSPECTIONS.

( IN FEET ) 1 inch = 40 ft.

GRAPHIC SCALE

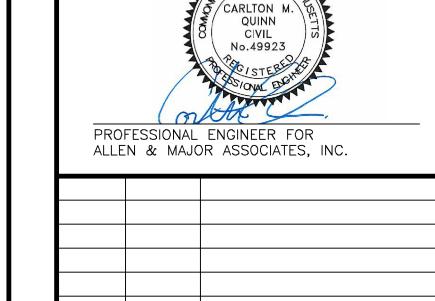

2020-06-05 REVISED PER CITY COMMENTS REV DATE DESCRIPTION

APPLICANT\OWNER:

THE GUTIERREZ COMPANY 200 SUMMIT DRIVE, SUITE 400 **BURLINGTON, MA 01803** 

PROJECT:

PARCEL M DEVELOPMENT HAYES MEMORIAL DRIVE MARLBOROUGH, MA

PROJECT NO.	1145-10A	DATE:	04-17-2020
SCALE:	1" = 401	DWG. NAME:	C-1145-10A
DESIGNED BY:	DMR	CHECKED BY:	CMQ



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WOBURN MA 01801 TEL: (781) 935-6889 FAX: (781) 935-2896

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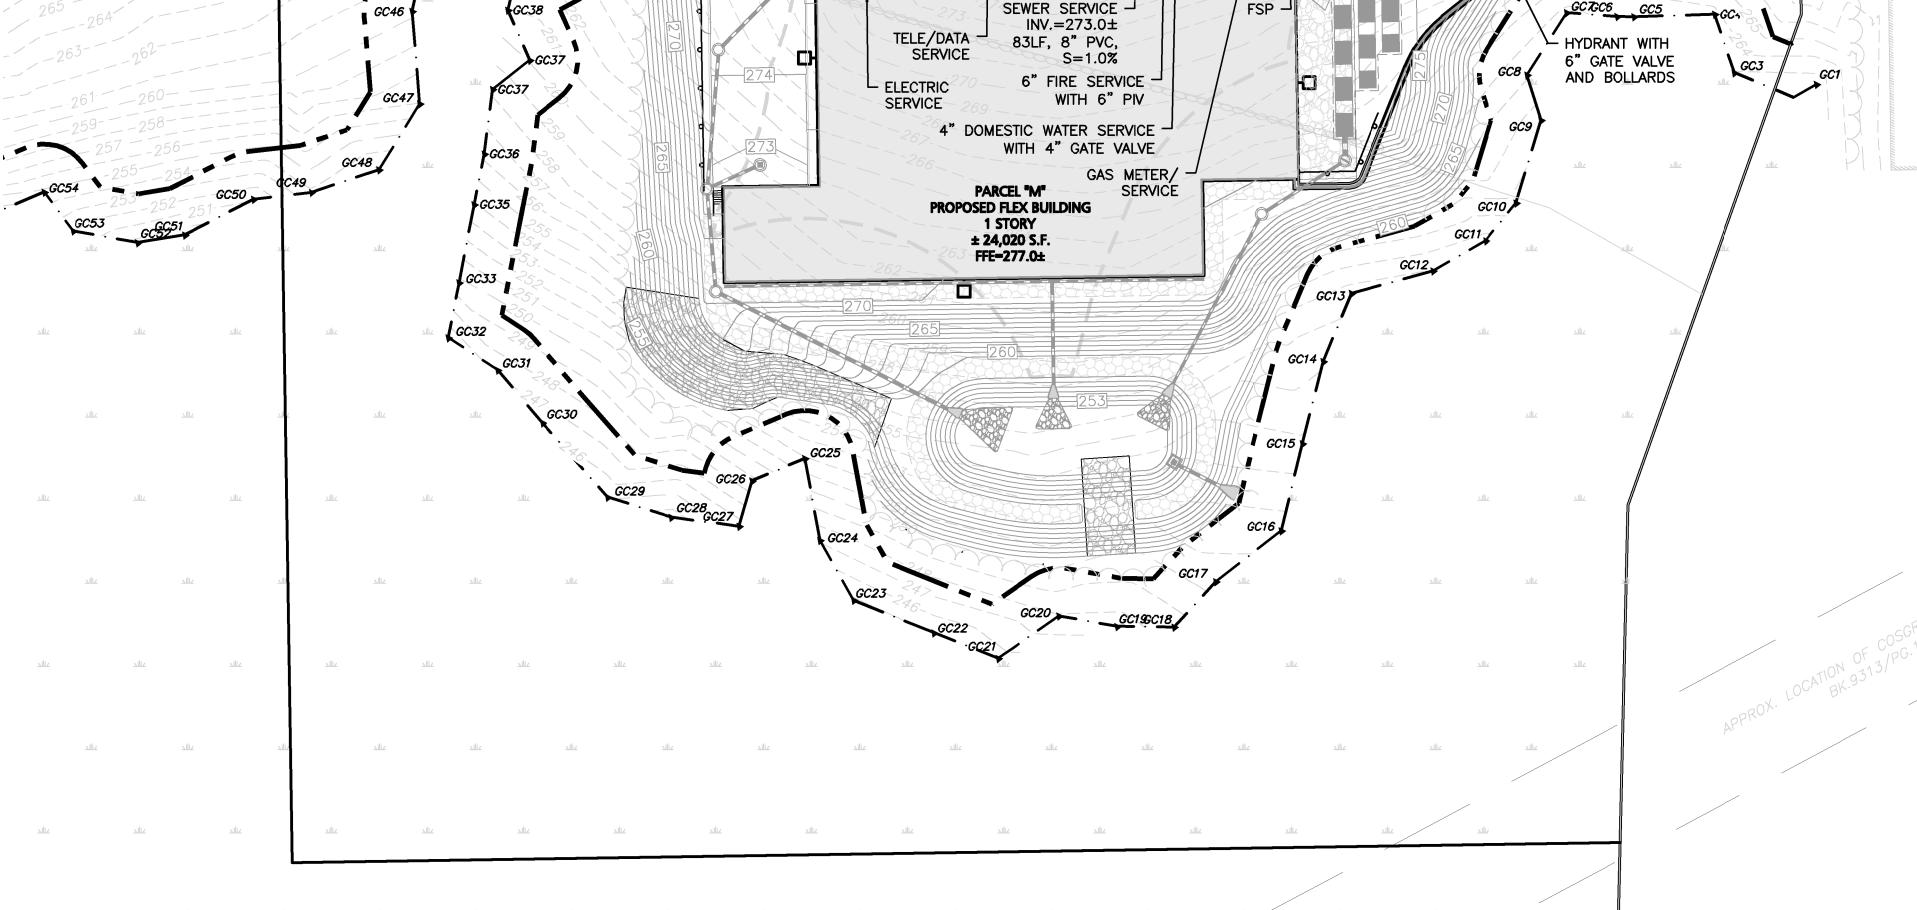
DRAWING TITLE:

SHEET No.

**UTILITIES PLAN** 

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C-104



HAYES MEMORIAL DRIVE

(PUBLIC - 60' WIDE)

(1960 COUNTY LAYOUT - f.k.a. STIRRUP BROOK HIGHWAY)

45° BEND WITH

THRUST BLOCK

INSTALL RISER ON EXISTING -

**TELECOMMUNICATIONS** 

SERVICE PROVIDER TO

SIZE AND MATERIAL OF

ELECTRICAL &

SERVICE.

REDUCE WATER -

SERVICE FROM 8"

UTILITY POLE FOR PRIMARY

CONNECTIONS. RUN ELECTRIC

AND TEL-DATA UNDERGROUND

TO TRANSFORMER AS SHOWN

DETERMINE FINAL LOCATION,

PROPOSED TRANSFORMER

FINAL LOCATIONS TO BE

COMPANY REQUIREMENTS


CONFIRMED BY MEP AND UTILITY


GC45

BEFORE YOU DIG CALL 811 OR

1-888-DIG-SAFE

1-888-344-7233

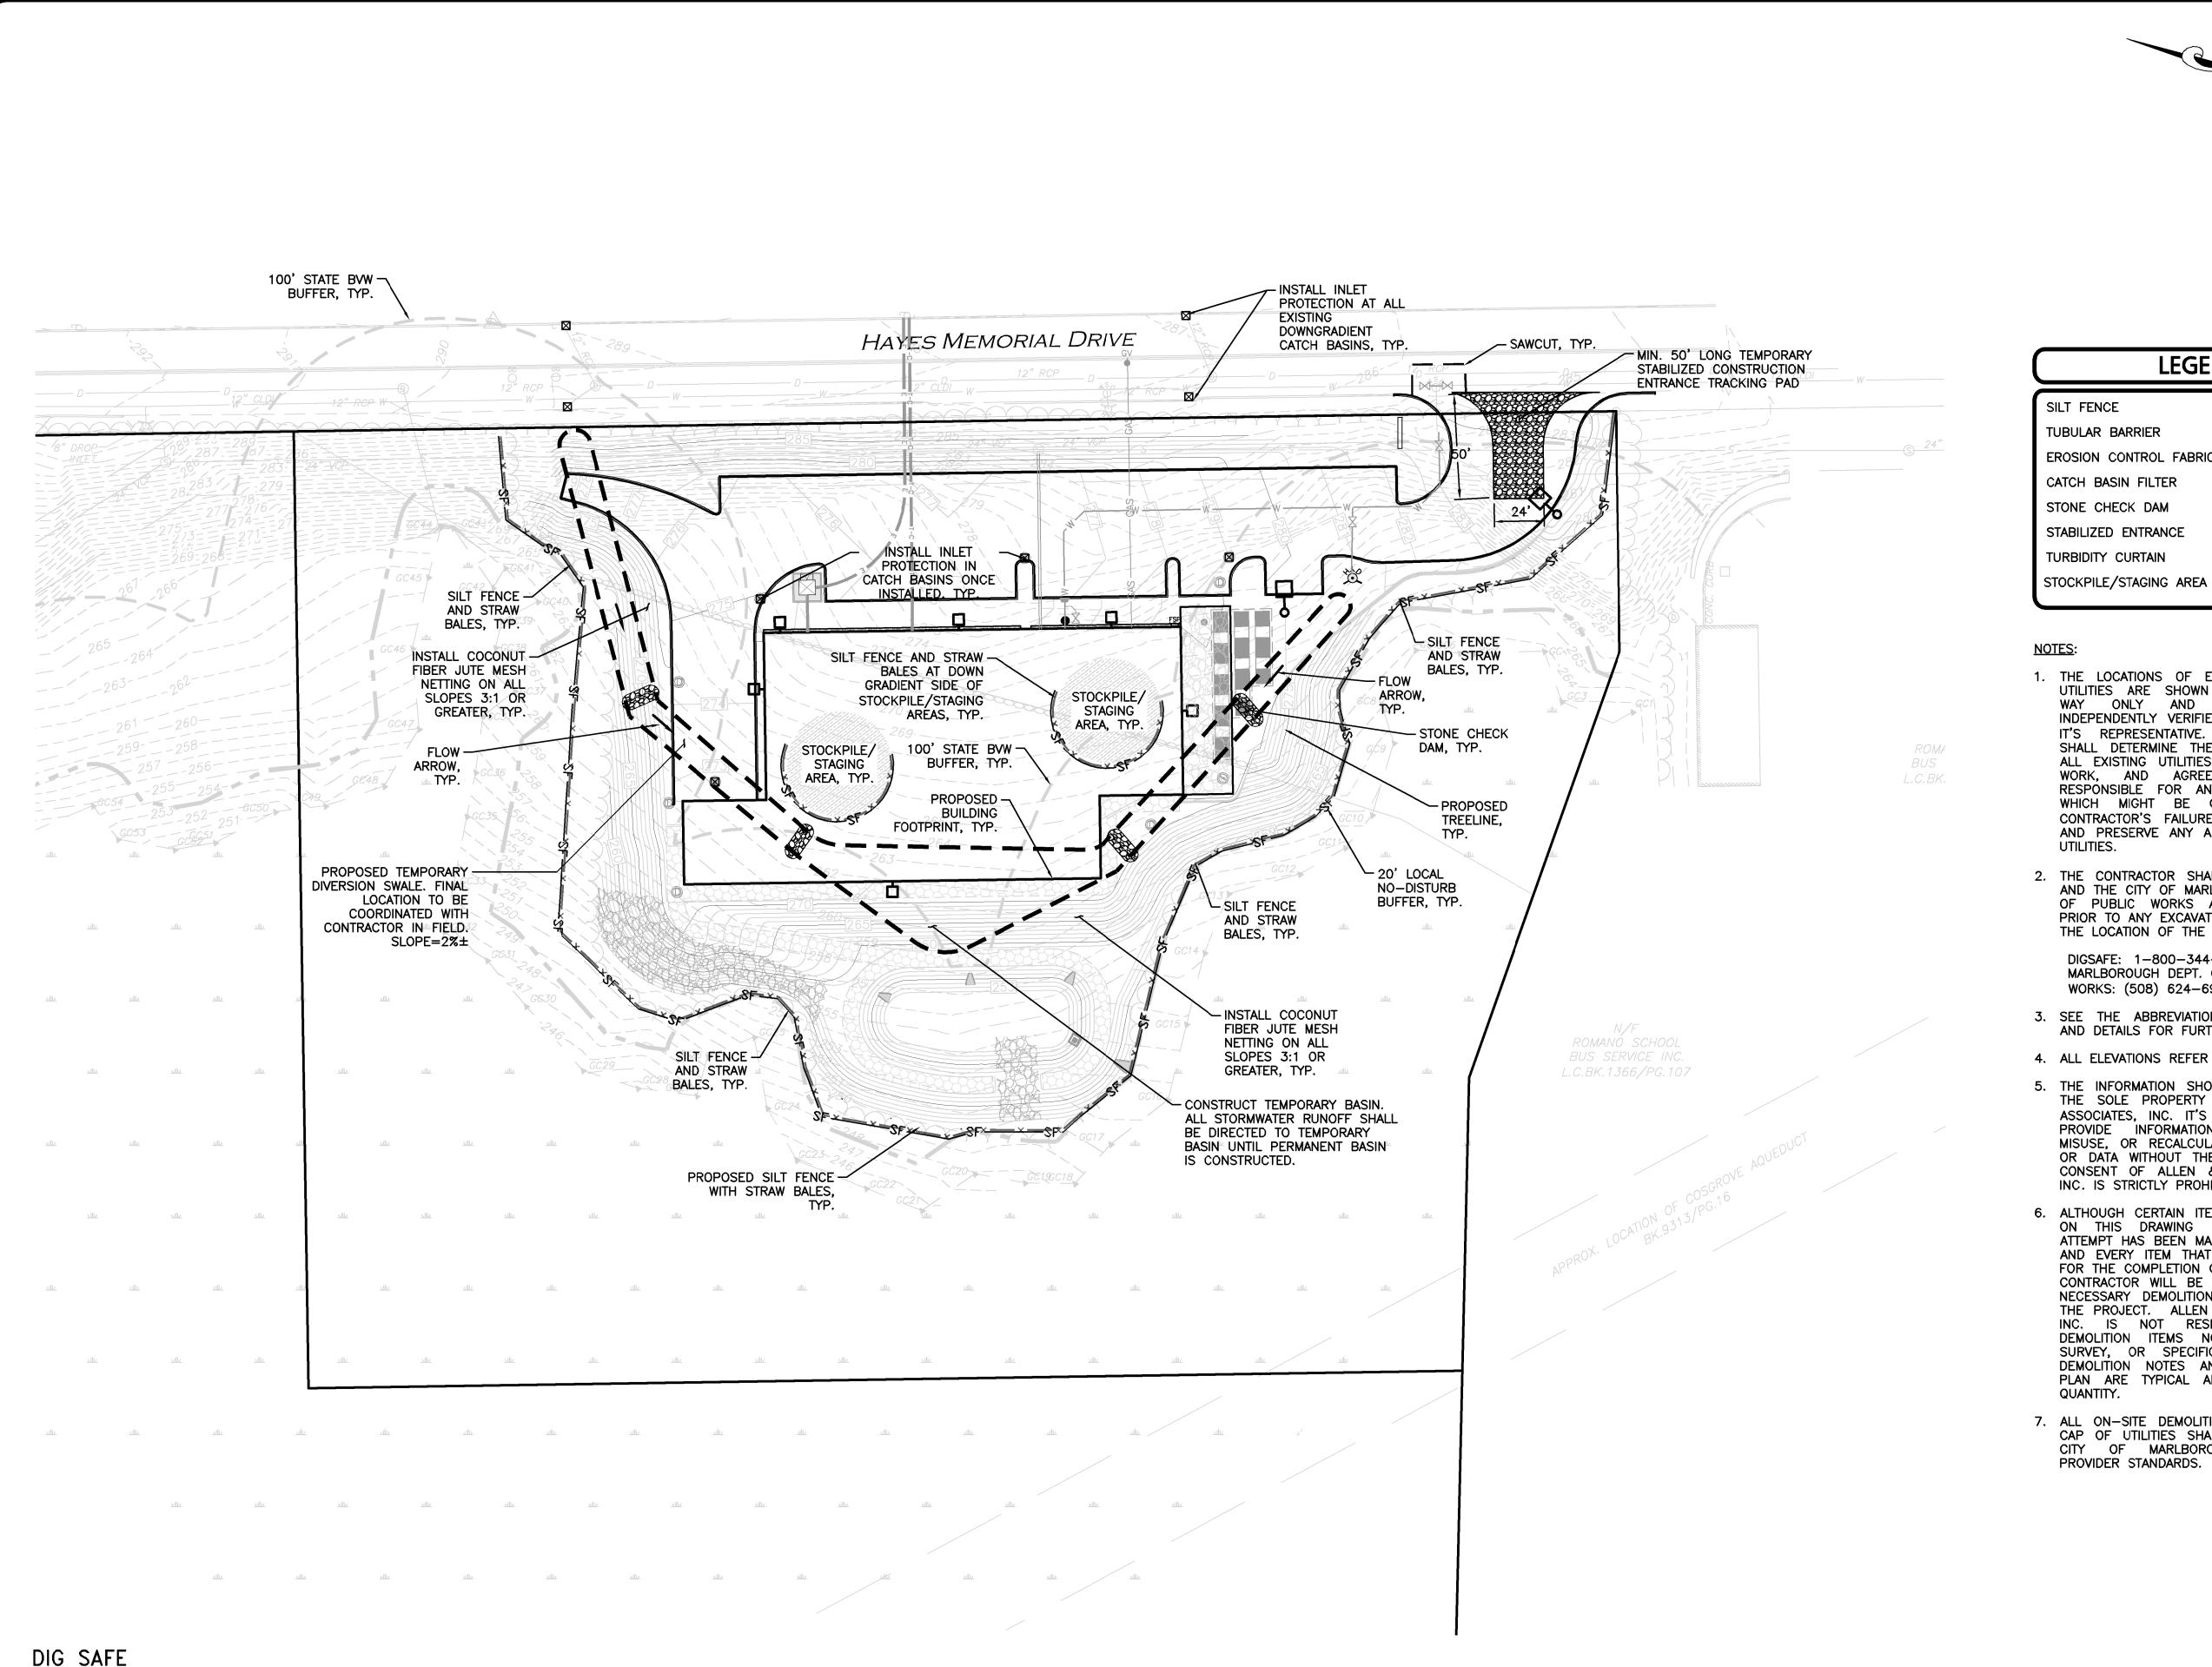

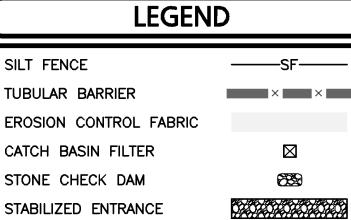

——TC——


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- 2. THE CONTRACTOR SHALL CONTACT "DIGSAFE" AND THE CITY OF MARLBOROUGH DEPARTMENT OF PUBLIC WORKS AT LEAST 72 HOURS PRIOR TO ANY EXCAVATION WORK TO REQUEST THE LOCATION OF THE EXISTING UTILITIES.

DIGSAFE: 1-800-344-7233 MARLBOROUGH DEPT. OF PUBLIC WORKS: (508) 624-6910

- 3. SEE THE ABBREVIATIONS AND NOTES PLAN AND DETAILS FOR FURTHER INFORMATION.
- 4. ALL ELEVATIONS REFER TO NAVD88 DATUM.
- 5. THE INFORMATION SHOWN ON THIS PLAN IS THE SOLE PROPERTY OF ALLEN & MAJOR ASSOCIATES, INC. IT'S INTENDED USE IS TO PROVIDE INFORMATION. ANY ALTERATION. MISUSE, OR RECALCULATION OF INFORMATION OR DATA WITHOUT THE EXPRESSED, WRITTEN CONSENT OF ALLEN & MAJOR ASSOCIATES, INC. IS STRICTLY PROHIBITED.
- 6. ALTHOUGH CERTAIN ITEMS HAVE BEEN NOTED ON THIS DRAWING FOR DEMOLITION, NO ATTEMPT HAS BEEN MADE TO DELINEATE EACH AND EVERY ITEM THAT REQUIRES DEMOLITION FOR THE COMPLETION OF THE PROJECT. THE CONTRACTOR WILL BE RESPONSIBLE FOR ALL NECESSARY DEMOLITION WORK TO COMPLETE THE PROJECT. ALLEN & MAJOR ASSOCIATES. INC. IS NOT RESPONSIBLE FOR SITE DEMOLITION ITEMS NOT SHOWN ON THE SURVEY, OR SPECIFICALLY NOTED. THE DEMOLITION NOTES AND ARROWS ON THIS PLAN ARE TYPICAL AND DO NOT REFLECT QUANTITY.
- 7. ALL ON-SITE DEMOLITION INCLUDING CUT & CAP OF UTILITIES SHALL BE PERFORMED TO CITY OF MARLBOROUGH AND SERVICE PROVIDER STANDARDS.



( IN FEET ) 1 inch = 40 ft.

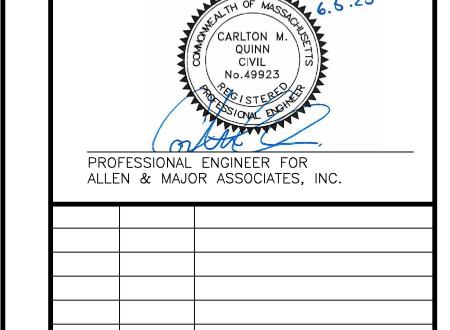

2020-06-05 REVISED PER CITY COMMENTS DATE DESCRIPTION REV

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THE GUTIERREZ COMPANY 200 SUMMIT DRIVE, SUITE 400 BURLINGTON, MA 01803

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**DRAWING TITLE:** 

**EROSION CONTROL PLAN** 

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C-101

SHEET No.

#### GENERAL LAWN MIX

	90%
FESTUCA RUBRA CREEPING RED 37% 95% "RUBRA" FESCUE	
PAO PRAENTENSIS BARON KENTUCKY 40% 85% "BARON" BLUEGRASS	90%
LOLIUM PERENNE PALMER PERENNIAL 15% 95% "PALMER" RYEGRASS	90%
FESTUCA RUBRA WILMA CHEWINGS 8% 95% COMMUTATA WILMA	80%

1. SEED TO BE SPREAD AT MINIMUM RATE OF 5 LBS. PER 1000 SQ. FT.

2. ALL SEEDING (INCLUDING NEW ENGLAND WETLAND MIX SEEDS) TO BE COMPLETED "IN SEASON" BETWEEN APRIL 1 TO JUNE 15 OR AUGUST 15 TO OCTOBER 1, EXCEPT FOR RE-SEEDING OF BARE SPOTS. AT ALL SLOPED AREAS CONTRACTOR TO INSTALL COCONUT FIBER JUTE MESH NETTING ON ALL SLOPES 3:1 AND OVER, HYDROSEED ALL EXPOSED AREAS, ADD SOIL STABILIZER "FLUX TERRA HP-FGM SOIL STABILIZER" AS MANUFACTURED BY "PROFILE" TO HYDROSEED (AT RATE OF 3,000 LBS PER ACRE), AT NO ADDITIONAL COST TO THE OWNER. CONTRACTOR TO ALSO BE RESPONSIBLE FOR RE-GRADING AND RE-SEEDING ALL DISTURBED, ERODED, OR BARE SPOTS AT NO ADDITIONAL COST TO OWNER & UNTIL SLOPES ARE FULLY STABLE. CONTRACTOR RESPONSIBLE FOR ALL MAINTENANCE UNTIL FINAL ACCEPTANCE OF LAWN AREAS INCLUDING: WATERING, ADDING FERTILIZERS AND LIME AND MOWING AT NO ADDITIONAL COST TO OWNER. AFTER SEEDING, SEEDED AREAS TO BE LIGHTLY MULCHED WITH WEED FREE STRAW & CONTINUALLY WATERED EVERY DAY FOR 2 MONTHS (USE NO HAY) SO THAT SEED IS KEPT MOIST.

3. COMMERCIAL FERTILIZER SHALL BE APPLIED AT THE RATE OF 25 POUNDS PER 1000 SQ. FT. OR AS RECOMMENDED BY THE TESTING AGENCY. LIME TO BE SPREAD AT THE RATE OF 100 POUNDS PER 1000 SQ. FT OR AS RECOMMENDED BY THE TESTING AGENCY. COMMERCIAL FERTILIZER SHALL BE A COMPLETE FERTILIZER CONTAINING AT LEAST 50% OF THE NITROGEN OF WHICH IS DERIVED FROM NATURAL ORGANIZE SOURCES OF UREAFORM. IT SHALL CONTAIN THE FOLLOWING PERCENTAGES BY WEIGHT: NITROGEN (N) 10%, PHOSPHORUS (P) 6%. POTASH (K) 4%. LIME SHALL BE AN APPROVED AGRICULTURAL LIMESTONE CONTAINING NOT LESS THAN 85% OF TOTAL CARBONÀTES. LIMESTONE SHALL BE GROUND TO SUCH FINENESS THAT 50% WILL PASS A 100 MESH SIEVE AND 90% WILL PASS THROUGH A 20 MESH SIEVE.

4.LAWN AREAS TO BE SEEDED BY SOWING EVENLY WITH AN APPROVED MECHANICAL SEEDER AT THE RATE OF TEN POUNDS PER 1000

5. CONTRACTOR RESPONSIBLE FOR WATERING, MOWING, AND RESEEDING OF LAWN BARE SPOTS UNTIL A UNIFORM, HEALTHY STAND OF GRASS IS ESTABLISHED AND ACCEPTED.

#### ADDITIONAL SEED MIX SPECIFICATIONS FOR SLOPES AREAS (AS NOTED ON THE PLAN):

#### SEE NOTE #22 ON SHEET L-102 FOR RATE OF APPLICATION & ADDITIONAL INFORMATION

WWW.NEWP.COM OR

Ph: (413) 548-8000 | Fx: (413) 549-4000 | info@newp.com New England Wetland Plants, Inc. 820 West Street Amherst, MA 01002

NEW ENGLAND EROSION CONTROL / RESTORATION MIX FOR DRY SITES (BY NEW ENGLAND WETLAND PLANTS INC.)

- 1. UPLAND BENTGRASS
- ROUGH BENTGRASS/TICKLEGRASS
- 3. BLUE GRAMA
- 4. CANADA WILD RYE 5. CREEPING RED FESCUE
- 6. ANNUAL RYEGRASS (NATURALIZED) 7. PERRENIAL RYEGRASS (NATURALIZED)
- 8. LITTLE BLUESTEM 9. INDIAN GRASSS

AGROSTIS PERENNANS AGROSTIS SCABRA BOUTELOUA GRACILIS **ELYMUS CANADENSIS** FESTUCA RUBRA LOLIUM MULTIFLORUM LOLIUM PERENNE SCHIZACHYRIUM SCOPARIUM SORGHASTRUM NUTANS

#### EROSION CONTROL/RESTORATION MIX FOR DETENTION BASINS AND MOIST SITES (BY NEW ENGLAND WETLAND PLANTS INC):

- A. ELYMUS VIRGINICUS
- FESTUCA RUBRA SCHIZACHYRIUM SCOPARIUM
- ANDROPOGON GERARDII PANICUM VIRGATUM
- VERBENA HASTATA AGROSTIS SCABRA
- ASTER NOVAE—ANGLIAE
- EUPATORIUM MACULATUM EUPATORIUM PERFOLIATUM
- K. JUNCUS EFFUSUS L. SCIRPUS CYPERINUS
- CREEPING RED FESCUE LITTLE BLUESTEM **BIG BLUESTEM** SWITCH GRASS BLUE VERVAIN **ROUGH BENTGRASS** NEW ENGLAND ASTER SPOTTED JOE PYE WEED BONESET SOFT RUSH

WOOL GRASS

VIRGINIA WILD RYE

## **LEGEND**

PROPERTY LINE SIGN

PROP. BUILDING BUILDING ARCHITECTURE CURB

CONCRETE SIDEWALK

DECIDUOUS TREE

**EVERGREEN TREE** 

FLOWERING/ ORNAMENTAL TREE

MULCH BED

SHRUBS

PERENNIALS



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- 3. ALL LANDSCAPED AREAS WITH SHRUBS, TREES, AND PERENNIALS TO HAVE 18" MINIMUM DEPTH OF TOPSOIL. EIGHTEEN INCHES OF TOPSOIL AROUND TREES AND SHRUBS DOES NOT INCLUDE AMENDED PLANTING SOIL WITHIN TREE / SHRUB PIT FOR FULL DEPTH OF ROOTBALLS. SEE PLANTING DETAILS FOR PLANTING DEPTH AT SHRUBS AND TREES. ALL AREAS OF LOAM AND SEED OR LOAM & SOD TO HAVE 6" MINIMUM DEPTH OF TOPSOIL. TOPSOIL TO BE TESTED BY CONTRACTOR, AND APPROVED BY A&M PRIOR TO PURCHASE AND OR PLACEMENT. GENERAL CONTRACTOR, DEMOLITION CONTRACTOR. AND LANDSCAPE CONTRACTOR TO COORDINATE PROPER DEPTH OF EXISTING MATERIAL REMOVAL ACROSS SITE SO THAT 18" MINIMUM AND 6" MINIMUM DEPTHS OF PROPOSED TOPSOIL NOTED ABOVE ARE MET AT NO ADDITIONAL COST TO OWNER. SEE TOPSOIL
- <u>SEE SHEET L-102 FOR ADDITIONAL LANDSCAPE</u> **INFORMATION.**

1 inch = 40 ft.



1	2020-06-05	REVISED PER CITY COMMENTS
EV	DATE	DESCRIPTION

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BURLINGTON, MA 01803

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DESIGNED BY:	RB/DMR	CHECKED BY:	CM



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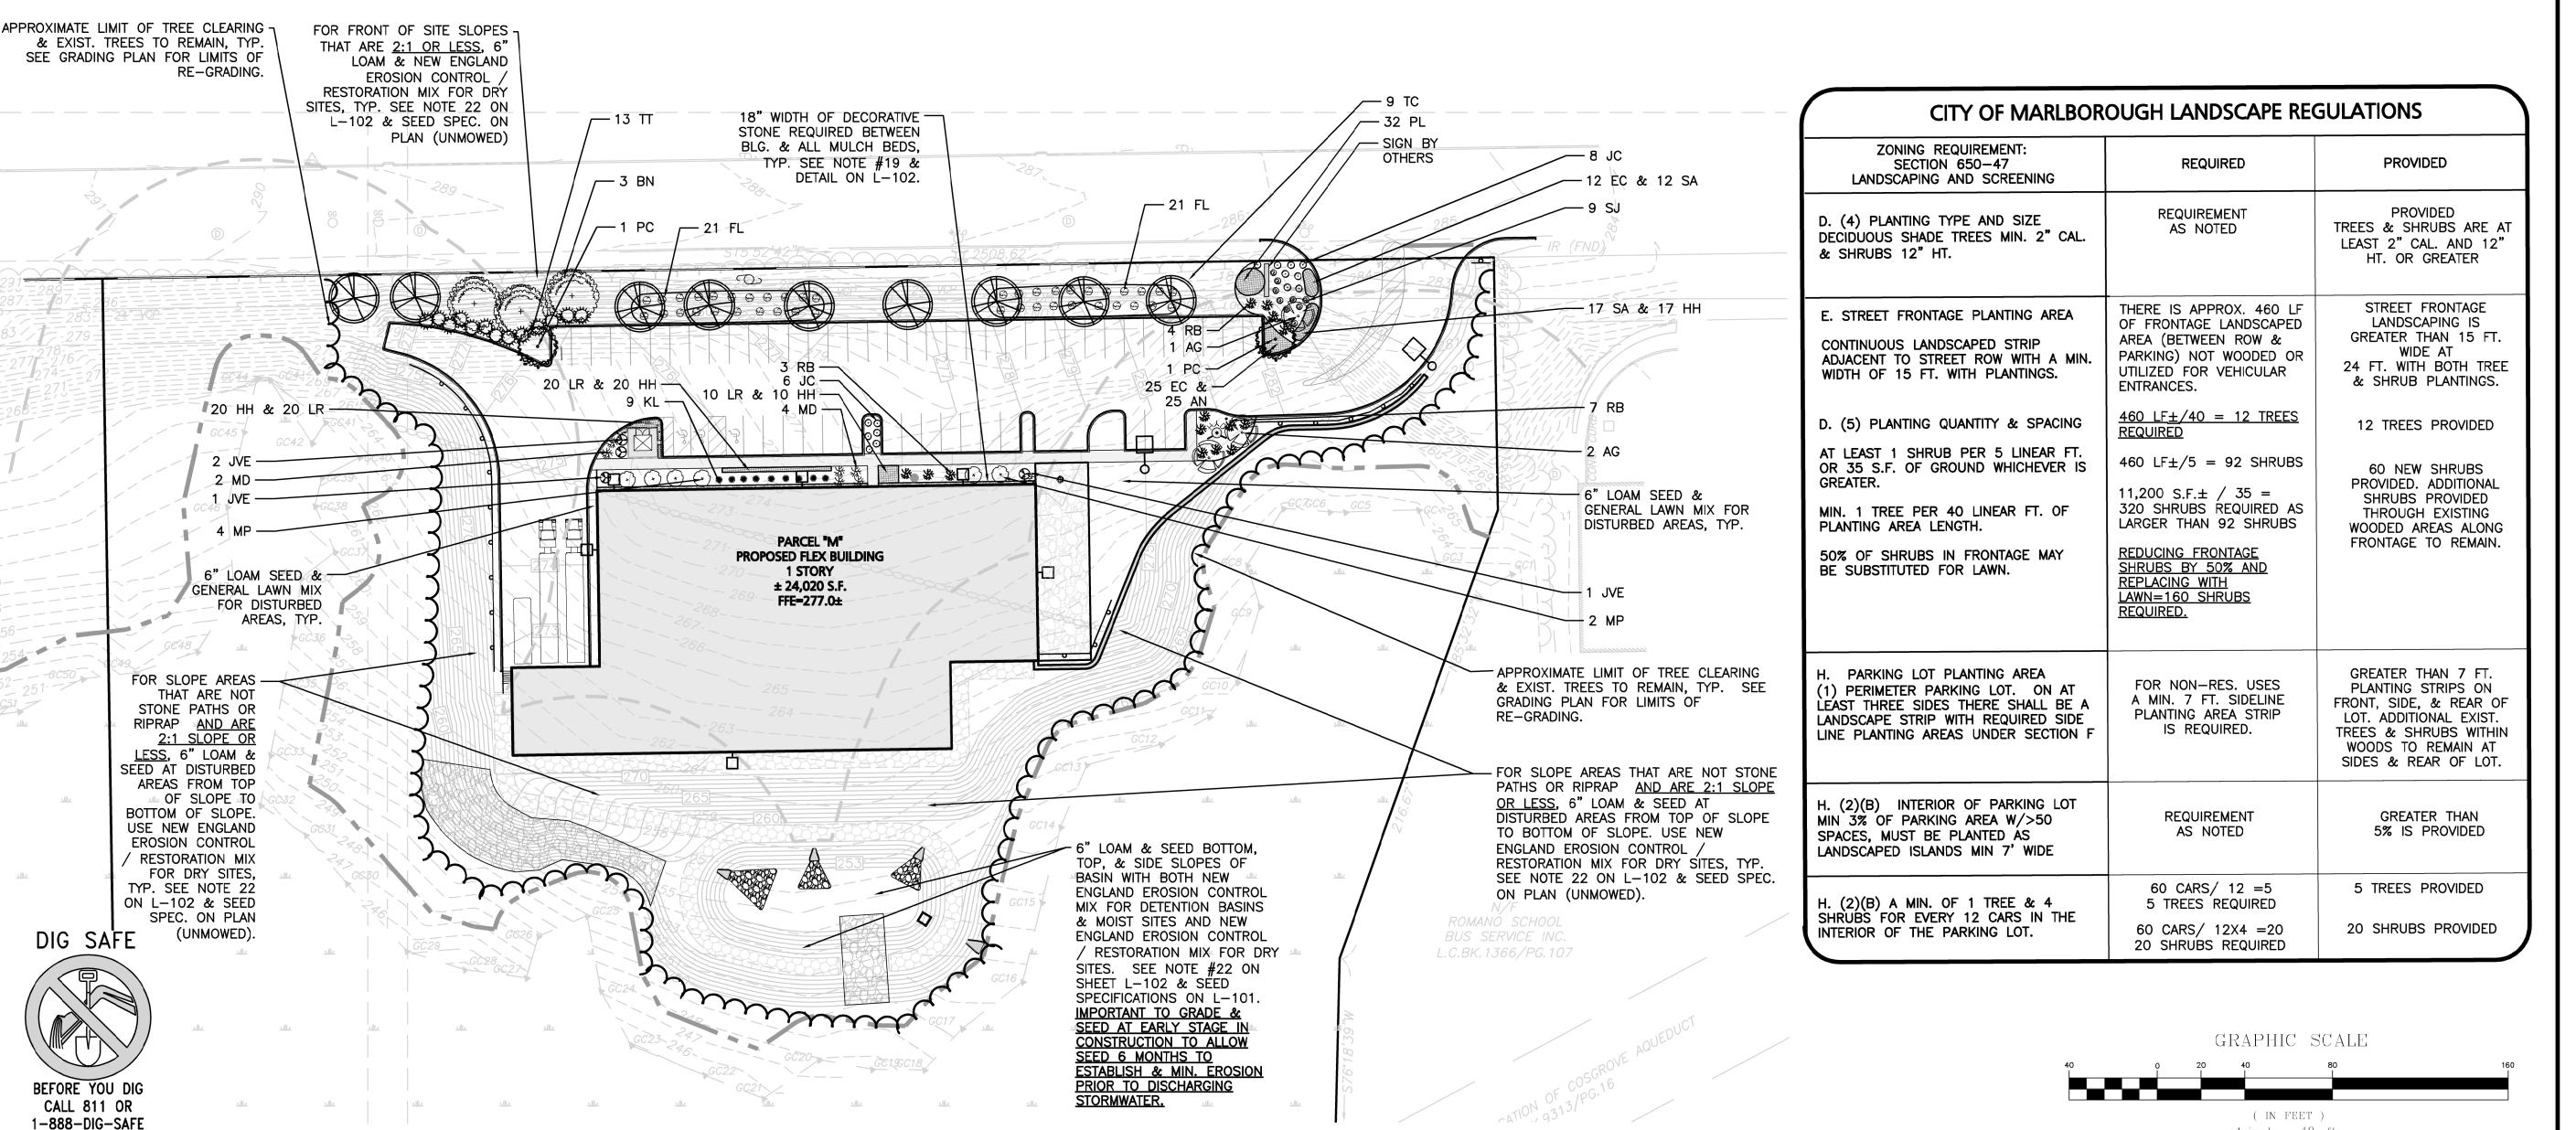
SHEET No.

L-101

**DRAWING TITLE:** 

LANDSCAPE PLAN

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-888-344-7233



PRIMARY SNOW STORAGE AREA

SECONDARY SNOW

STORAGE AREA

SNOW WILL BE STOCKPILED ON SITE UNTIL THERE IS NO ENOUGH SPACE. AS NECESSARY, THE SNOW WILL BE REMOVED AND DISPOSED OF OFF-SITE. IT WILL BE THE RESPONSIBILITY OF THE SNOW REMOVAL CONTRACTOR TO PROPERLY DISPOSE OF TRANSPORTED SNOW ACCORDING TO MASSACHUSETTS DEP BUREAU OF RESOURCE PROTECTION - MASSACHUSETTS DEPARTMENT OF ENVIRONMENTAL PROTECTION BUREAU O WATER RESOURCES SNOW DISPOSAL GUIDANCE EFFECTIVE DATE DECEMBER 23, 2019, GOVERNING THE PROPER DISPOSAL OF SNOW. IT WILL BE THE RESPONSIBILITY OF THE SNOW REMOVAL CONTRACTOR TO FOLLOW THESE GUIDELINES AND ALL APPLICABLE LAWS AND REGULATIONS.

APPROXIMATE TOTAL PRIMARY SNOW STORAGE AREA ON SITE:

APPROXIMATE TOTAL SECONDARY SNOW STORAGE AREA ON SITE: 1,650± S.F. (AS NEEDED)

TOTAL SNOW STORAGE AREA AVAILABLE ON-SITE: 5.300± S.F.

GC3

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PROFESSIONAL ENGINEER FOR ALLEN & MAJOR ASSOCIATES, INC.

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PARCEL M DEVELOPMENT HAYES MEMORIAL DRIVE MARLBOROUGH, MA

PROJECT NO.	1145-10A	DATE:	04-17-2020
SCALE:	1" = 40'	DWG. NAME:	C-1145-10A
DESIGNED BY:	DMR	CHECKED BY:	СМС



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SNOW STORAGE PLAN

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GRAPHIC SCALE ( IN FEET ) 1 inch = 40 ft.