

PROPOSED RENOVATION / CHANGE OF OCCUPANCY

FROM SINGLE FAMILY TO TWO FAMILY DWELLING

42 DEVENS STREET MARLBOROUGH, MA 01752

LOCATION MAP

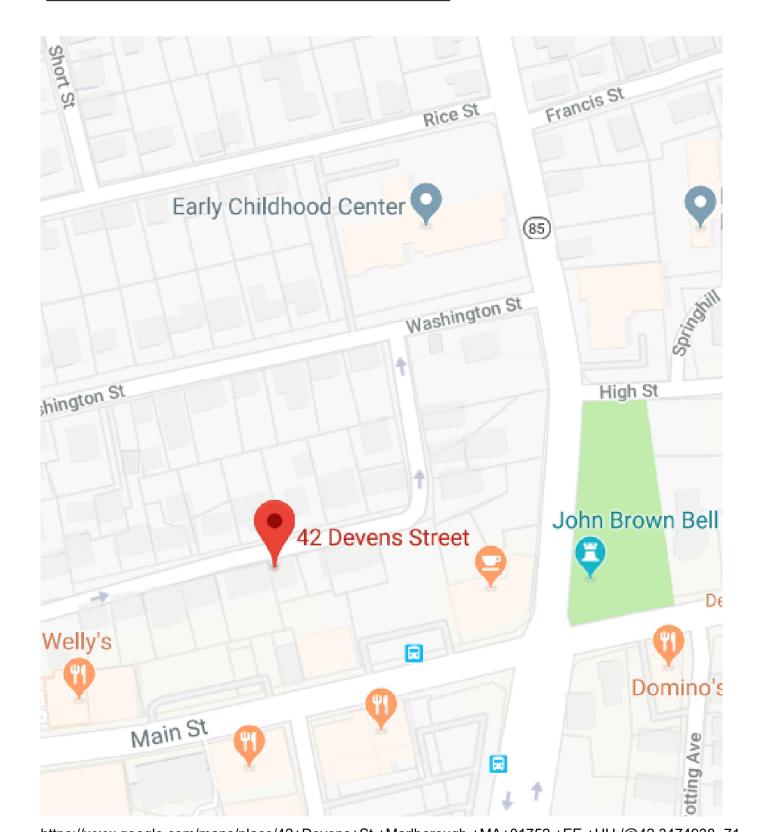

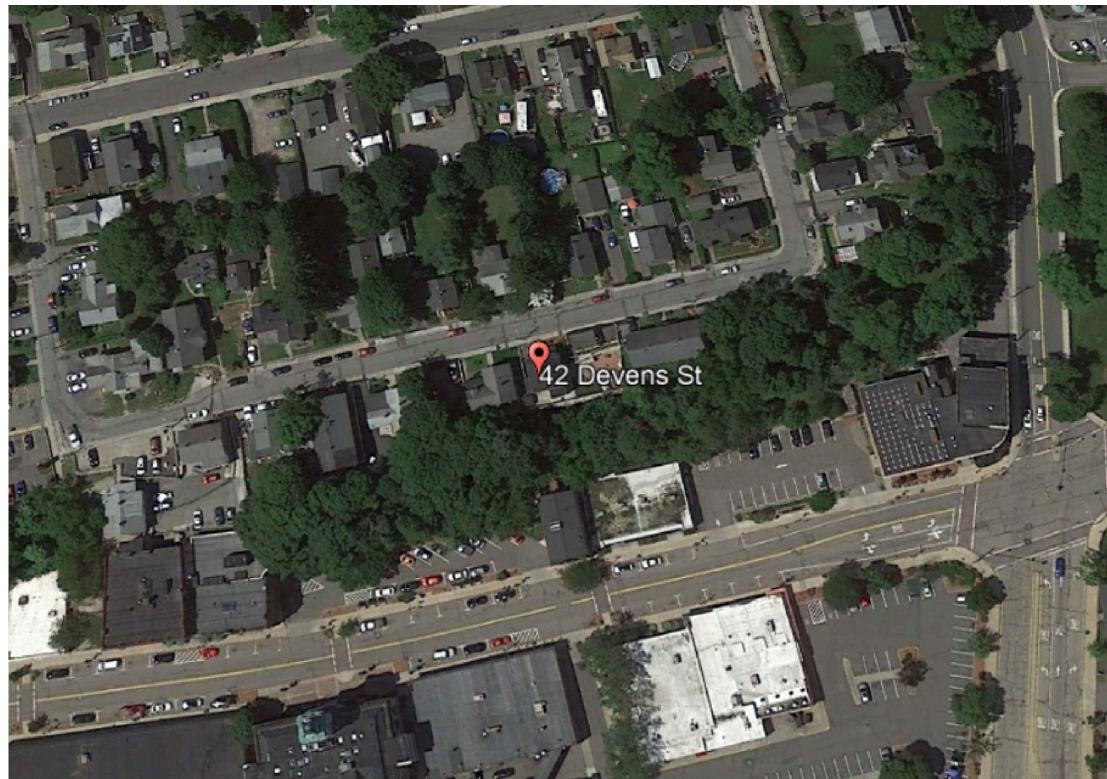

GOOGLE EARTH


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GENERAL NOTES

- 1. ALL WORK SHALL BE PERFORMED IN CONFORMANCE TO THE LATEST EDITION THE MASSACHUSETTS STATE BUILDING CODE AND ALL OTHER APPLICABLE CODES AND LAWS.
- 2. THE CONTRACTOR IS RESPONSIBLE FOR OBTAINING AND PAYING FOR ALL PERMI REQUIRED FOR THIS PROJECT.
- 3. THE CONTRACTOR IS SOLELY RESPONSIBLE FOR MEANS, METHOD
- TECHNIQUES, SEQUENCING, SCHEDULING AND SAFETY FOR THIS PROJECT.
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- 9. TAKE FIELD MEASUREMENTS BEFORE FABRICATION WORK TO ENSURE TH COMPONENTS FIT TOGETHER PROPERLY.

EXISTIN	G	PROPOSED			
SINGLE FAI	MII V	TWO FAMILY			
SINGLE FAI	VIIL I		UNIT 1	UNIT 2	
BASEMENT	615	BASEMENT	606 Sq. Ft.	0 Sq. Ft.	
1ST FLOOR	612	1ST FLOOR	843 Sq. Ft.	0 Sq. Ft.	
2ND FLOOR	616	2ND FLOOR	0 Sq. Ft.	771 Sq. Ft.	
TOTAL: 1,843 S	q. Ft.	ATTIC FLOOR	0 Sq. Ft.	780 Sq. Ft.	
		TOTAL: 3,000 Sq. Ft.			


GENERAL SYMBOLS

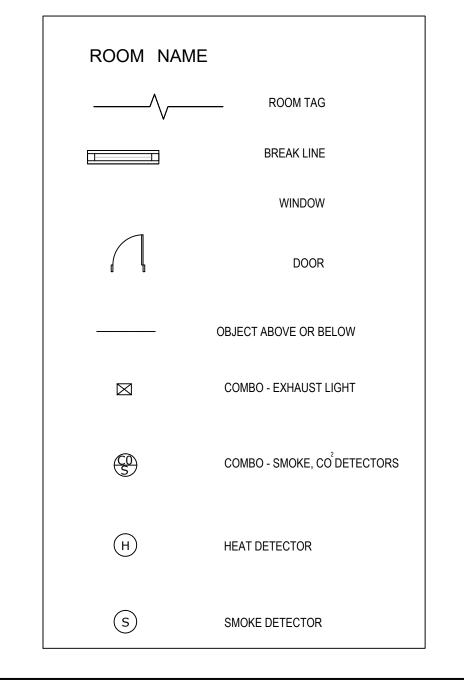

INDEX

_		
	A-0.0	COVER SHEET
	B-1.0	EXISTING CONDITIONS (BASEMENT / FIRST FLOOR)
	B-1.1	EXISTING CONDITIONS (SECOND / ROOF FLOOR)
	B-2.0	EXISTING CONDITIONS (FRONT / REAR / RIGHT / LEFT ELEVATION)
	A-0.1	PROPOSED CONDITIONS (DOOR / WINDOW SCHEDULE)
	A-1.0	PROPOSED CONDITIONS (BASEMENT / FIRST / SECOND FLOOR PLAN)
	A-1.1	PROPOSED CONDITIONS (ATTIC / ROOF FLOOR PLAN)
	A-2.0	PROPOSED CONDITIONS (FRONT / REAR / LEFT / RIGHT ELEVATION)
	S-0.0	CONSTRUCTION DETAILS (NOTES)
	S-1.0	CONSTRUCTION DETAILS
	S-1.1	CONSTRUCTION DETAILS (ROOF FRAMING PLANS / SECTION DETAILS
		PORCH FRAMING PLANS/ SECTION DETAILS)



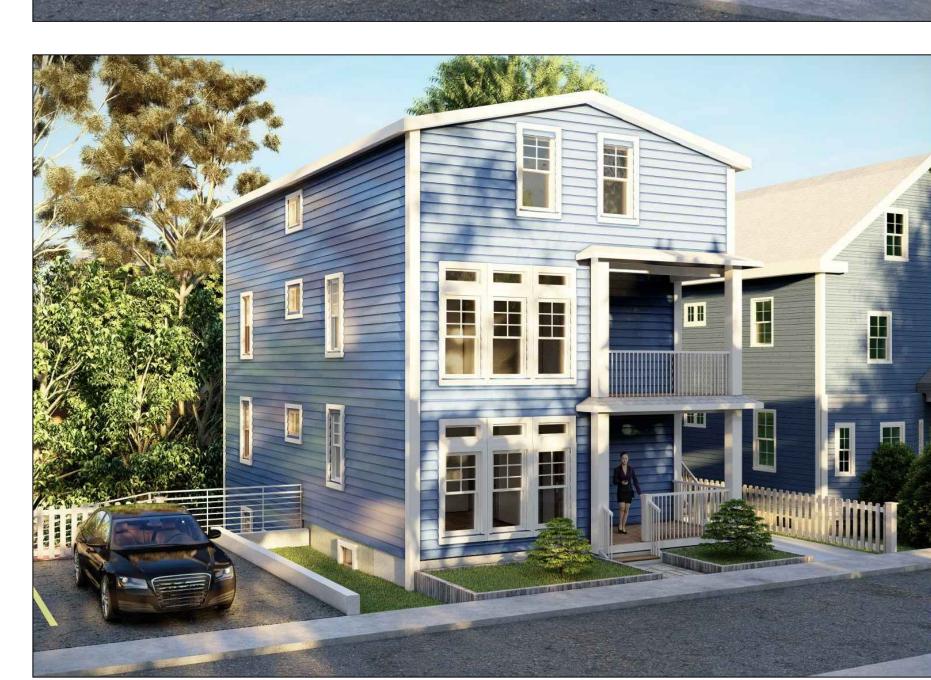



F OCCUPANCY FROM SINGLE FAMI TO TWO FAMILY DWELLING

APPLICANT: JUAN SOSA

LAYOUT BY: EBR

DRAWN: RH

CHECKED:

SCALE: AS INDICATED

DATE: 07/22/2021

PROJECT NO.: RDC/00211

REVISIONS: NOTES:



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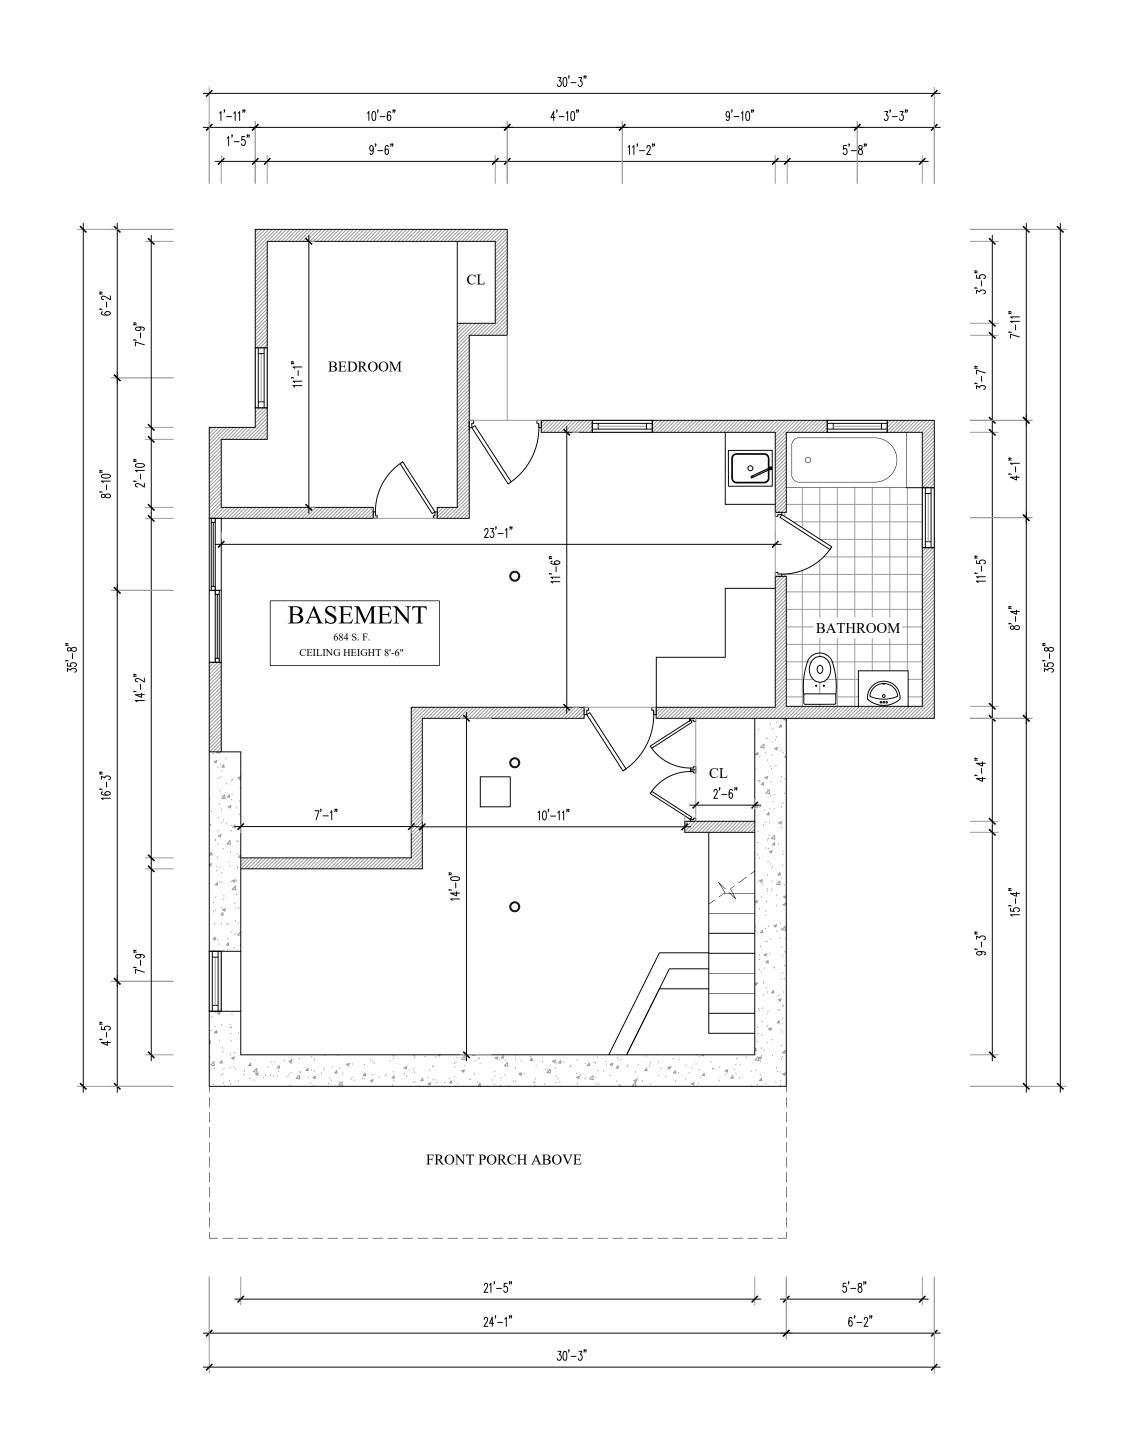
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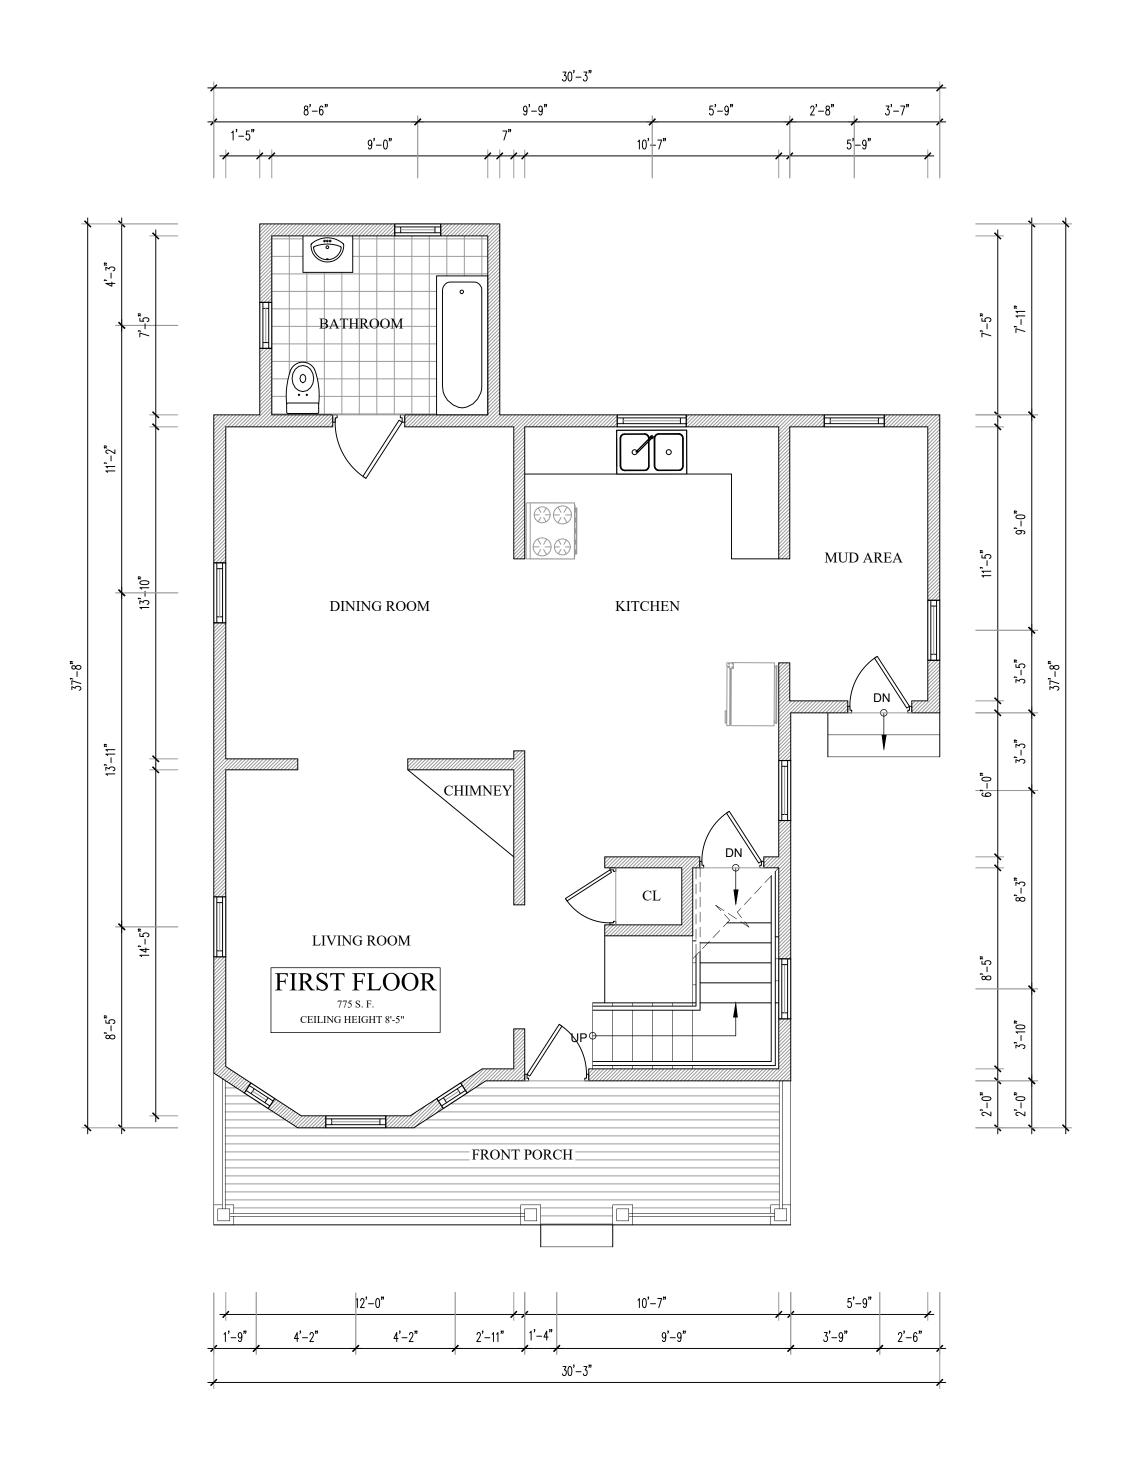
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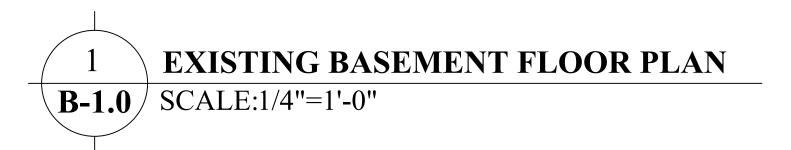
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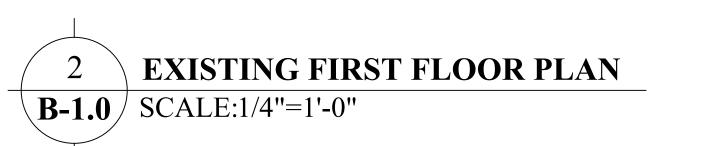
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ROPOSED RENOVATION / CHANGI OCCUPANCY FROM SINGLE FAMI TO TWO FAMILY DWELLING

42 DEVENS STREET MARLBOROUGH, MA 01752

APPLICANT: JUAN SOSA

LAYOUT BY: EBR

DRAWN: RH


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SCALE: AS INDICATED

DATE: 07/22/2021

PROJECT NO.: RDC/00211

REVISIONS: NOTES: DATE

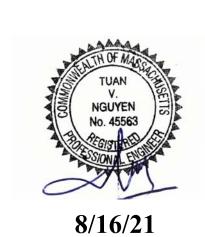


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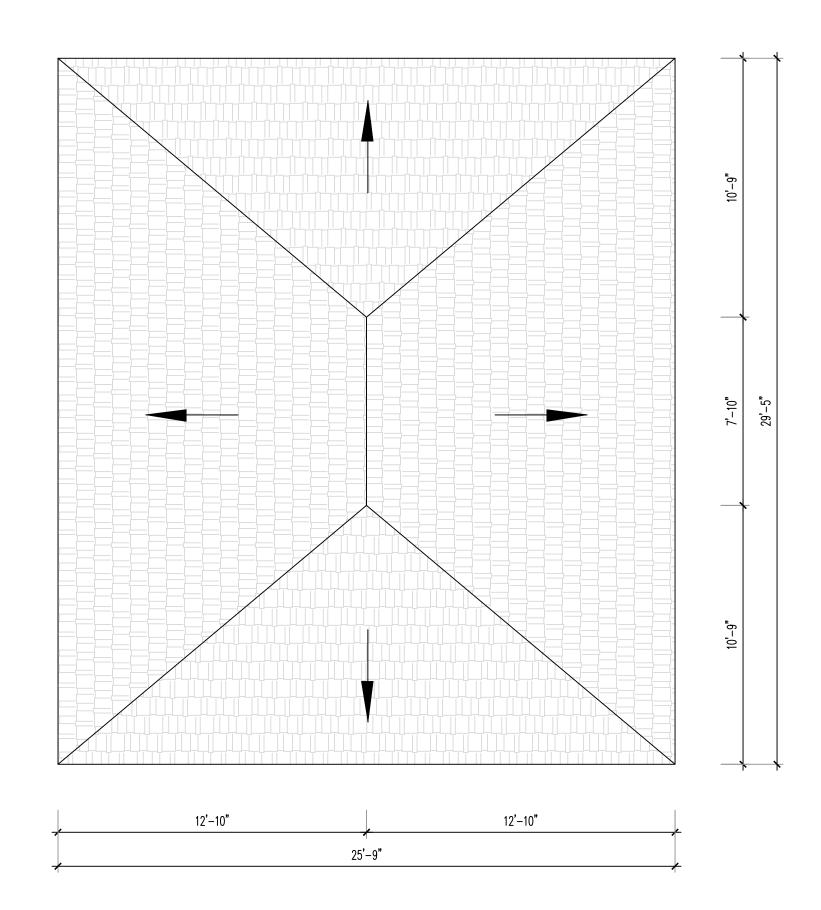
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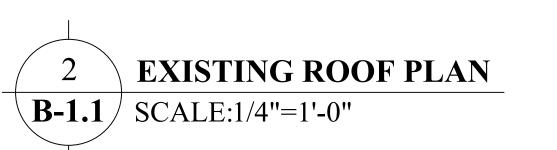
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B-1.0





1 EXISTING SECOND FLOOR PLAN
B-1.1 SCALE:1/4"=1'-0"



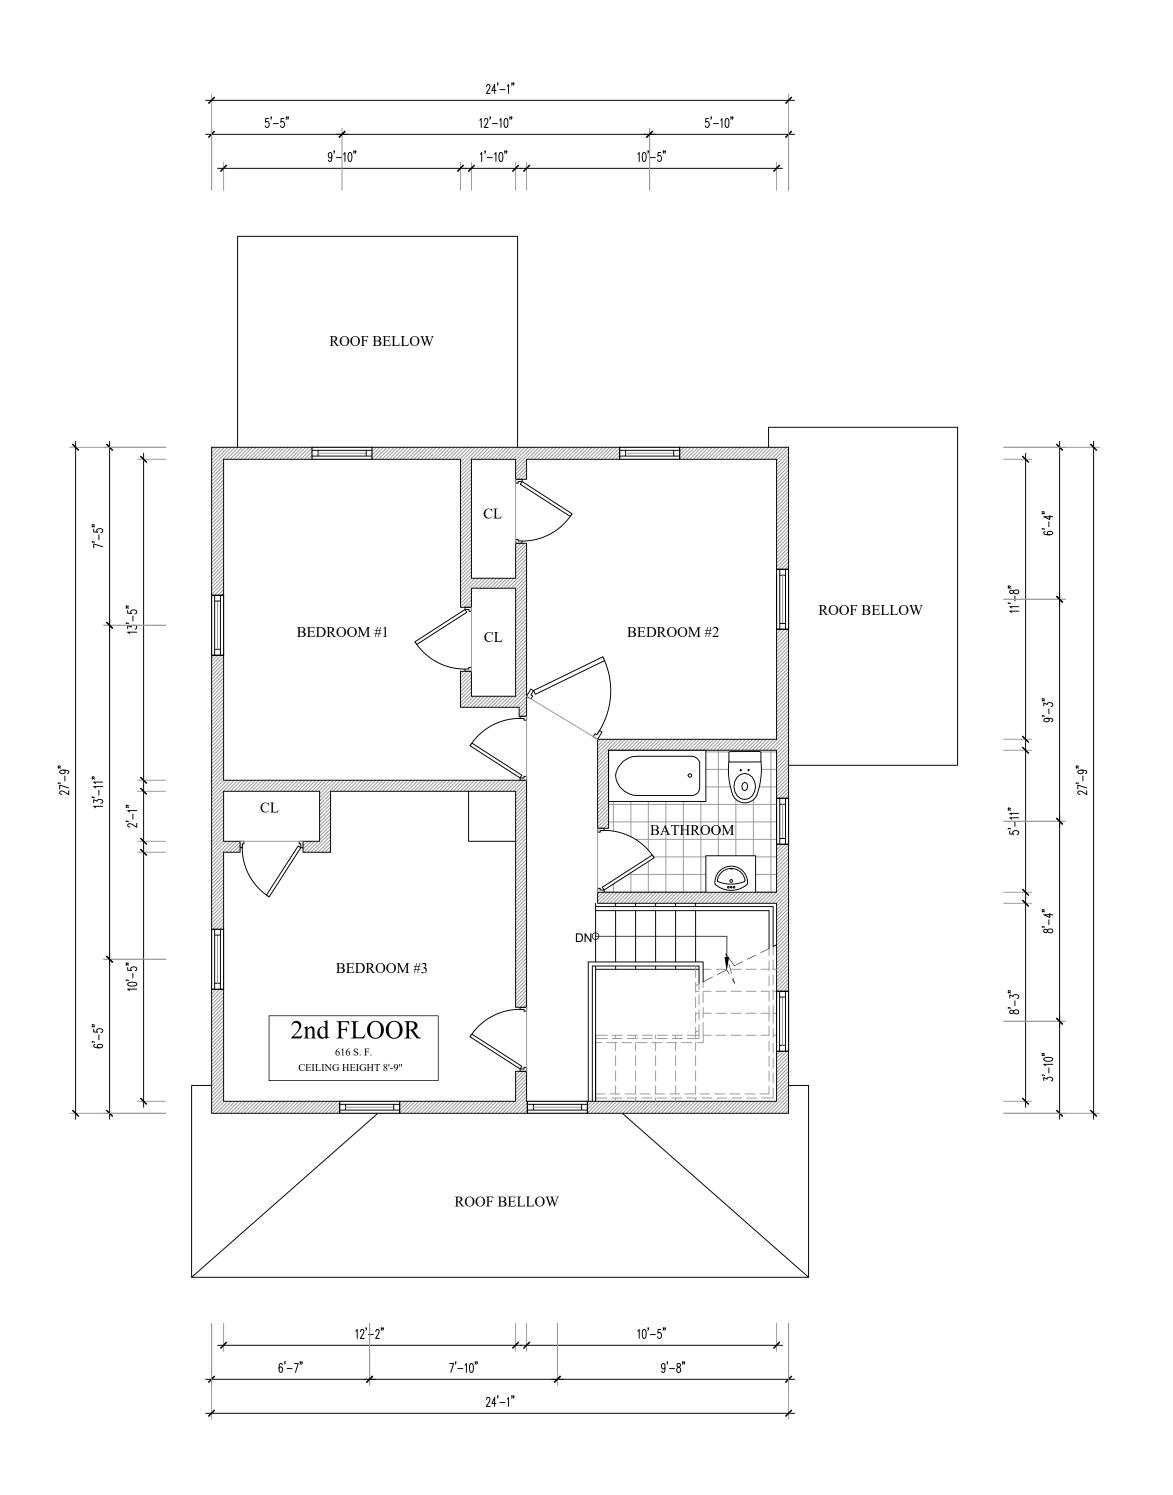

PROPOSED RENOVATION / CHANGE DF OCCUPANCY FROM SINGLE FAMIL TO TWO FAMILY DWELLING

42 DEVENS STREET MARLBOROUGH, MA 01752

APPLICANT:JUAN SOSA

LAYOUT BY: EBR

DRAWN: RH

CHECKED:

SCALE: AS INDICATED

DATE: 07/22/2021

PROJECT NO.: RDC/00211

REVISIONS: NOTES: D



8/16/21


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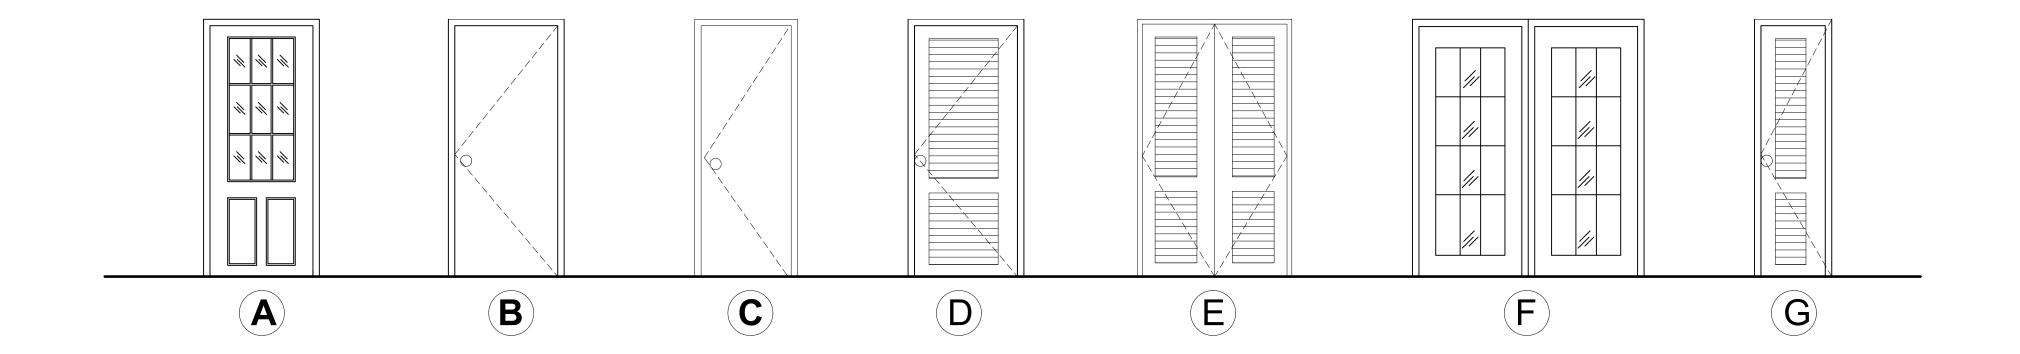
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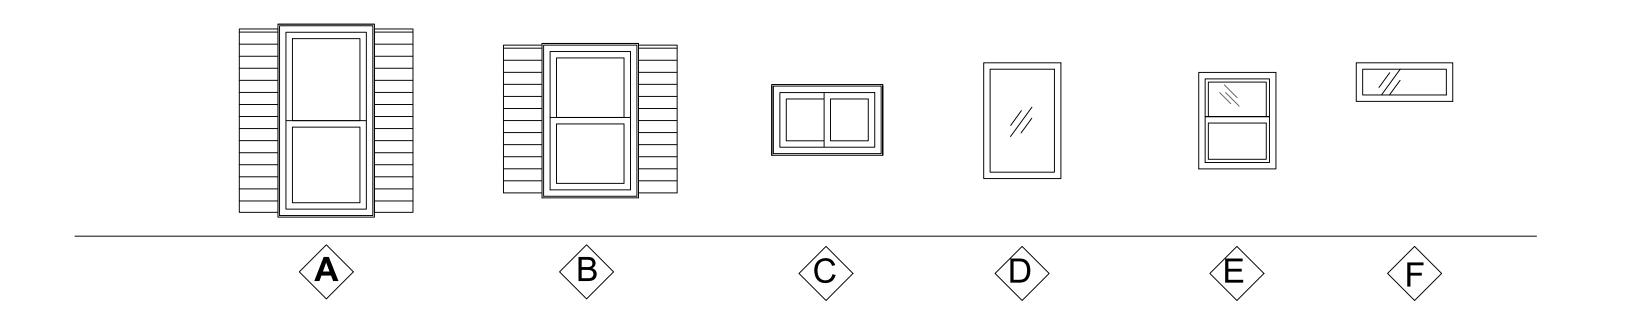
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PROPOSED DOOR SCHEDULE									
DOOR		DOOR					FRAME		
MARK	TYPE	WIDTH	HEIGHT	THICKNESS	MATERIAL	FINISH	MATERIAL	QUANTITY	COMMENTS
01	Α	3' - 0"	6' - 8"	0' - 1 3/4"	GALV METAL	PAINT	H.M.	03	EXTERIOR MAIN ENTRANCE
02	В	2' - 8"	6' - 8"	0' - 1 3/8"	WOOD	PAINT	WOOD	08	TEXTURED 6-PANEL HOLLOW CORE PRIMED COMPOSITE INTERIOR DOOR SLAB WITH BORE
03	С	3' - 0"	6' - 8"	0' - 1 3/4"	WOOD	PAINT	WOOD	06	TEXTURED 6-PANEL HOLLOW CORE PRIMED COMPOSITE INTERIOR DOOR SLAB WITH BORE
04	D	4' - 0"	6' - 8"	0' - 1 1/2"	WOOD	PAINT	WOOD	02	PLANTATION LOUVERED SOLID CORE PAINTED WHITE WOOD INTERIOR CLOSET BI-FOLD DOOR B KIMBERLY BAY (HD)
05	E	4' - 0"	6' - 8"	0' - 1 1/2"	WOOD	PAINT	WOOD	08	PLANTATION LOUVERED SOLID CORE PAINTED WHITE WOOD INTERIOR CLOSET BI-FOLD DOOR BY KIMBERLY BAY (HD)
06	F	6' - 0"	6' - 8"	0' - 1 1/2"	GALV METAL	PAINT	H.M.	02	EXTERIOR MAIN ENTRANCE
07	G	2' - 0"	6' - 8"	0' - 1 1/2"	WOOD	PAINT	WOOD	02	PLANTATION LOUVERED SOLID CORE PAINTED WHITE WOOD INTERIOR CLOSET BI-FOLD DOOR BY KIMBERLY BAY (HD)



PF	PROPOSED WINDOW SCHEDULE					
SYM	ROUGH OPENING		QUANTITY	REMARKS		
	WIDTH	HEIGHT				
(A)	30"	60"	13			
₿	30"	48"	11			
\Diamond	34"	22"	06			
\Diamond	24"	36"	03			
€	24"	30"	01			
(F)	30"	12"	06			



NOTES:

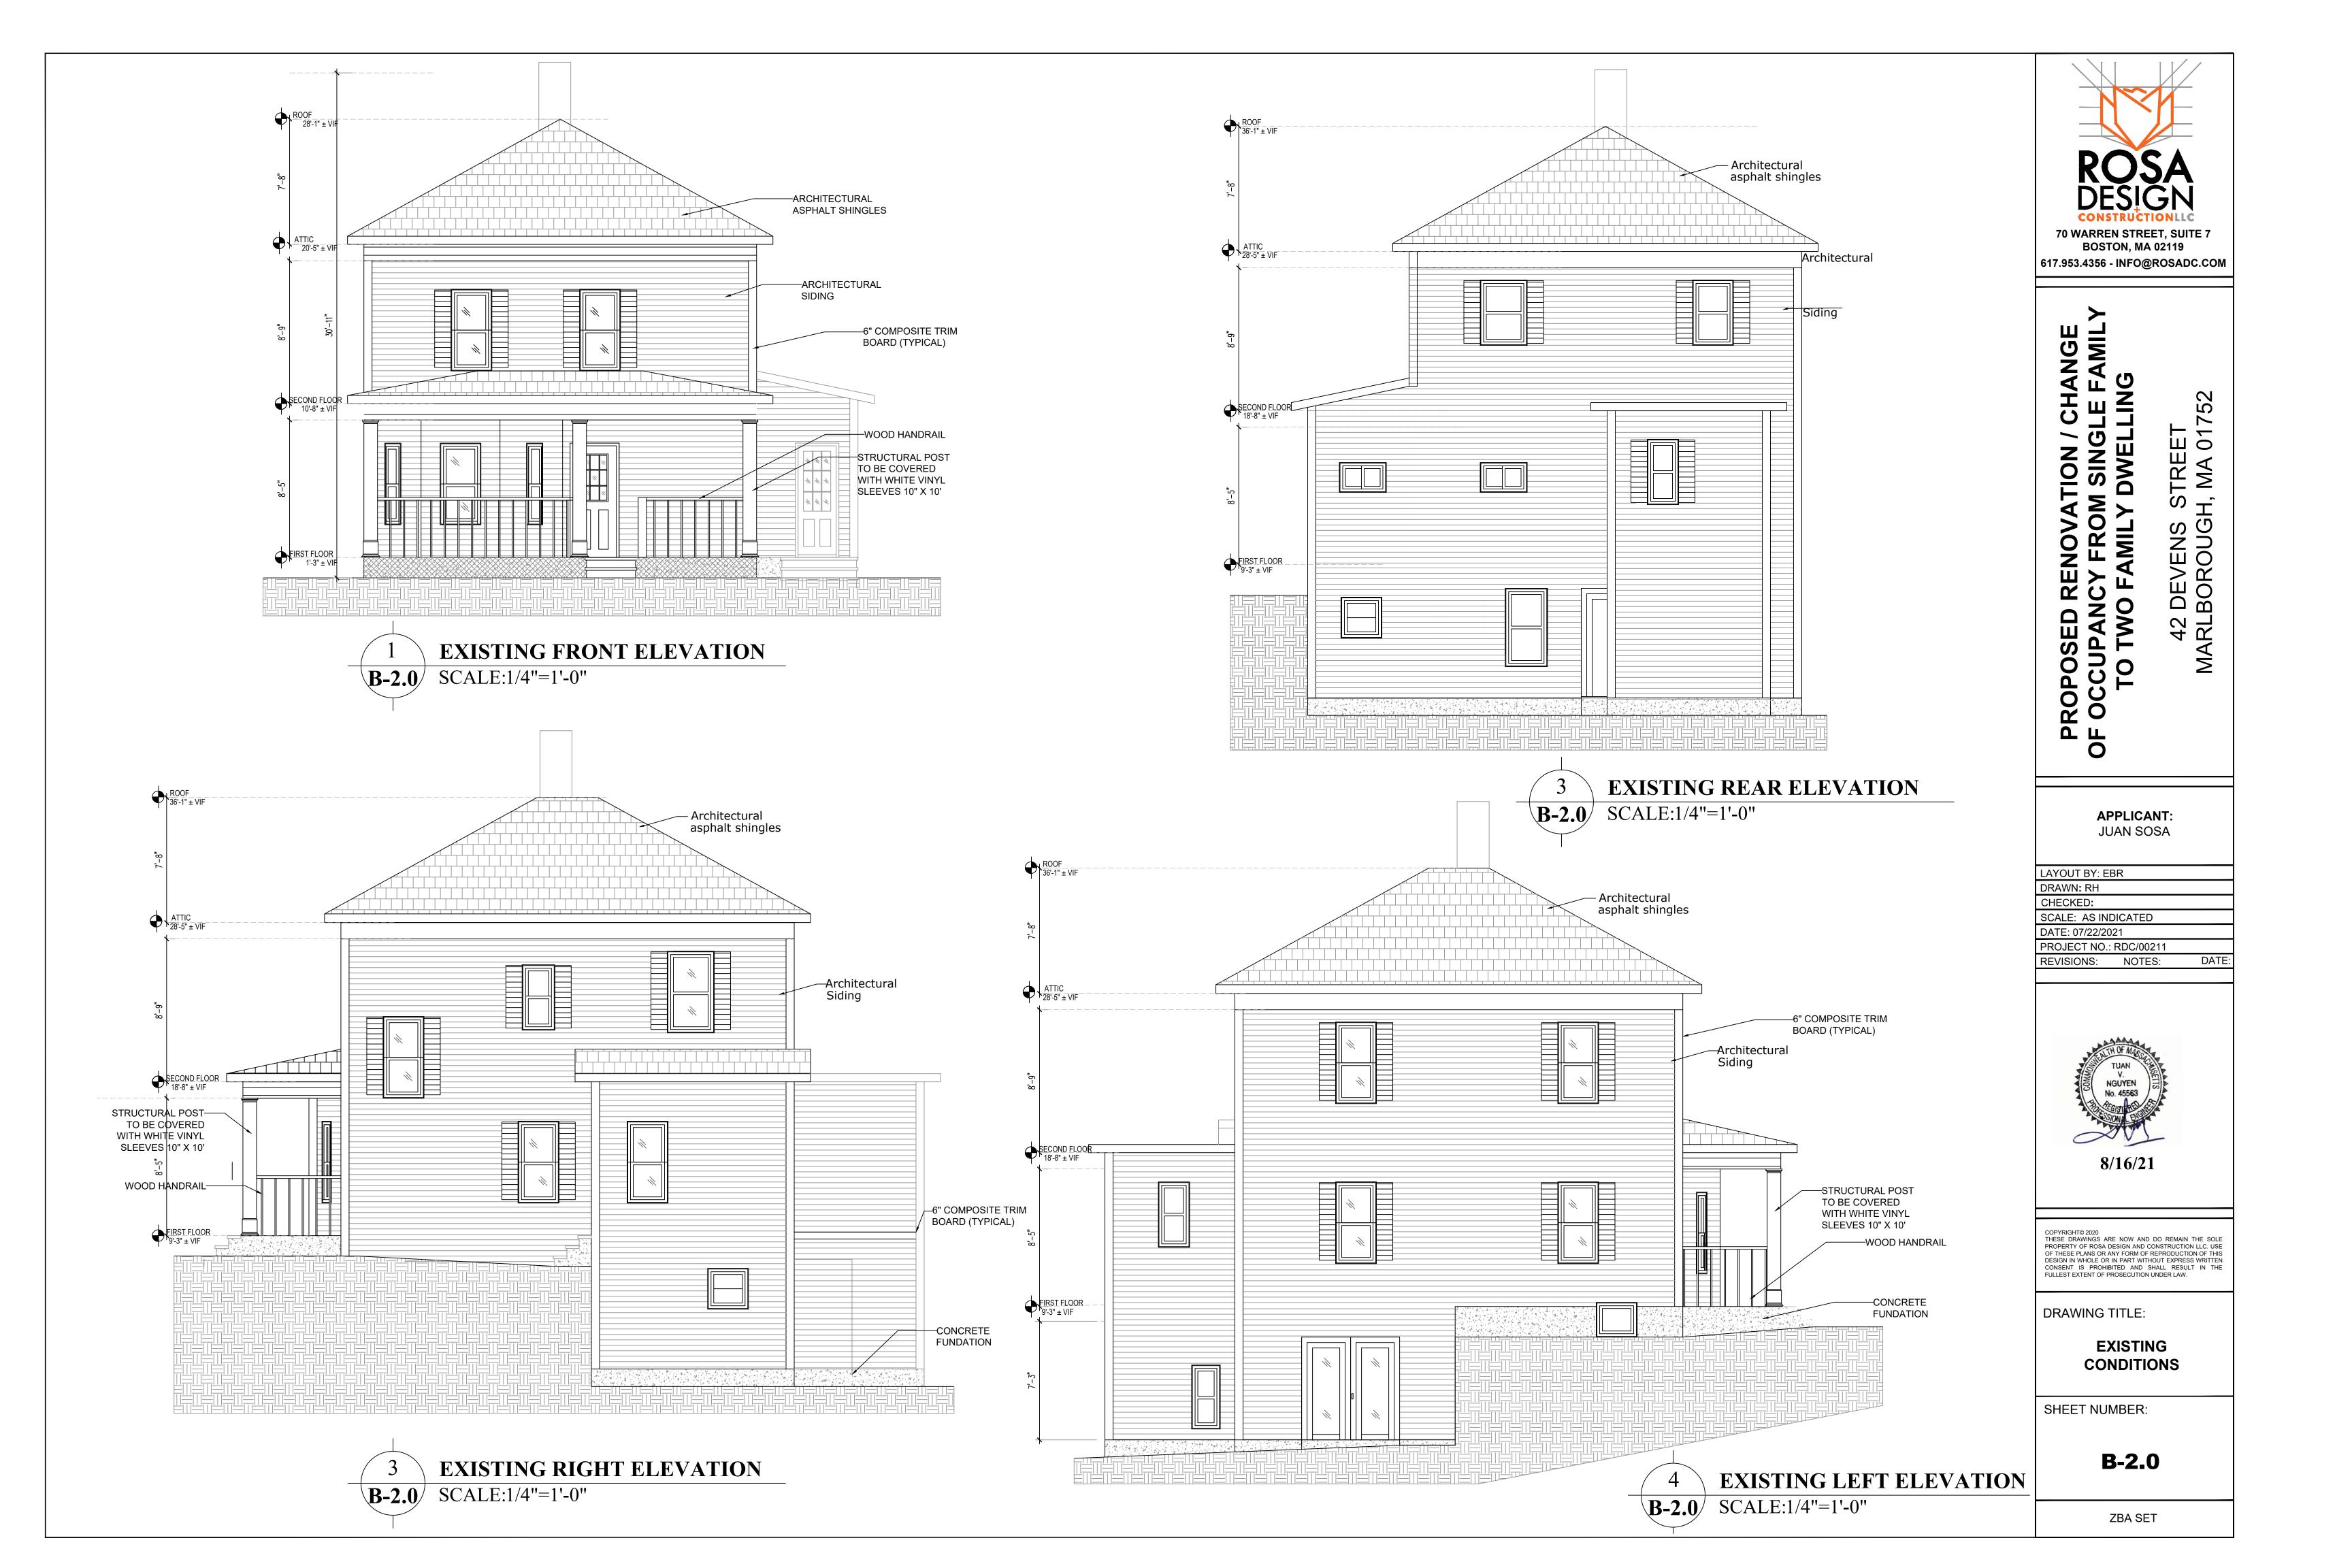- GENERAL CONTRACTOR TO CONFIRM WINDOWS AND DOORS SIZES WITH OWNER PRIOR STARTING WORK.





PROPOSED RENOVATION / CHANGE
OF OCCUPANCY FROM SINGLE FAMILY
TO TWO FAMILY DWELLING

42 DEVENS STREET MARLBOROUGH, MA 01752

APPLICANT: JUAN SOSA

LAYOUT BY: EBR

DRAWN: RH

CHECKED:

SCALE: AS INDICATED

DATE: 07/22/2021

PROJECT NO.: RDC/00211

REVISIONS: NOTES: D.



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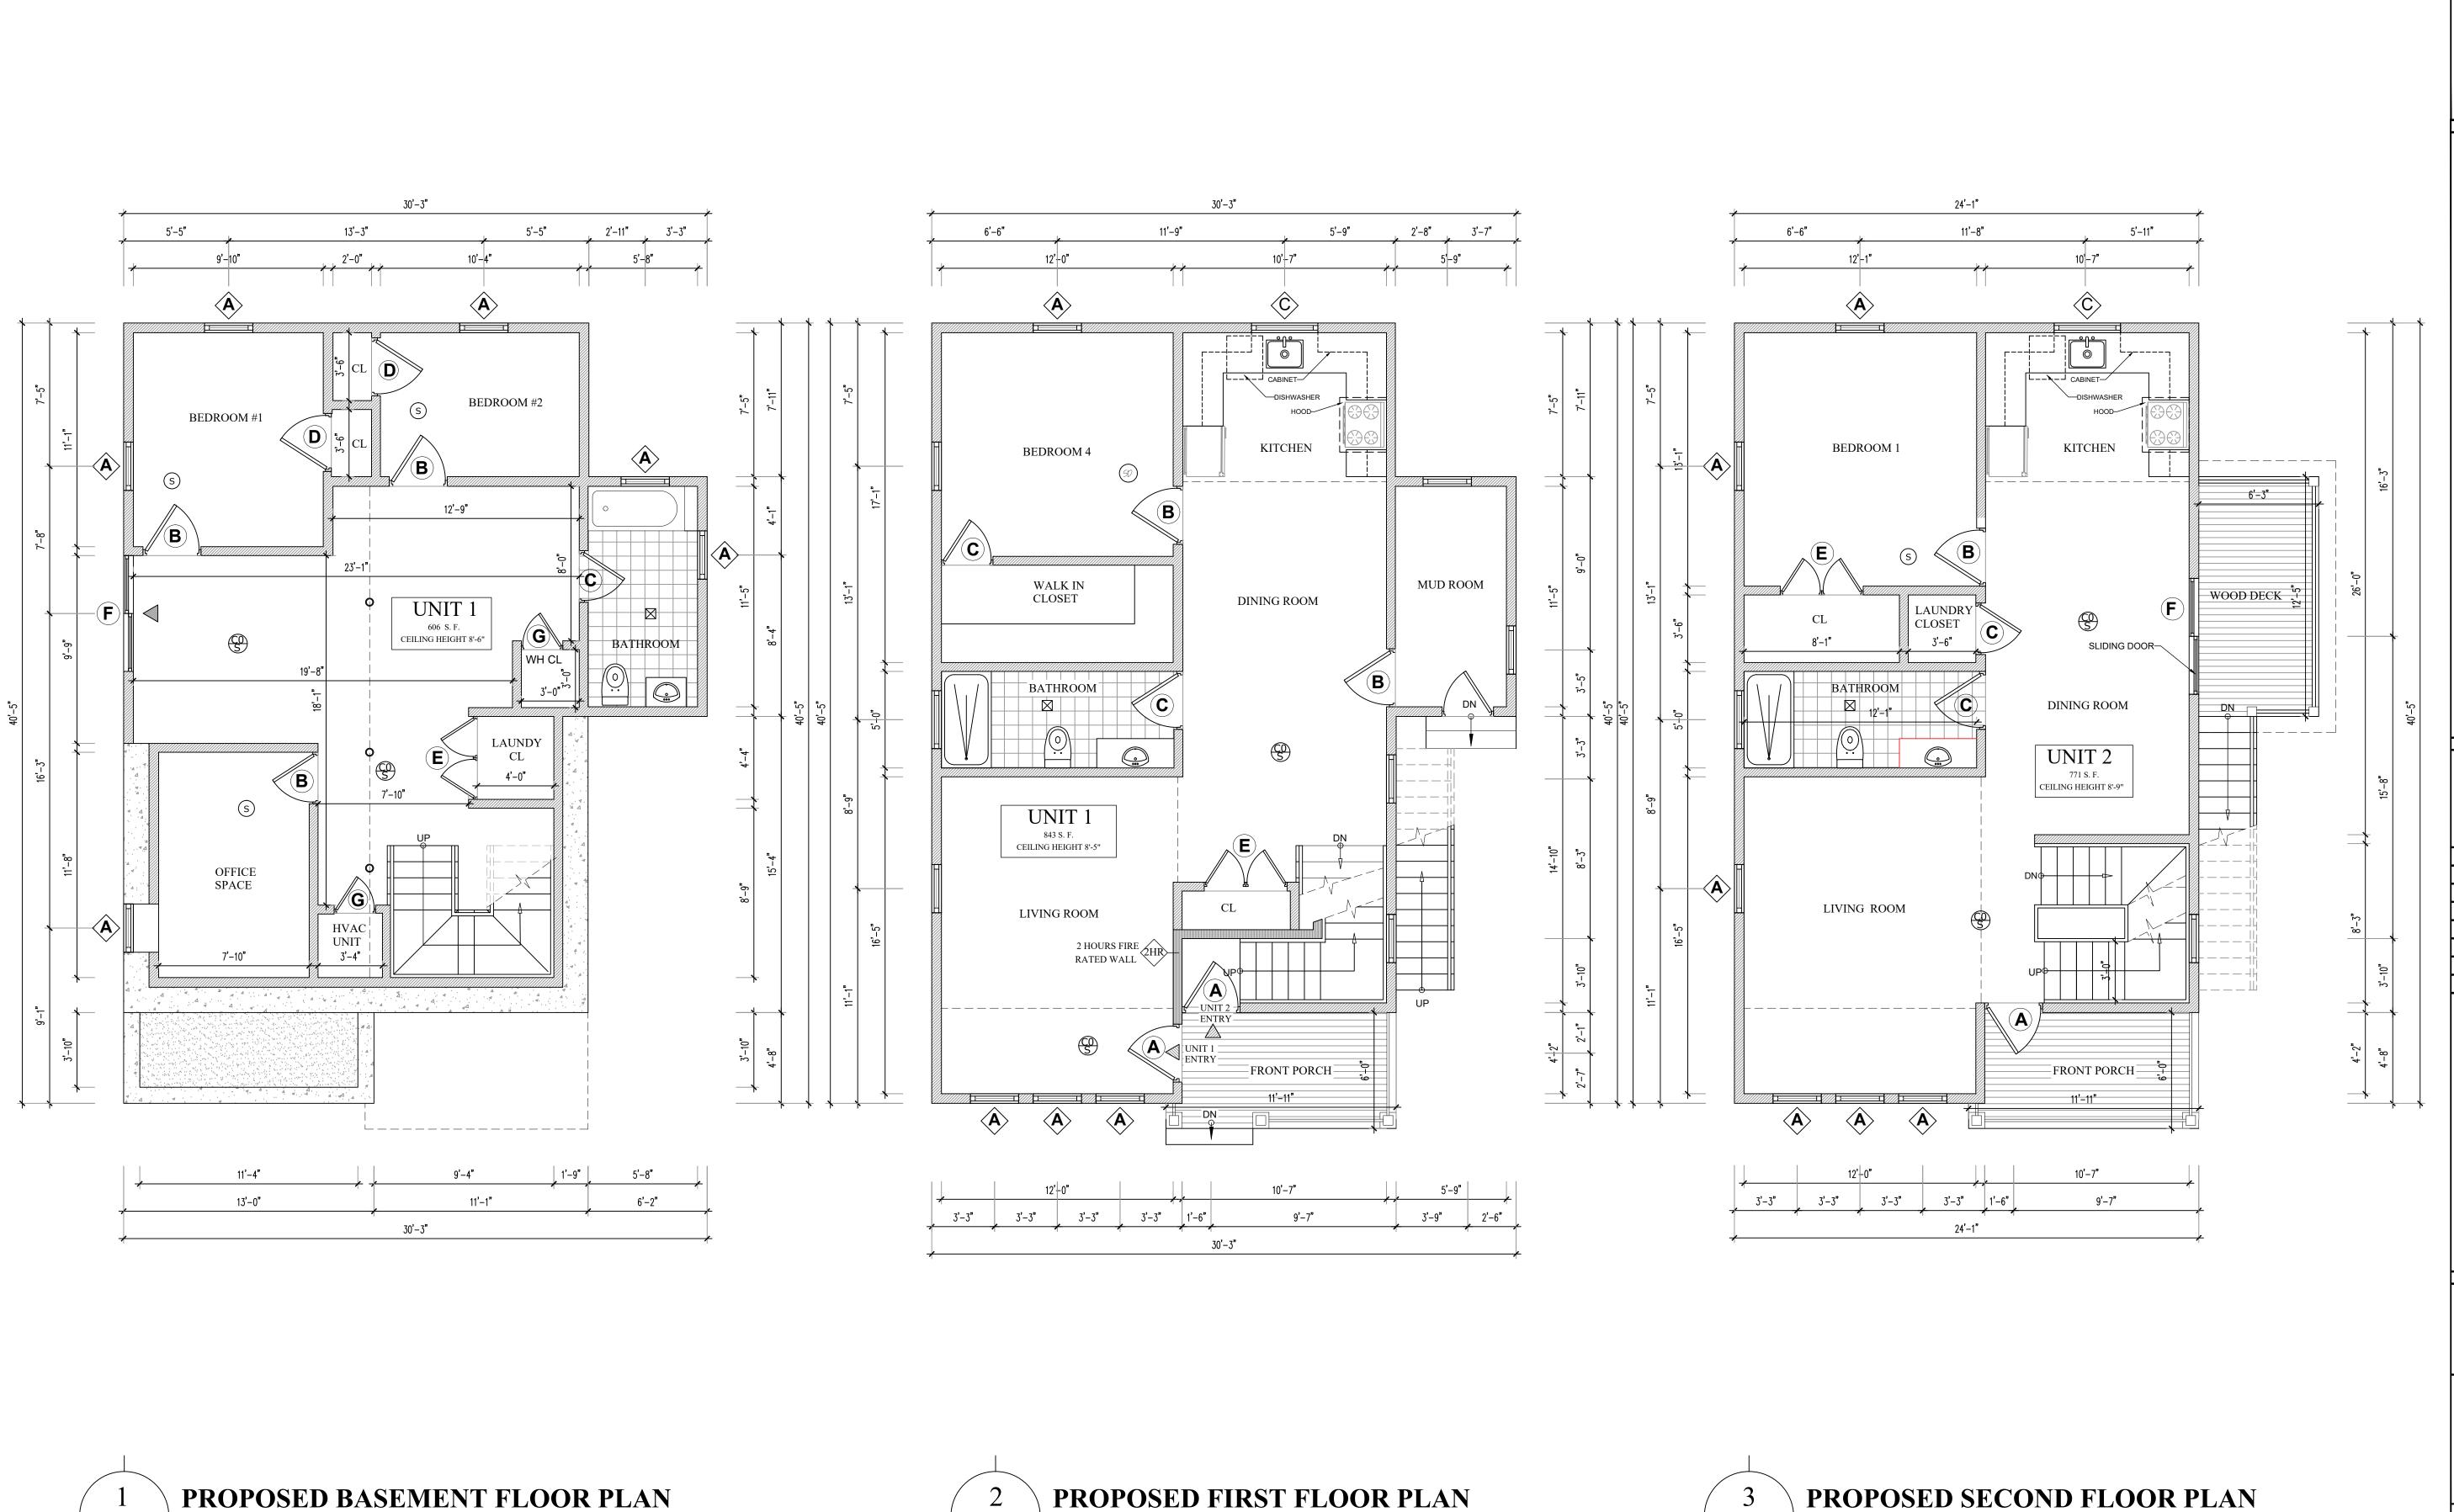
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PROPOSED

SHEET NUMBER:

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A-1.0 SCALE:NTS

 $\mathbf{A-1.0}$ SCALE:NTS



PROPOSED RENOVATION / CHANGE OF OCCUPANCY FROM SINGLE FAMILY TO TWO FAMILY DWELLING

42 DEVENS STREET MARLBOROUGH, MA 01752

APPLICANT: JUAN SOSA

LAYOUT BY: EBR

DRAWN: RH

CHECKED:

SCALE: AS INDICATED

DATE: 07/22/2021
PROJECT NO.: RDC/00211
REVISIONS: NOTES: DA



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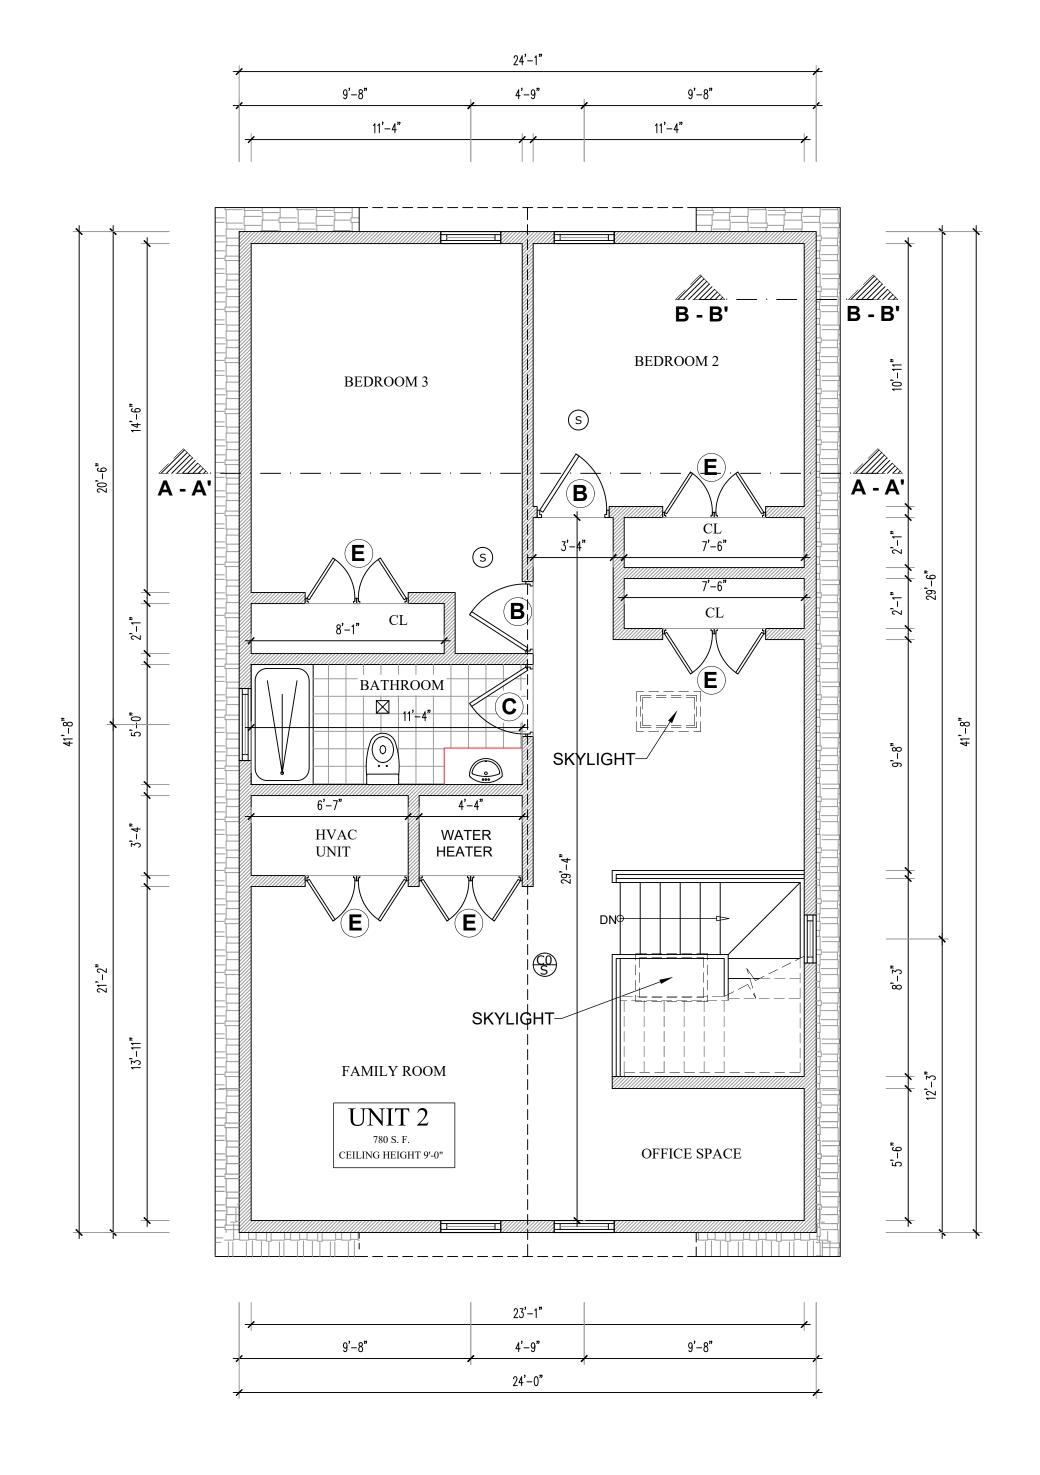
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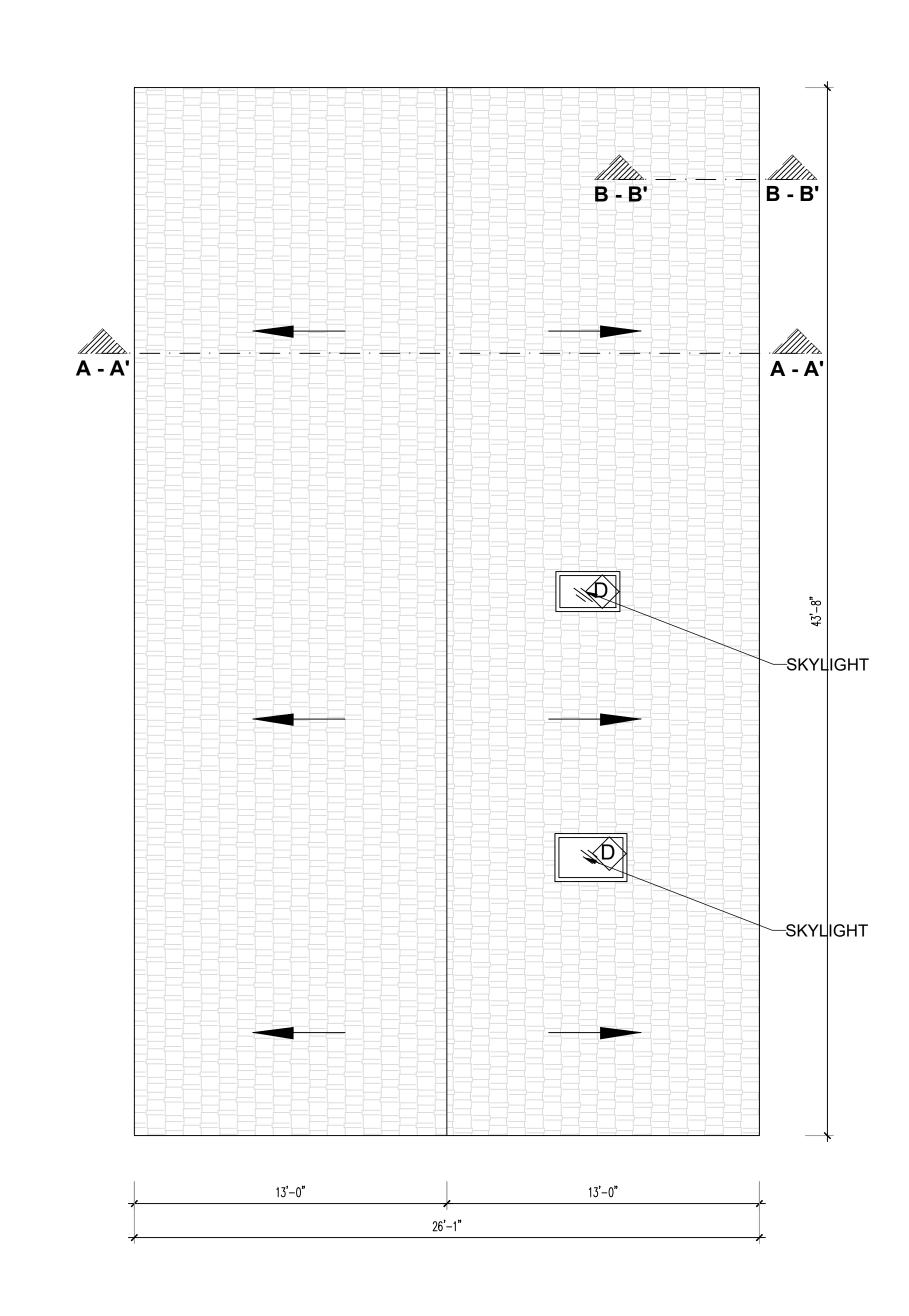
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A-1.0 SCALE:NTS

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PROPOSED RENOVATION / CHANG OF OCCUPANCY FROM SINGLE FAMI TO TWO FAMILY DWELLING

42 DEVENS STREET MARLBOROUGH, MA 01752

APPLICANT:JUAN SOSA

LAYOUT BY: EBR

DRAWN: RH

CHECKED:

SCALE: AS INDICATED

DATE: 07/22/2021

PROJECT NO.: RDC/00211

REVISIONS: NOTES:



8/16/21


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DRAWING TITLE:

PROPOSED

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- 9. TAKE FIELD MEASUREMENTS BEFORE FABRICATION WORK TO ENSURE THAT COMPONENTS FIT TOGETHER PROPERLY

WOOD NOTES:

- 1. ALL LUMBER SHALL HAVE A MOISTURE CONTENT OF NOT MORE THAN 19.
- 2. ALL FRAMING LUMBER SHALL BE 2 HEM-FIR, OR BETTER,
- HAVING A MINIMUM: FB=1,200 PSI, FV=70 PSI, E=1,300,000 PSI.
- 3. ALL L.V.L. LUMBER DENOTED ON PLANS SHALL HAVE A
- FB=2,650 PSI, FV=285 PSI, E=1,900,000 PSI FOR STUDS
 - FB-3100 PSI, FV=285 PSI, E=2,000,000 PSI FOR BEAMS
- 4. ALL JOIST SPANS SHALL HAVE ONE ROW OF 1" X 3: CROSS BRIDGING AT MID SPAN
 - AND NOT MORE THAN 8'-O" O.C.
- 5. ALL STUD BEARING WALLS SHALL HAVE ONE ROW OF 2X
- HORIZONTAL BLOCKING AT 12 STUD HEIGHT, AND NOT MORE THAN 6'-O" O.C. MAXIMUM.
- 6. PROVIDE AND INSTALL ALL NECESSARY TIMBER CONNECTORS
- 7. PROVIDE DOUBLE JOIST BELOW PARTITIONS PARALLEL TO JOIST
- 8. PROVIDE SOLID BRIDGING BELOW PARTITIONS PERPENDICULAR TO JOIST FRAMING.
- 9. PROVIDE SOLID BRIDGING BETWEEN JOIST FRAMING MEMBERS WHEN BEARING ON
 - STUD PARTITIONS OR BEAMS.

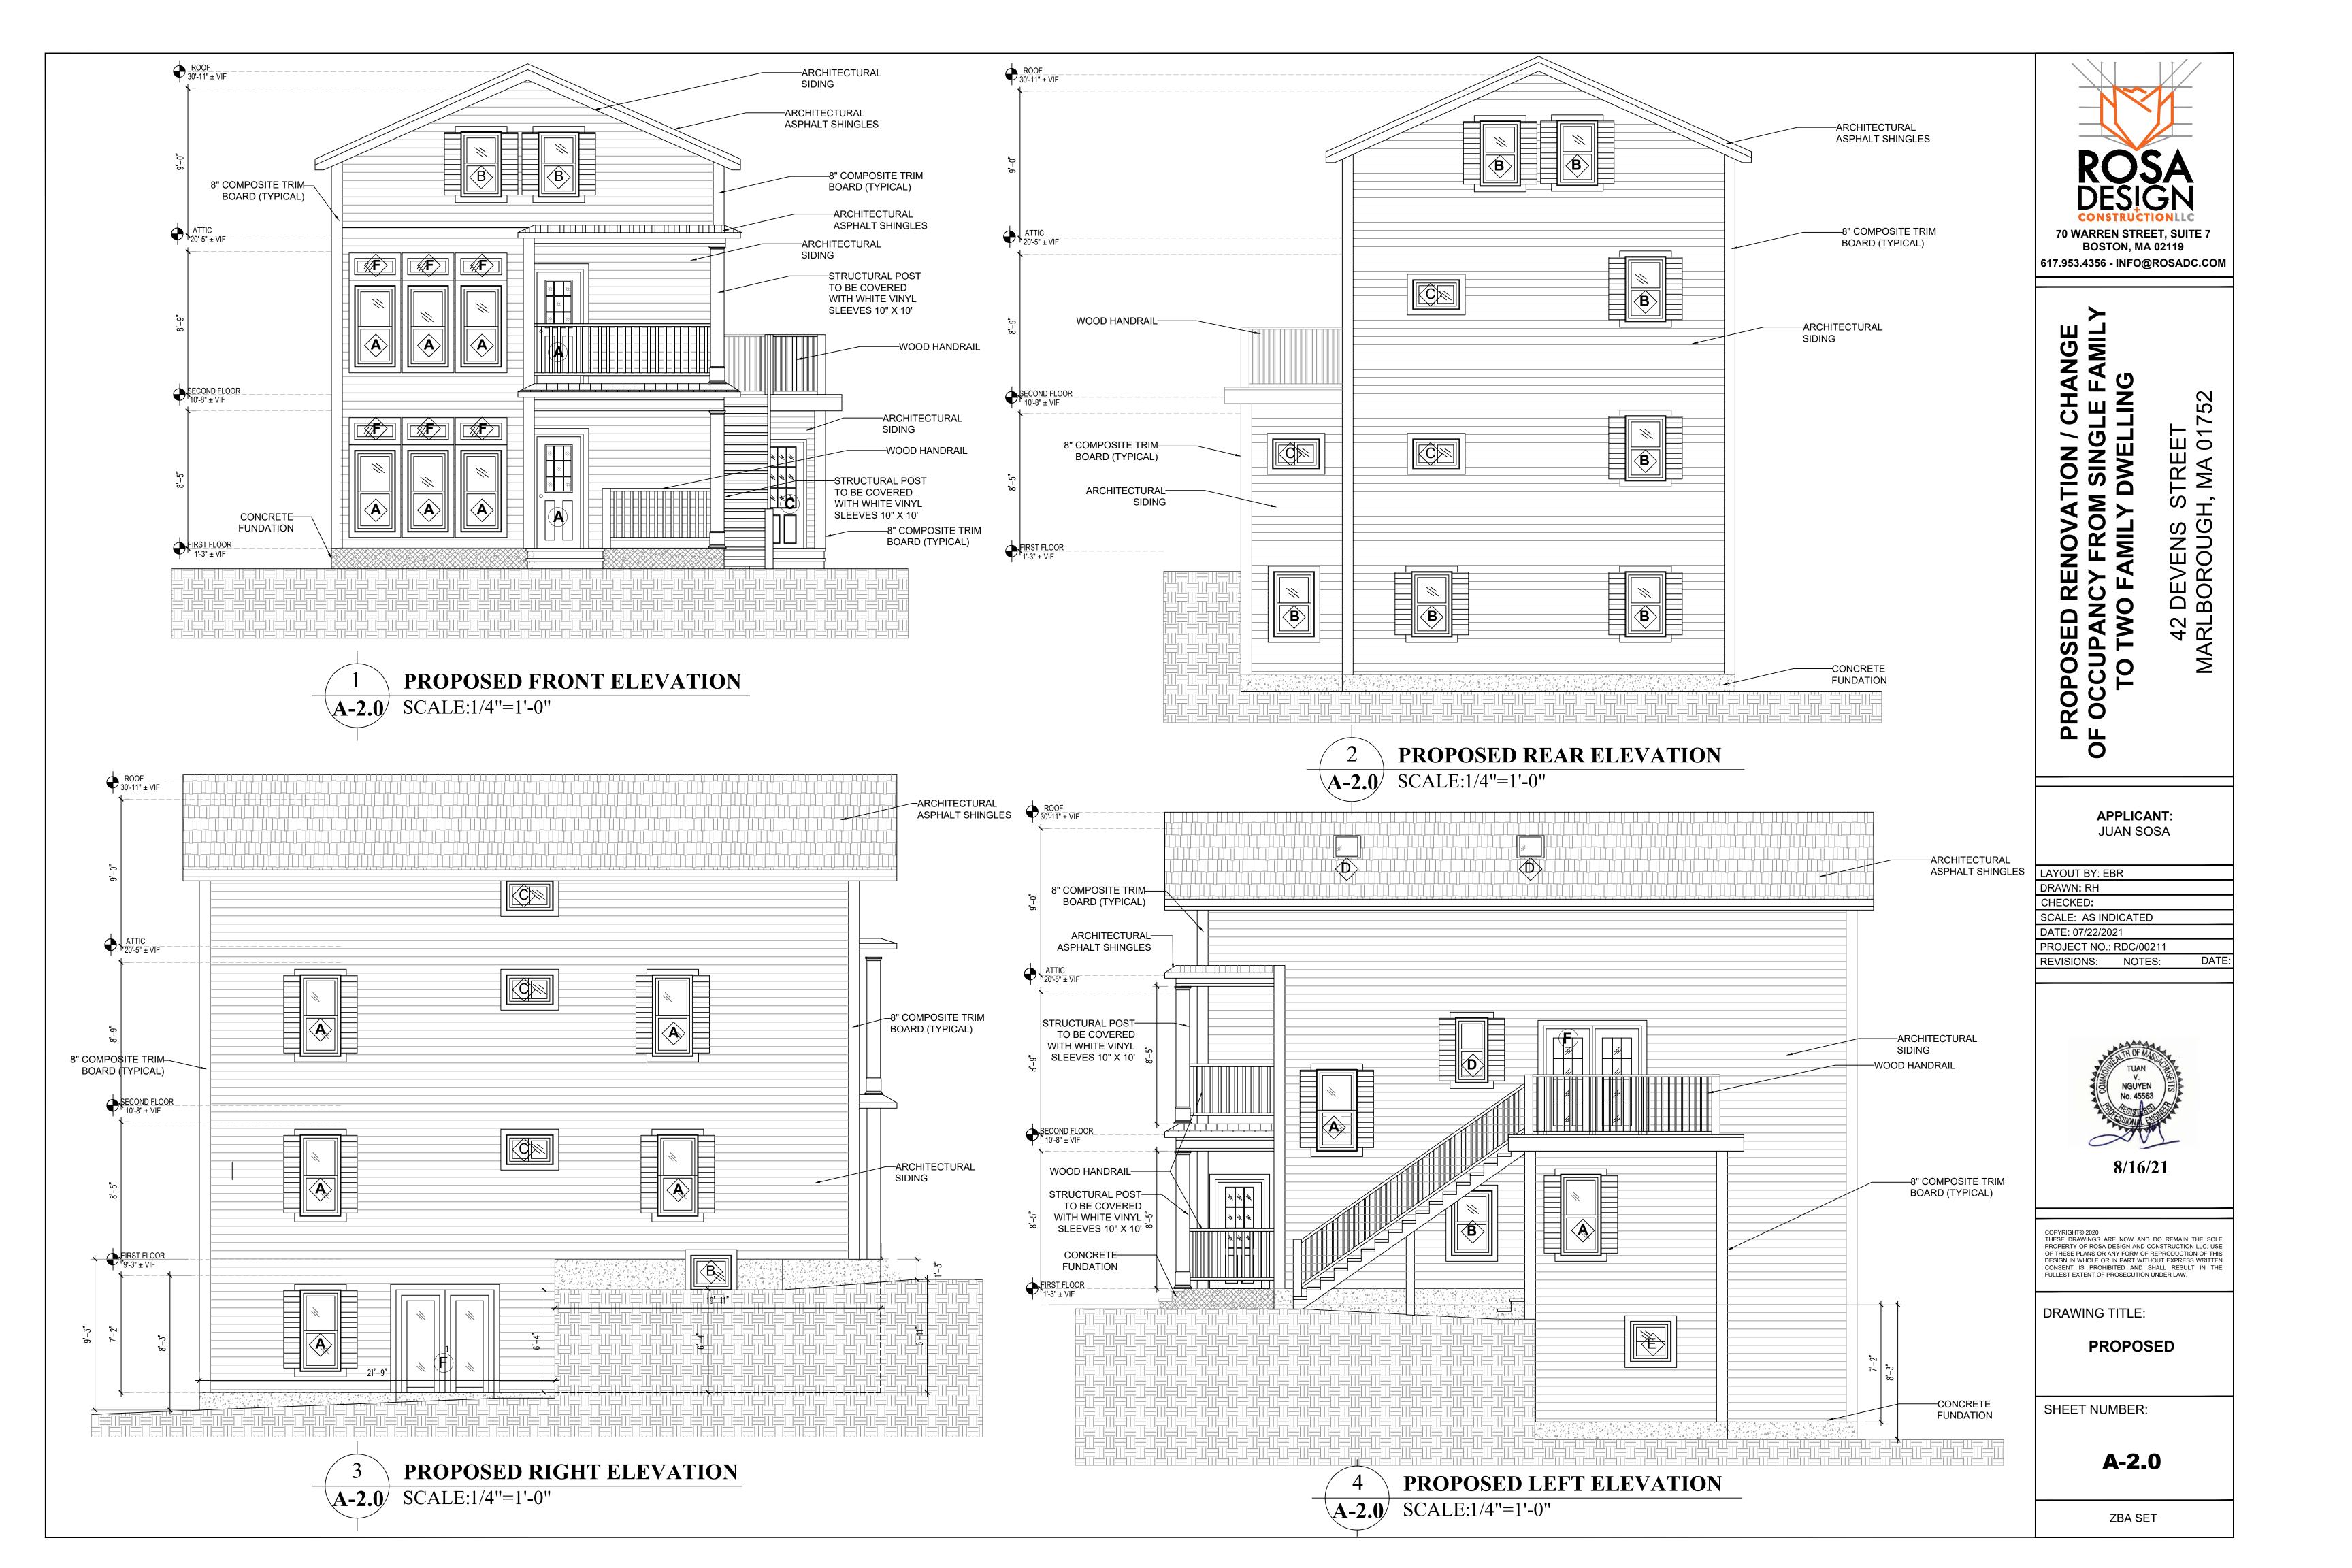FRAMING.

- 10. PROVIDE A CONTINUOUS BAND JOIST AT EXTERIOR STUD
- 11. PROVIDE DIAGONAL METAL STRAP BRACING AT ALL CORNERS AND WALL INTERSECTIONS, AT THE INSIDE FACE OF STUDS, FROM
- TOP PLATE TO FLOOR PLATE AT A 45 DEGREE ANGLE WITH A SIMPSON TYPE "RCWB" STRAP, OR EQUAL.
- 12. ALL BUILT-UP BEAMS SHALL BE BOLTED WITH 12" Ø THRU BOLTS, MEETING A307 STANDARDS, OR, AS NOTED ON DRAWINGS.

WOOD LINTEL SCHEDULE:

Lintels over openings in bearing walls shall be as follows; or as noted on drawings.

Span of opening:	Size: 2x6 studs	Size: 2x4 st		
less than 4'-0"	3 - 2x4	2 - 2x4		
up to 6'-0"	3 - 2x6	2 - 2x6		
up to 8'-0"	3 - 2x8	2 - 2x8		
up to 10'-0"	3 - 2x10	2 - 2x10		

REINFORCING NOTES:

- 1. ALL REINFORCEMENT, EXCEPT FOR TIES AND STIRRUPS, SHALL CONFORM TO ASTM 615-60.
- 2. ALL REINFORCEMENT FOR TIES AND STIRRUPS SHALL CONFORM TO ASTM 615-40.
- 3. ALL WELDED WIRE FABRIC SHALL CONFORM TO ASTM A185-70 SPECIFICATIONS.
- 4. ALL REINFORCEMENT SHALL BE INSPECTED AND APPROVED BY THE ARCHITECT OR HIS ENGINEER PRIOR TO THE PLACEMENT OF ANY CONCRETE
- 5. CLEARANCES OF MAIN REINFORCING FROM ADJACENT CONCRETE SURFACES SHALL BE AS FOLLOWS:
- A. FOOTINGS 3 INCHES
- B. SIDES OF FOUNDATIONS WALLS. EXPOSED FACES OF FOUNDATIONS. SIDES OF COLUMNSPIERS, SLABS
- ON GRADE FROM TOP SURFACE 2 INCHES
- C. INTERIOR FACES OF FOUNDATIONS,
- TOP REINFORCING IN SLABS EXPOSED TO THE WEATHER
- D. TOP STEEL OF INTERIOR SLABS 1 INCHES MAXIMUM DEVIATION FROM THESE REQUIREMENTS SHALL BE 14" OF SECTIONS 10" OR LESS, 12" FOR SECTIONS GREATER THAN 10".

EPOXY ANCHORS:

- EXPANSION BOLTS USED IN CONCRETE SHALL BE SIMPSON STRONG BOLT 2 OR EQUAL. BOLTS
- NEED TO BE INSTALLED IN ACCORDANCE WITH ICC-REPORT ESR-3037.
- EPOXY ANCHORS AND DOWELS INSTALLED INTO CONCRETE SHALL BE A THREADED ROD OR REINFORCING BAR DOWEL WITH THE HILTI "RE-500SD" ADHESIVE SYSTEM AND BE INSTALLED ACCORDING TO ICC-REPORT ESR-2322.
- CONTRACTOR MAY SUBSTITUTE EXPANSION BOLTS OR EPOXY ADHESIVES OF EQUAL VALUE IN THE SPECIFIED MATERIAL WITH A CURRENT ICC-REPORT FOR REVIEW

FOUNDATION NOTES:

- . ALL FOUNDATION FOOTINGS SHALL BE CARRIED DOWN TO A MINIMUM OF 4'-0" BELOW FINISH GRADE, OR DEEPER, IF NECESSARY, TO OBTAIN A SAFE SOIL BEARING PRESSURE OF 2 TONS PER SQUARE FOOT, FOUNDATION DESIGN IS BASED ON ASSUMED SOIL BEARING CAPACITY OF 2 TONS PER SQUARE FOOT.
- 2. ALL FOOTINGS SHALL BE PLACED ON UNDISTURBED SOIL; OR, ON ENGINEERED BANK RUN GRAVEL FILL MATERIAL WITH A MINIMUM DRY
- 3. ALL FOOTING SHALL BE POURED IN THE DRY ONLY. WATER SHALL NOT
- BE ALLOWED TO FLOW THROUGH THE DEPOSITED CONCRETE. 4. NO FOOTING SHALL BE POURED ON FROZEN GROUND. FOUNDATIONS NEED TO BE PROTECTED
- FROM FREEZING FOR A MIN OF 5 DAYS AFTER THEY WERE POURED. 5. THE MINIMUM REINFORCING FOR ALL FOUNDATION WALLS
- SHALL BE 2-6 BARS AT THE TOP AND BOTTOM, CONTINUOUS; OR, AS SHOWN ON DRAWINGS.
- 6. LAP ALL BARS 40 DIAMETERS AND PROVIDE CORNER BARS. 7. ALL REINFORCEMENT: ASTM A615-60, WWF A185.

CONCRETE NOTES:

- 1. ALL CONCRETE SHALL ATTAIN A MINIMUM COMPRESSIVE STRENGTH
- 3000 PSI
- 3500 PSI
- 2. MAXIMUM SLUMP SHALL NOT EXCEED 3"; AND MAXIMUM; COARSE
- AGGREGATE SIZE SHALL NOT EXCEED 34" IN DIAMETER. 3. ALL CONCRETE SLABS ON GRADE SHALL BE POURED IN 900 SQUARE FOOT PANELS, MAXIMUM; OR, PROVIDE CONTROL JOINTS BY SAW CUTTING THE SLAB WHILE THE CONCRETE IS STILL GREEN.

BUILDING ELEMENT	NAIL SIZE AND TYPE	NUMBER AND LOCATION
STUD TO SOLE PLATE	8P COMMON 16P COMMON	4 TOE-NAIL OR 2 DIRECT-NAIL
STUD TO CAP PLATE	16D COMMON	2 TOE-NAIL OR 2 DIRECT-NAIL
DOUBLE STUDS	IOP COMMON	12" O.C. DIRECT
CORNER STUDS	16D COMMON	24" O.C. DIRECT
SOLE PLATE TO JOIST OR BLOCKING	16D COMMON	16" O.C.
DOUBLE CAP PLATE	IOD COMMON	16" O.C. DIRECT
CAP PLATE LAPS	IOP COMMON	2 DIRECT-NAIL
RIBBON STRIP, 6" OR LESS	IOD COMMON	2 EACH DIRECT BEARING
RIBBON STRIP, 6" OR MORE	IOP COMMON	3 EACH DIRECT BEARING
ROOF RAFTER TO PLATE	8b COMMON	3 TOE-NAIL
JACK RAFTER TO RIDGE	16D COMMON	2 TOE-NAIL OR DIRECT-NAIL
JACK RAFTER 10 HIP	IOP COMMON	3 TOE-NAIL OR 2 DIRECT-NAIL
FLOOR JOISTS TO STUDS (NO CEILING JOISTS)	IOP COMMON IOP COMMON	5 DIRECT OR 3 DIRECT
FLOOR JOISTS TO STUDS (WITH CEILING, 1015TS)	IOP COMMON	2 DIRECT
FLOOR JOISTS TO SILL OR GIRPER	3D COMMON	3 TOE-NAIL
LEDGER STRIP	I6D COMMON	3 EACH DIRECT
CEILING JOISTS TO PLATE	160 COMMON	3 TOE-NAIL
CEILING JOISTS (LAPS OVER PARTITION)	IOP COMMON	3 DIRECT-NAIL
CEILING JOISTS (PARALLEL TO RAFTER)	IOP COMMON	3 DIRECT
COLLAR BEAM	IOP COMMON	3 DIRECT
BRIDGING TO JOISTS	8b COMMON	2 EACH DIRECT END
DIAGONAL BRACE (TO STUD AND PLATE)	80 COMMON	2 EACH DIRECT BEARING
TAIL BEAMS TO HEADERS (WHEN NAILING PERMITTED)	200 COMMON	I EACH END 4 SQ, FT, FLOOR AREA
HEADER BEAMS TO TRIMMERS	200 COMMON	I EACH END 8 50, FT, FLOOR AREA
I'' ROOF DECKING	8p common	2 EACH DIRECT RAFTER
(OVER 6" IN WIDTH)	80 COMMON	3 EACH DIRECT RAFTER
I'' SUBFLOORING (6" OR LESS)	8b common	2 EACH DIRECT JOIST
I'' SUBFLOORING (8" OR MORE)	80 COMMON	3 EACH DIRECT JOIST
2" SUBFLOORING	I6D COMMON	2 EACH DIRECT JOIST
I'' WALL SHEATHING (8" OR LESS IN WIDTH)	8D COMMON	2 EACH DIRECT STUD
I'' WALL SHEATHING (OVER 8" IN WIDTH)	80 COMMON	3 EACH DIRECT STUD
PLYWOOD ROOF & WALL SHEATHING (1/2" OR LESS) (5/8" OR GREATER) (5/16",3/8", OR 1/2")	6P COMMON 8P COMMON 16 GALLOE GALVANIZED WIRE STAPLES, 3/8" MINIMUM CROWN; LENGTH OF I" PLUS PLYWOOD THICKNESS	6" O.C. DIRECT EDGES & 12" O.C. INTERMEDIATE 6" O.C. DIRECT EDGES & 12" O.C. INTERMEDIATE 4" O.C. EDGES & 8" O.C. INTERMEDIATE
(OVER 6" IN WIDTH) PLYWOOD SUBFLOORING	SAME AS IMMEDIATELY ABOVE	2 1/2" O.C. EDGES & 5" O.C. INTERMEDIATE
(12") (\$/8",\$/4") (", /8")	6D COMMON OR 6D ANNILAR OR SPIRAL THREAD 8D COMMON OR 8D ANNILAR OR SPIRAL THREAD 10D COMMON OR 8D RING SHANK OR 8D ANNILAR OR SPIRAL THREAD	6" O.C. DIRECT EDGES & 10" O.C. INTERMEDIATE 6" O.C. DIRECT EDGES & 10" O.C. INTERMEDIATE 6" O.C. DIRECT EDGES & 6" O.C. INTERMEDIATE
(12") (38")	16D GALVANIZED WIRE STAPLES 3/8" MINIMUM CROWN; 13/8" LENGTH	4" O.C. EDGES & 7" O.C. INTERMEDIATE 2 1 / 2" O.C. EDGES & 4" O.C. INTERMEDIATE
BUILT-UP GIRDERS AND BEAMS	20P COMMON	32" O.C. DIRECT
CONTINUOUS HEADER TO STUD	8b common	4 TOE-NAIL
CONTINUOUS HEADER, TWO PIECES	16D COMMON	16" O.C. DIRECT
1/2" FIBER BOARD SHEATHING	11/2" GALVANIZED ROOFING NAIL OR 16 GALGE STAPLE, 11/2" LONG WITH MIN. CROWN OF 7/16"	3" O.C. EXTERIOR EDGE 6" O.C. INTERMEDIATE
25/32" FIBER BOARD SHEATHING	13/4" GALVANIZED ROOFING NAIL OR 8D COMMON NAIL OR 16 GAUGE STAPLE, 11/2" LONG WITH MIN. CROWN OF 7/16"	3" O.C. EXTERIOR EDGE 6" O.C. INTERMEDIATE
GYPSUM SHEATHING	12 GALIGE I 3/4" LARGE HEAD CORROSION- RESISTANT	4" O.C. EDGE 8" O.C. INTERMEDIATE
PARTICLE BOARD UNDERLAYMENT (1/4"-3/4")	6D ANNULAR THREADED	6" O.C. PIRECT EDGES 10" O.C. INTERMEDIATE
PARTICLE BOARD ROOF AND WALL SHEATHING 1/ 2" OR LESS	60 COMMON	6" O.C. PIRECT EDGES 12" O.C. INTERMEDIATE
5/8" OR GREATER	8b common	6" O.C. DIRECT EDGES 12" O.C. INTERMEDIATE
PARTICLE BOARD SUBFLOORING (5/8" OR GREATER)	8b common	6" O.C. DIRECT EDGES 12" O.C. INTERMEDIATE
SHINGLES, WOOD*	NO. 14 B&S GAGE CORROSION RESISTIVE	2 EACH BEARING
WEATHER BOARDING	80 CORROSION	2 EACH BEARING
	3/4" INTO NAILING STRIPS, SHEATHING OR SUPPORTING CON	

RECOMENDED FASTENING SCHEDULE

ENERGY AUDIT

COMPLIANCE DETERMINED BY MASSACHUSETTS STRETCH ENERGY CODE (IRC 2015 WITH MASSACHUSETTS AMENDMENTS SECTION N1 101)

PRESCRIPTIVE OPTION FOR RESIDENTIAL ADDITION (401.3)

- 1. RENOVATION TO COMPLY WITH ENERGY STAR QUALIFIED HOMES THERMAL BYPASS INSPECTION CHECKLIST. INSULATION VALUES AS FOLLOWS:
- ROOF R-VALUE: R49
- WALL R-VALUE: R20
- FLOOR R-VALUE: R30
- CRAWL SPACE R-VALUE: R10
- 2. RENOVATION TO COMPLY WITH ENERGY STAR PROGRAM REQUIREMENTS FOR RESIDENTIAL WINDOWS: DOORS; AND SKYLIGHTS - VERSION 5.0. ALL NEW WINDOW GLAZING WITH .30 U-FACTOR.
- 3. HEATING / COOLING DUCTS TO BE SEALED AND TESTED TO MEET REQUIREMENTS OF 401.3



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APPLICANT: JUAN SOSA

LAYOUT BY: EBR DRAWN: RH CHECKED: SCALE: AS INDICATED DATE: 07/22/2021 PROJECT NO.: RDC/00211 REVISIONS: NOTES:



8/16/21


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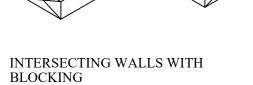
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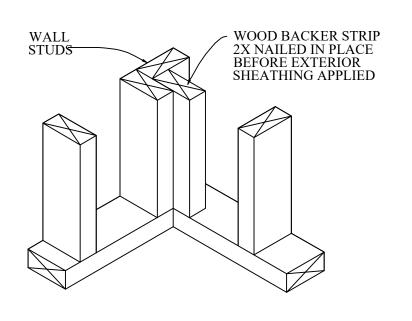
CONSTRUCTION **DETAILS**

SHEET NUMBER:

S-0.0





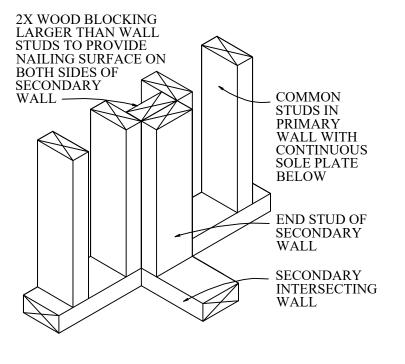

INSULATED WALL DETAILS


2X TOP PLATES OVERLAP AT CORNER LOCKING WALLS TOGETHER

TOP PLATE FRAMING DETAIL


CORNER BLOCKING DETAIL

S-1.0 / SCALE:NTS

S-1.0 / SCALE:NTS

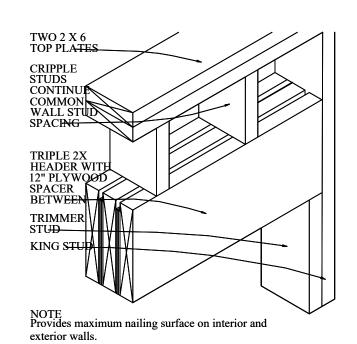




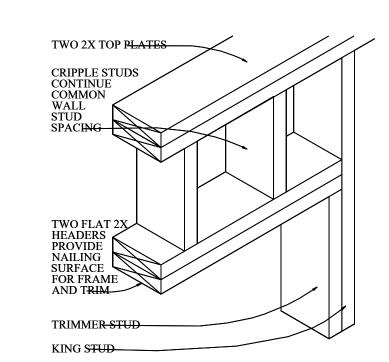







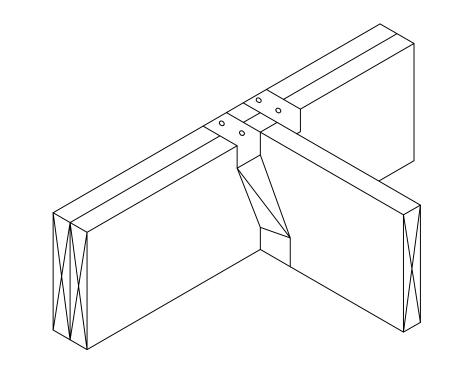


JOIST SUPPORTED ON WOOD GIRDERS S-1.0 / SCALE:NTS

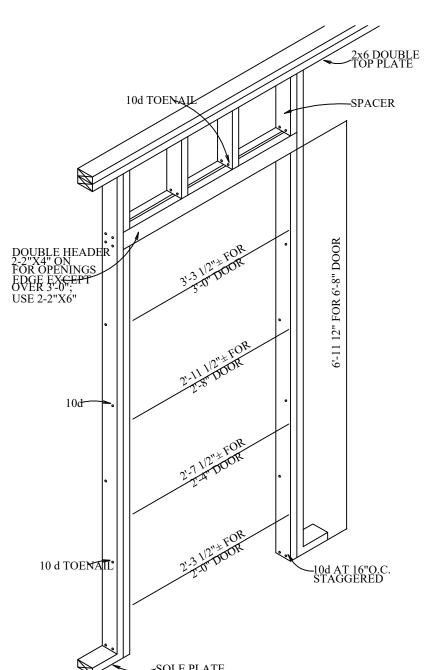

DOOR OPENING DETAIL S-1.0 / SCALE:NTS

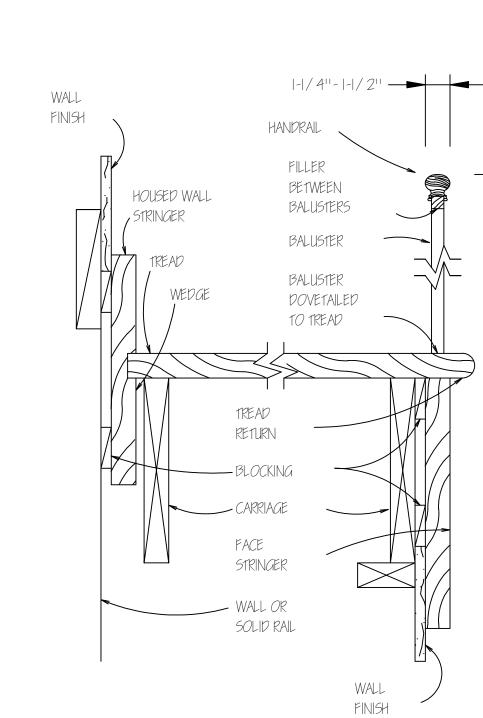

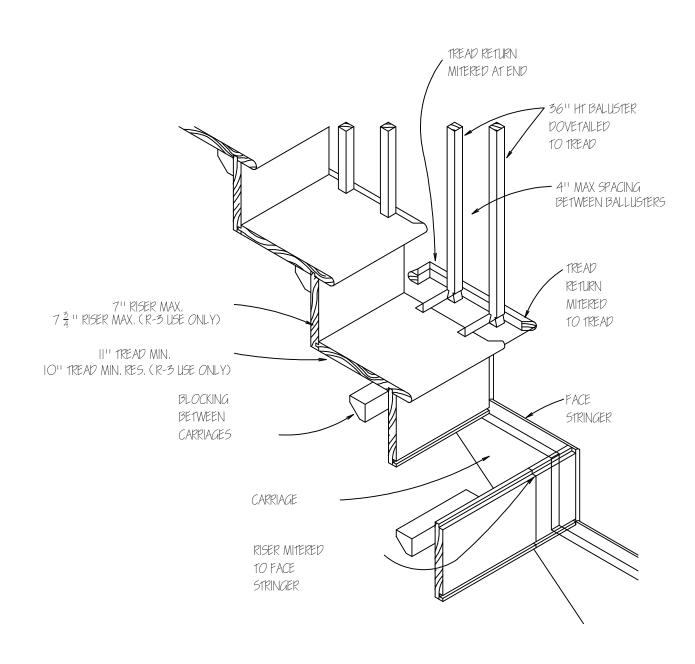

STAIRS DETAIL S-1.0 / SCALE:NTS



CHANGE ILE FAMIL 42 DEVENS STREET MARLBOROUGH, MA 01 PROPOSED RENOVATION /

APPLICANT: JUAN SOSA

LAYOUT BY: EBR DRAWN: RH SCALE: AS INDICATED DATE: 07/22/2021 PROJECT NO.: RDC/00211 REVISIONS: NOTES:



8/16/21


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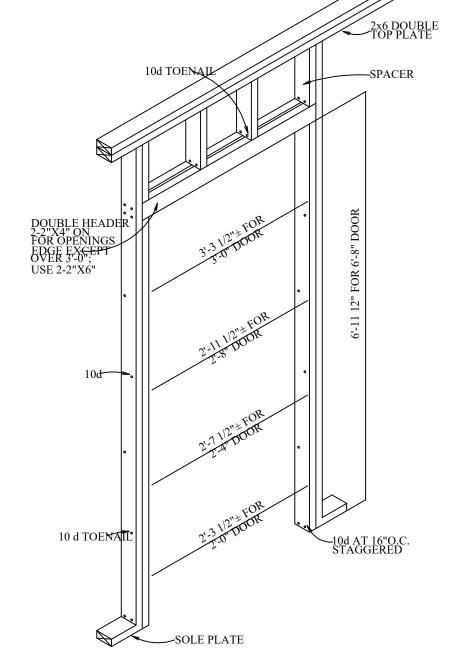
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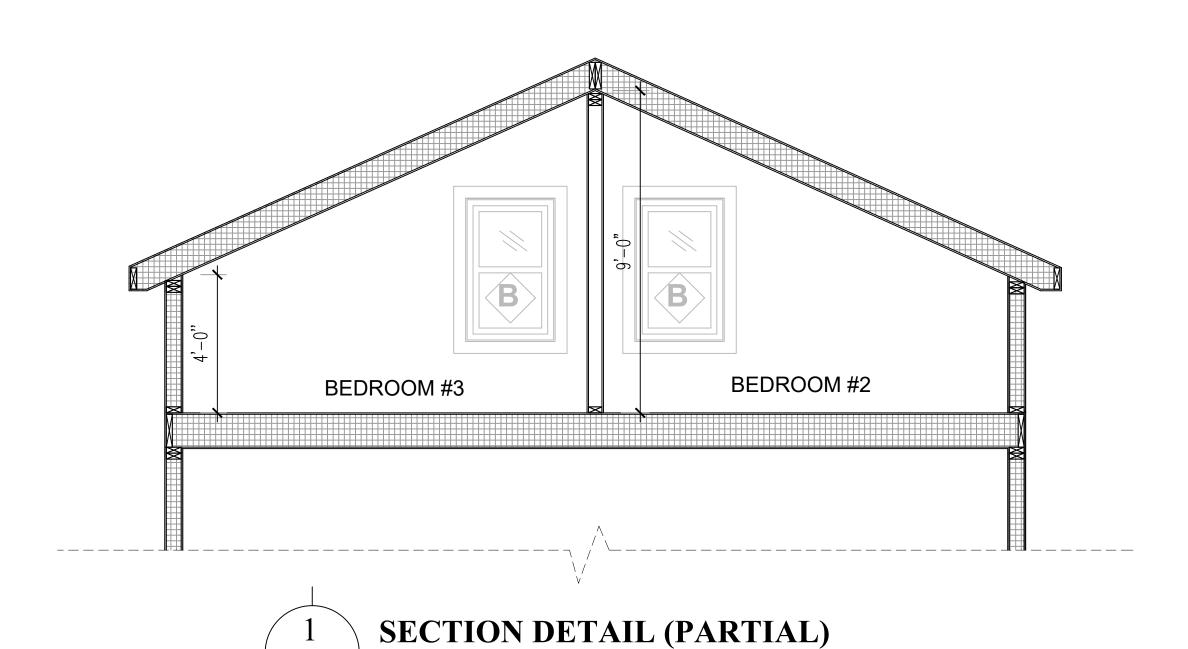
CONSTRUCTION **DETAILS**

SHEET NUMBER:

S-1.0






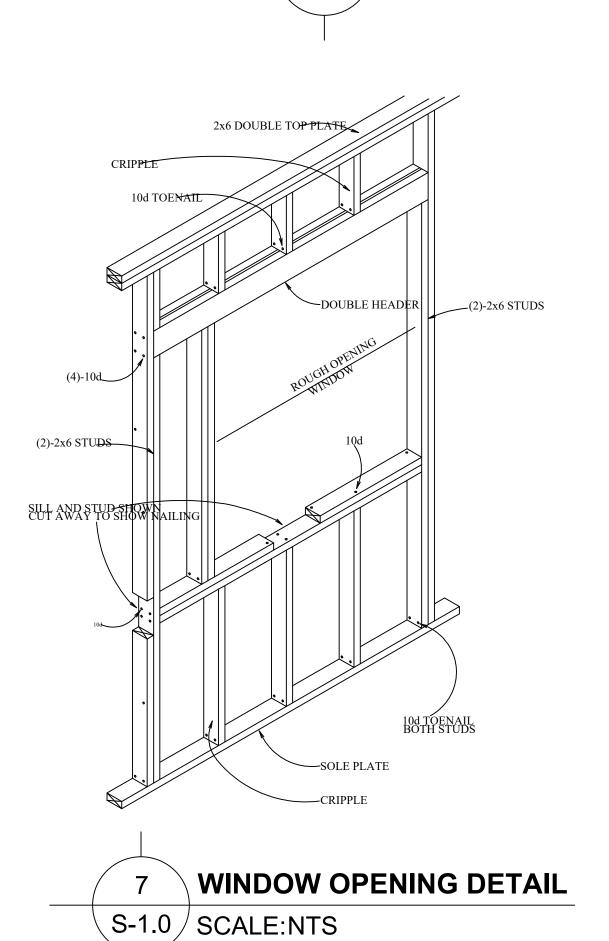


NOTES:

SCALE:1/4"=1'-0"

- CONTRACTOR RESPONSIBLE TO GET LVL SPECS. SHEETS FROM CERTIFIED MANUFACTURING SUPPLIER.
 CONTRACTOR RESPONSIBLE TO
- CONTRACTOR RESPONSIBLE TO TRANSFER VERTICAL LOADS STRAIGHT DOWN TO BASEMENT COLUMNS AND FOOTINGS/FOUNDATION.

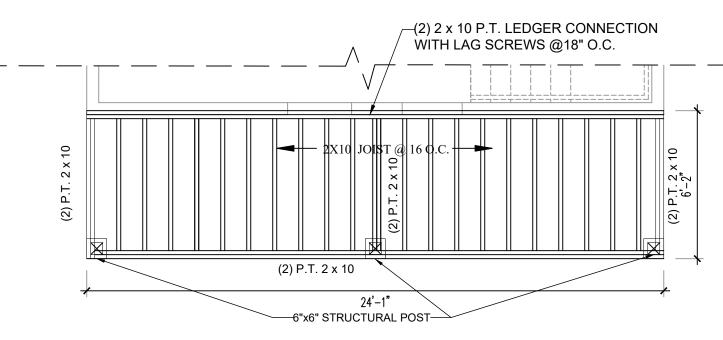


PROPOSED FRONT PORCH FRAMING PLAN
S-1.1 SCALE:1/4"=1'-0"

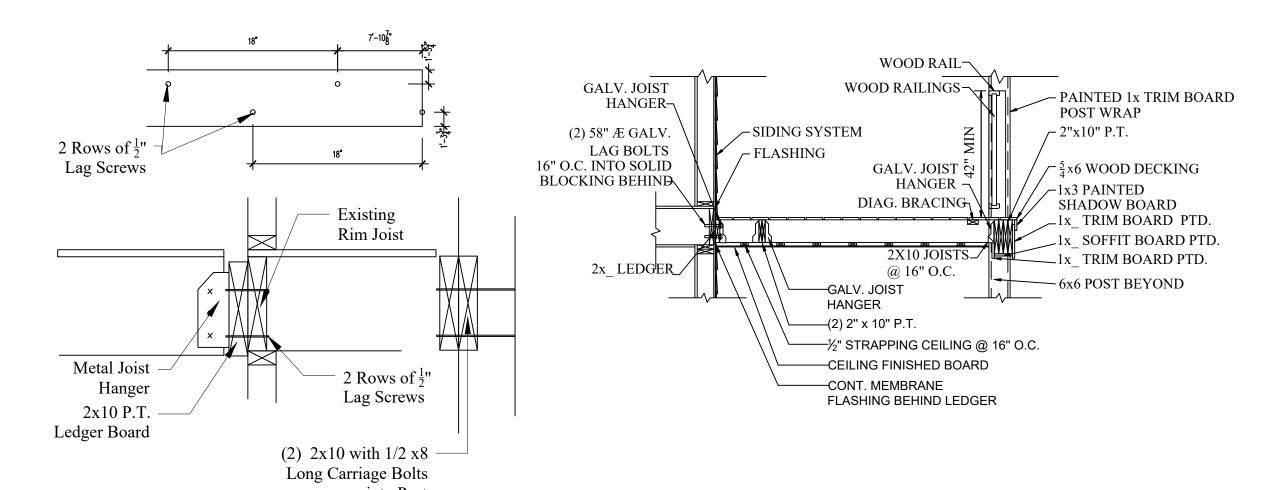

FRONT PORCH LEDGER CONNECTION


1 SCALE:1/4"=1'-0"

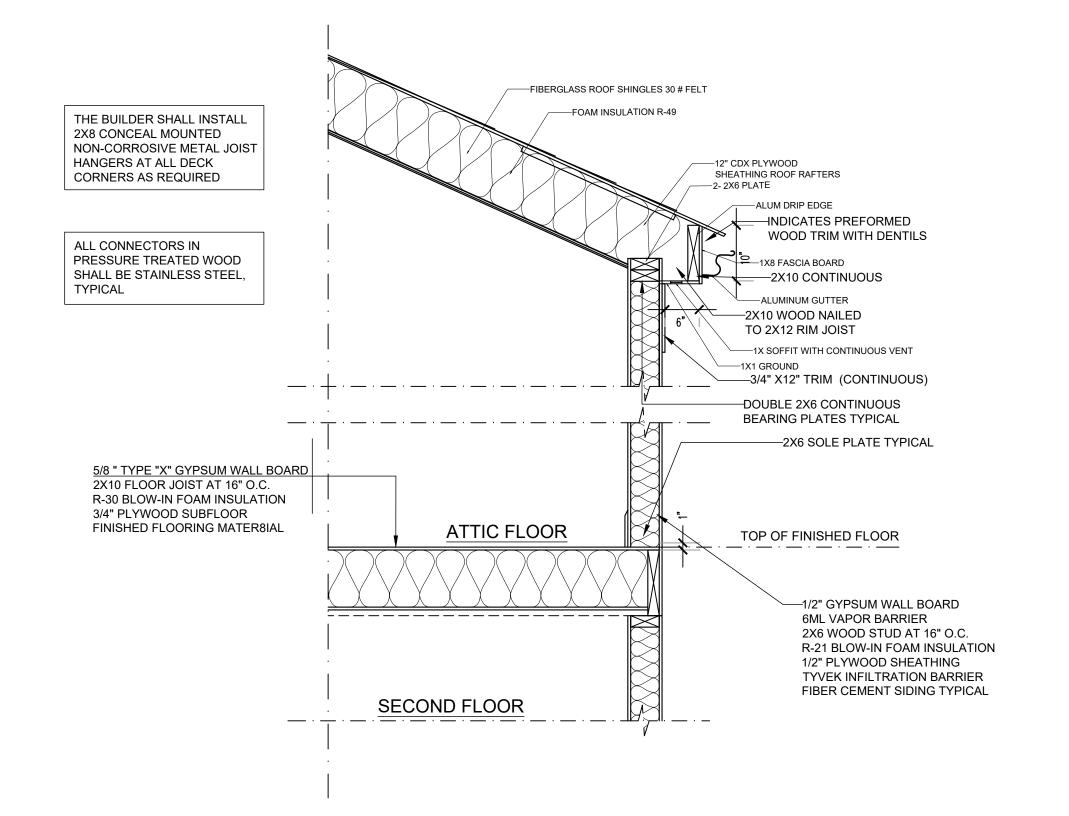


SECTION DETAIL / CEILING AND ROOF ASSEMBLY (PARTIAL)

SCALE: 1/4"-1" 0"

S-1.1 SCALE:1/4"=1'-0"

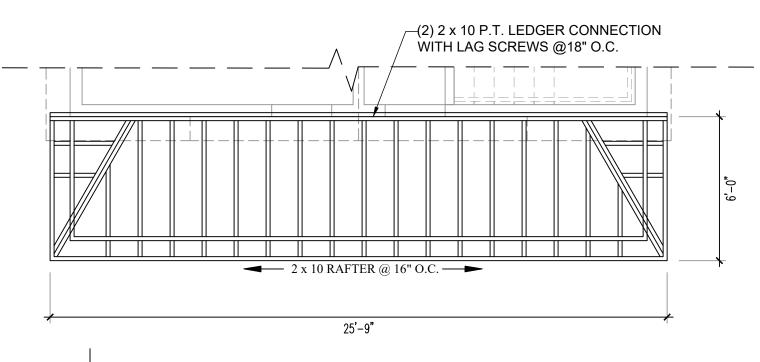

4 PROPOSED ROOF FRAMING PLAN S-1.1 SCALE:1/4"=1'-0"

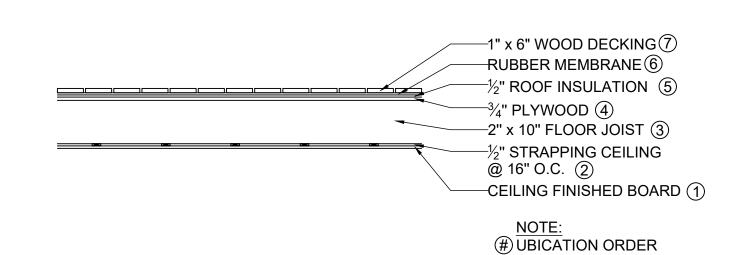

FRONT PORCH SECTION DETAIL
S-1.1 SCALE:1/4"=1'-0"



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42 DEVENS STRE MARLBOROUGH, MA

PROPOSED RENOVATION / CHANGE OF OCCUPANCY FROM SINGLE FAMIL' TO TWO FAMILY DWELLING

APPLICANT: JUAN SOSA

LAYOUT BY: EBR

DRAWN: RH

CHECKED:

SCALE: AS INDICATED

DATE: 07/22/2021

PROJECT NO.: RDC/00211

REVISIONS: NOTES: DATE



8/16/21

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DRAWING TITLE:

CONSTRUCTION DETAILS

SHEET NUMBER:

S-1.1