# RECONSTRUCTION OF WITHERBEE STREET AND APPURTENANT WORK

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# 1"=180' $\widetilde{\overset{\text{RT}}{20}}$

PREPARED BY: City of Marlborough

Department of Public Works Engineering Division 135 Neil Street Marlborough, MA 01752 CONTRACT NO. ED 2023-10 September 14, 2023 UNLESS OTHERWISE PROVIDED FOR IN THE PROJECT SPECIFICATIONS, THE FOLLOWING DOCUMENTS SHALL GOVERN THE CONSTRUCTION ON THIS PROJECT:

-THE 2023 MHD STANDARD SPECIFICATIONS FOR HIGHWAYS AND BRIDGES....AS AMENDED

AND BRIDGES....AS AMENDED
-THE 2006 PROJECT DEVELOPMENT & DESIGN GUIDE....AS

AMENDED
- THE OCTOBER 2017 CONSTRUCTION STANDARD DETAILS

HIGHWAY DIVISION AND ANY AMENDMENTS THERETO
-THE AMERICAN STANDARD FOR NURSERY STOCK (ANSI Z60.1)

# LEGEND RIGHT OF WAY EXISTING CONTOUR (MAJOR) — — 100 — — — EXISTING CONTOUR (MINOR) PROPOSED CONTOUR (MAJOR) PROPOSED CONTOUR (MINOR) PROPERTY LINE EASEMENT LINE TREELINE CHAIN LINK FENCE GAURDRAIL \_\_\_\_\_ WATER LINE SEWER LINE SEWER FORCE MAIN DRAIN LINE UNDERGROUND ELECTRIC TELECOMMUNICATIONS OVERHEAD WIRES HYDRANT GAS VALVE WATER VALVE SANITARY SEWER MANHOLE STORM SEWER MANHOLE TELECOMMUNICATIONS MANHOLE ELECTRIC MANHOLE CATCH BASIN SIGN UTILITY POLE WATER SHUTOFF WATER MAIN CAP WATER MAIN TEE SHRUB HANDHOLD F.E.O. IRON PIN (FND) GUY POLE TRAFFIC LIGHT 0€ SPOT ELEVATION (EXISTING) 100.50 100.50 SPOT ELEVATION (PROPOSED) TC/BC TOP/BOTTOM OF CURB TOP/BOTTOM OF WALL TW/BW **─**₩**-**FLOW ARROW HATCHES: STRUCTURE RIPRAP CONCRETE WETLANDS \*NOTE: EXISTING INFRASTRUCTURE AND HATCHES ARE

SHOWN IN LIGHT GRAY ON CONSTRUCTION PLANS

### CONSTRUCTION ABBREVIATIONS

ADJ= ADJUST

HMA= HOT MIX ASPHALT

CB= CATCH BASIN

CONC= CONCRETE

DMH= DRAIN MANHOLE

DWP= DETECTIBLE WARNING PANEL

DYCL= DOUBLE YELLOW CENTERLINE

GG= GAS GATE

EOP= EDGE OF PAVEMENT

EX= EXISTING

GUY= GUY WIRE

HH= HAND HOLE

HYD= HYDRANT

LCB= LAND COURT BOUND

OHW= OVERHEAD WIRE

PL= PROPERTY LINE

PROP= PROPOSED

R&R= REMOVE AND RESET

R&S= REMOVE AND STACK

ROW= RIGHT OF WAY

SMH= SEWER MANHOLE

SW= SIDEWALK

SWEL= SINGLE WHITE EDGE LINE

TCB= TRAFFIC CONTROL BOX

TYP= TYPICAL

UP= UTILITY POLE

WCR= WHEELCHAIR RAMP

WG= WATER GATE

#### PAVEMENT NOTES

PROPOSED FULL DEPTH RECONSTRUCTION

SURFACE: 4.25" HOT MIX ASPHALT

1.75" SUPERPAVE SURFACE COURSE - 9.5 (SSC-9.5)
2.5" SUPERPAVE INTERMEDIATE COURSE - 19.0 (SIC-19.0)

ASPHALT EMULSION FOR TACK COAT AT 0.05 GAL/SY OVER BASE COURSE AND INTERMEDIATE COURSE

SUB-BASE: 12" SUB-BASE FOR RECLAIM

PROPOSED HOT MIX ASPHALT DRIVEWAY

SURFACE: 3" HOT MIX ASPHALT

1.5" SUPERPAVE SURFACE COURSE - 9.5 (SSC-9.5)
1.5" SUPERPAVE INTERMEDIATE COURSE - 19.0 (SIC-19.0)

SUB-BASE: 8" GRAVEL BORROW TYPE C

#### PROPOSED HOT MIX ASPHALT PARKING LOT

SURFACE: 4" HOT MIX ASPHALT

1.5" SUPERPAVE SURFACE COURSE - 9.5 (SSC-9.5)
2.5" SUPERPAVE INTERMEDIATE COURSE - 19.0 (SIC-19.0)

SUB-BASE: 12" GRAVEL BORROW TYPE C

PROPOSED CEMENT CONCRETE DRIVEWAY/WHEELCHAIR RAMP

SURFACE: 6" CEMENT CONCRETE AIR ENTRANED 4000 PSI  $\frac{3}{4}$ : 810


SUB-BASE: 8" GRAVEL BORROW TYPE C

PROPOSED CEMENT CONCRETE SIDEWALK

SURFACE: 4" CEMENT CONCRETE AIR ENTRANED 4000 PSI 3: 810

SUB-BASE: 8" GRAVEL BORROW TYPE C

WITHERBEE STREET TYPICAL SECTION STA. 0+00± TO STA. 7+97± N.T.S

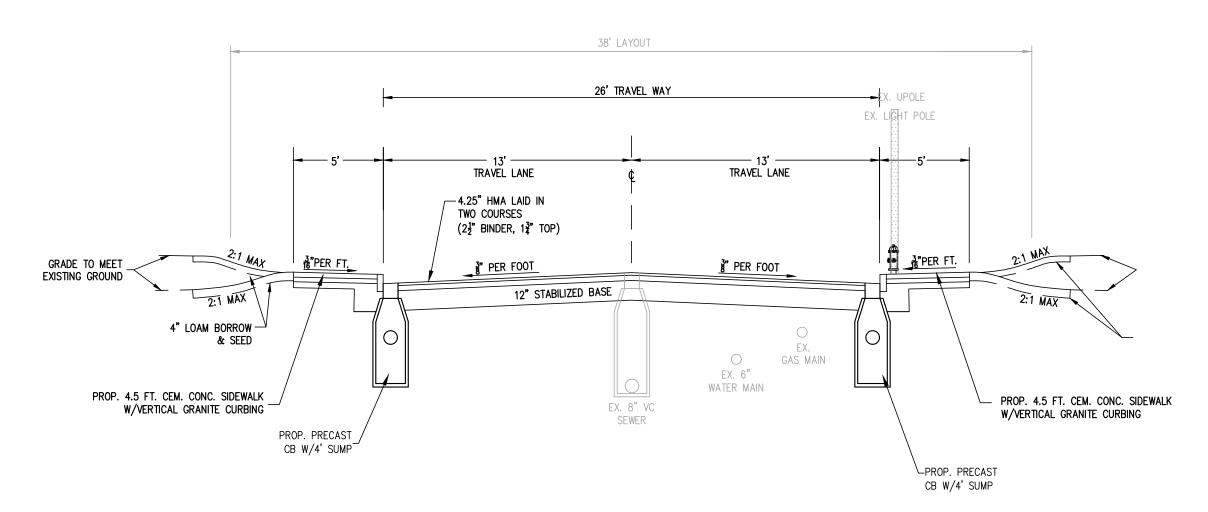

#### CONSTRUCTION NOTES

1. BASE PLANS AND TOPOGRAPHIC INFORMATION WERE PREPARED FROM SURVEY DATA COMPILED BY THE CITY OF MARLBOROUGH, DEPARTMENT OF PUBLIC WORKS, ENGINEERING DIVISION.

2. EXISTING UTILITIES, WHERE SHOW HEREON, ARE APPROXIMATE. THE CONTRACTOR SHALL BE RESPONSIBLE FOR PROPERLY LOCATING AND COORDINATING ANY ON-SITE ACTIVITY WITH DIG-SAFE AND THE APPROPRIATE UTILITY COMPANY AND MAINTAINING EXISTING UTILITY SYSTEM SERVICE. DIG-SAFE SHALL BE NOTIFIED PER THE COMMONWEALTH OF MASSACHUSETTS STATUTE CHAPTER 82, SECTION 40, AT 1-888-344-7233. NO GUARANTEE IS IMPLIED OR INTENDED AS TO THE ACCURACY, LOCATION OR THAT ALL UTILITIES AND/OR SUBSURFACE STRUCTURES ARE SHOWN. THE CONTRACTOR SHALL VERIFY SIZE, LOCATION AND INVERTS OR UTILITIES AND STRUCTURES AS REQUIRED PRIOR TO THE START OF CONSTRUCTION.

3. THE CONTRACTOR SHALL ALTER THE MASONRY OF THE TOP SECTION OF ALL EXISTING DRAINAGE AND SEWER STRUCTURES AS NECESSARY FOR CHANGES IN GRADE AND RESET ALL WATER, SEWER AND DRAINAGE FRAMES, GRATES AND BOXES TO THE PROPOSED FINISH GRADE. STRUCTURE ADJUSTMENTS SHALL REQUIRE THE USE OF RED CLAY BRICK CONFORMING TO M4.05.2 AND CEMENT CONCRETE CONFORMING TO M4.02.0 OF THE COMMONWEALTH OF MASSACHUSETTS CONSTRUCTION STANDARDS FOR HIGHWAY AND BRIDGES AS MOST RECENTLY AMENDED.

4. THE CONTRACTOR SHALL MAKE ALL ARRANGEMENTS FOR THE ALTERATION AND ADJUSTMENT OF ELECTRIC, TELEPHONE, AND ANY OTHER PRIVATE UTILITIES BY THE UTILITY COMPANIES AT NO ADDITIONAL COST TO THE OWNER. IF THE CONTRACTOR ADJUSTS UTILITY COVERS IT SHALL BE DEEMED PART OF THE WORK AND THERE WILL BE NO ADDITIONAL COMPENSATION.

5. TREES AND SHRUBS WITHIN THE LIMITS OF GRADING SHALL BE REMOVED ONLY UPON APPROVAL OF THE CITY ENGINEER.

6. AREAS OUTSIDE THE LIMITS OF PROPOSED WORK DISTURBED BY THE CONTRACTOR'S OPERATIONS SHALL BE RESTORED BY THE CONTRACTOR TO THEIR ORIGINAL CONDITION AT THE CONTRACTOR'S EXPENSE.

7. THE TERM "PROPOSED" (PROP.) MEANS WORK TO BE CONSTRUCTED USING NEW MATERIALS OR WHERE APPLICABLE, AND APPROVED BY THE CITY ENGINEER, RE-USING EXISTING MATERIALS SUCH AS THOSE IDENTIFIED AS "REMOVE AND RESET" (R&R).

8. JOINTS BETWEEN NEW HOT MIX ASPHALT, ROADWAY PAVEMENT, AND THE LOCATIONS OF SAW CUT FOR EXISTING PAVEMENT SHALL BE SEALED WITH HOT APPLIED ASPHALTIC CRACK FILLER.

9.AREAS OUTSIDE THE LIMITS OF PROPOSED WORK DAMAGED BY THE CONTRACTOR'S OPERATIONS, INCLUDING STAGING AREAS, SHALL BE RESTORED BY THE CONTRACTOR TO THEIR ORIGINAL CONDITION AT THE CONTRACTOR'S EXPENSE.

10. THE CONTRACTOR'S ATTENTION IS DIRECTED TO THE NECESSITY OF MAKING HIS OWN INVESTIGATION IN ORDER TO ASSURE THAT NO DAMAGE TO EXISTING STRUCTURES, DRAINAGE LINES, TRAFFIC SIGNAL CONDUITS, ETCETERA, WILL OCCUR. THE CONTRACTOR SHALL NOTIFY MASSACHUSETTS DIG SAFE AND PROCURE A DIG SAFE NUMBER FOR EACH LOCATION PRIOR TO DISTURBING EXISTING GROUND IN ANY WAY. NO EXISTING PUBLIC UTILITY STRUCTURES SHALL BE ABANDONED AND/OR DISMANTLED WITHOUT AUTHORIZATION FROM THE ENGINEER.

11. GAS MAINS AND TELEPHONE LINES ARE ASSUMED TO HAVE 3 FEET OF COVER UNLESS NOTED OTHERWISE. WATER MAINS ARE ASSUMED TO HAVE 5 FEET OF COVER UNLESS NOTED OTHERWISE. IT IS NOT WARRANTED THAT ALL UTILITIES ARE SHOWN OR THAT THEY ARE PLACED AT THESE ASSUMED DEPTHS. THE CONTRACTOR IS RESPONSIBLE FOR COORDINATING THE RELOCATION OF ANY CONFLICTING UTILITIES WITH THE RESPECTIVE UTILITY COMPANY. RELOCATION OF UTILITIES AND/OR THEIR APPURTENANCES REQUIRED TO ACCOMMODATE THE NEW WORK SHALL BE THE RESPONSIBILITY OF THE CONTRACTOR. FOR THE COST INFORMATION CONCERNING RELOCATION OF UTILITIES SEE SPECIFICATIONS GENERAL CONDITIONS 25 NOTICE TO UTILITIES.

12. ALL EXISTING STATE, COUNTY, CITY AND TOWN LINES AND PRIVATE PROPERTY LINES HAVE BEEN ESTABLISHED FROM AVAILABLE INFORMATION AND THEIR EXACT LOCATION ARE NOT GUARANTEED.

13. BACKFILL SHALL BE UNIFORMLY DISTRIBUTED IN SUCCESSIVE LAYERS, EACH LAYER BEING THOROUGHLY COMPACTED BEFORE THE SUCCEEDING LAYER IS PLACED. THE ENTIRE WIDTH OF THE TRENCH SHALL BE MECHANICALLY OR HAND TAMPED IN SIX (6) INCH LIFTS, A MINIMUM OF TWO (2) FEET ABOVE UTILITY INSTALLATION, AND MECHANICALLY TAMPED THE REMAINDER OR THE FILL IN LIFT DEPTHS NOT GREATER THAN SIX (6) INCHES. THE TOP LAYER OF BACKFILL SHALL BE FOURTEEN (14) INCHES (IN A TEMPORARY TRENCH), AND TWELVE (12) INCHES (IN A PERMANENT TRENCH) OF GRAVEL COMPACTED TO 97% OF MAXIMUM DENSITY.

14. ALL STRUCTURES TO BE REMODELED UNLESS OTHERWISE NOTED.

15. ALL CASTINGS TO BE REPLACED UNLESS OTHERWISE NOTED.

16. ALL SEEDING WORK SHALL BE CARRIED OUT BY AN APPROVED SPRAYING MACHINE SPECIFICALLY USED FOR THIS WORK AND NOT PLACED BY HAND.

17. ALL DRIVEWAYS SHALL BE SAW-CUT AT BLENDING LIMITS SHOWN, OR AS DIRECTED BY THE ENGINEER.


18. ALL WATER GATE BOX TOP SECTIONS TO BE REPLACED.

19. THE CONTRACTOR SHALL COORDINATE WITH EVERSOURCE GAS FOR THE ADJUSTMENT OF GAS GATES & SERVICE BOXES.

20. WHERE SHOWN, EROSION CONTROLS SHALL BE ERECTED AND APPROVED BY THE ENGINEER PRIOR TO START OF WORK. CONTRACTOR SHALL ENSURE THAT NO SILT-LADEN RUNOFF LEAVES THE WORK SITE.

21. THE SURFACE OF CEMENT CONCRETE SIDEWALK AND PEDESTRIAN CURB RAMP PANEL SHALL BE BROOM FINISHED AND BORDERED WITH A 1.5" FINISHING TROWEL.

22. MULCH FOR BLENDING DISTURBED AREAS SHALL MATCH EXISTING.

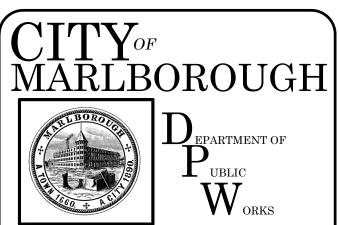

Engineering Division 135 Neil Street Marlborough, MA 01752 p. (508) 624-6910 www.marlborough-ma.gov

		REVISIONS
No.	Date	Description

Drawn By:	Designed By:	Checked By:	Approved By:	
CJL	CJL	MJD	MJD	


Project Title:

RECONSTRUCTION OF WITHERBEE STREET AND APPURTENANT WORK

Sheet Title:

NOTES AND TYPICAL SECTION

Contract No: ED-2023-10	Sheet No.:
Date: 9-14-2023	2
Scale: 1"=20'	

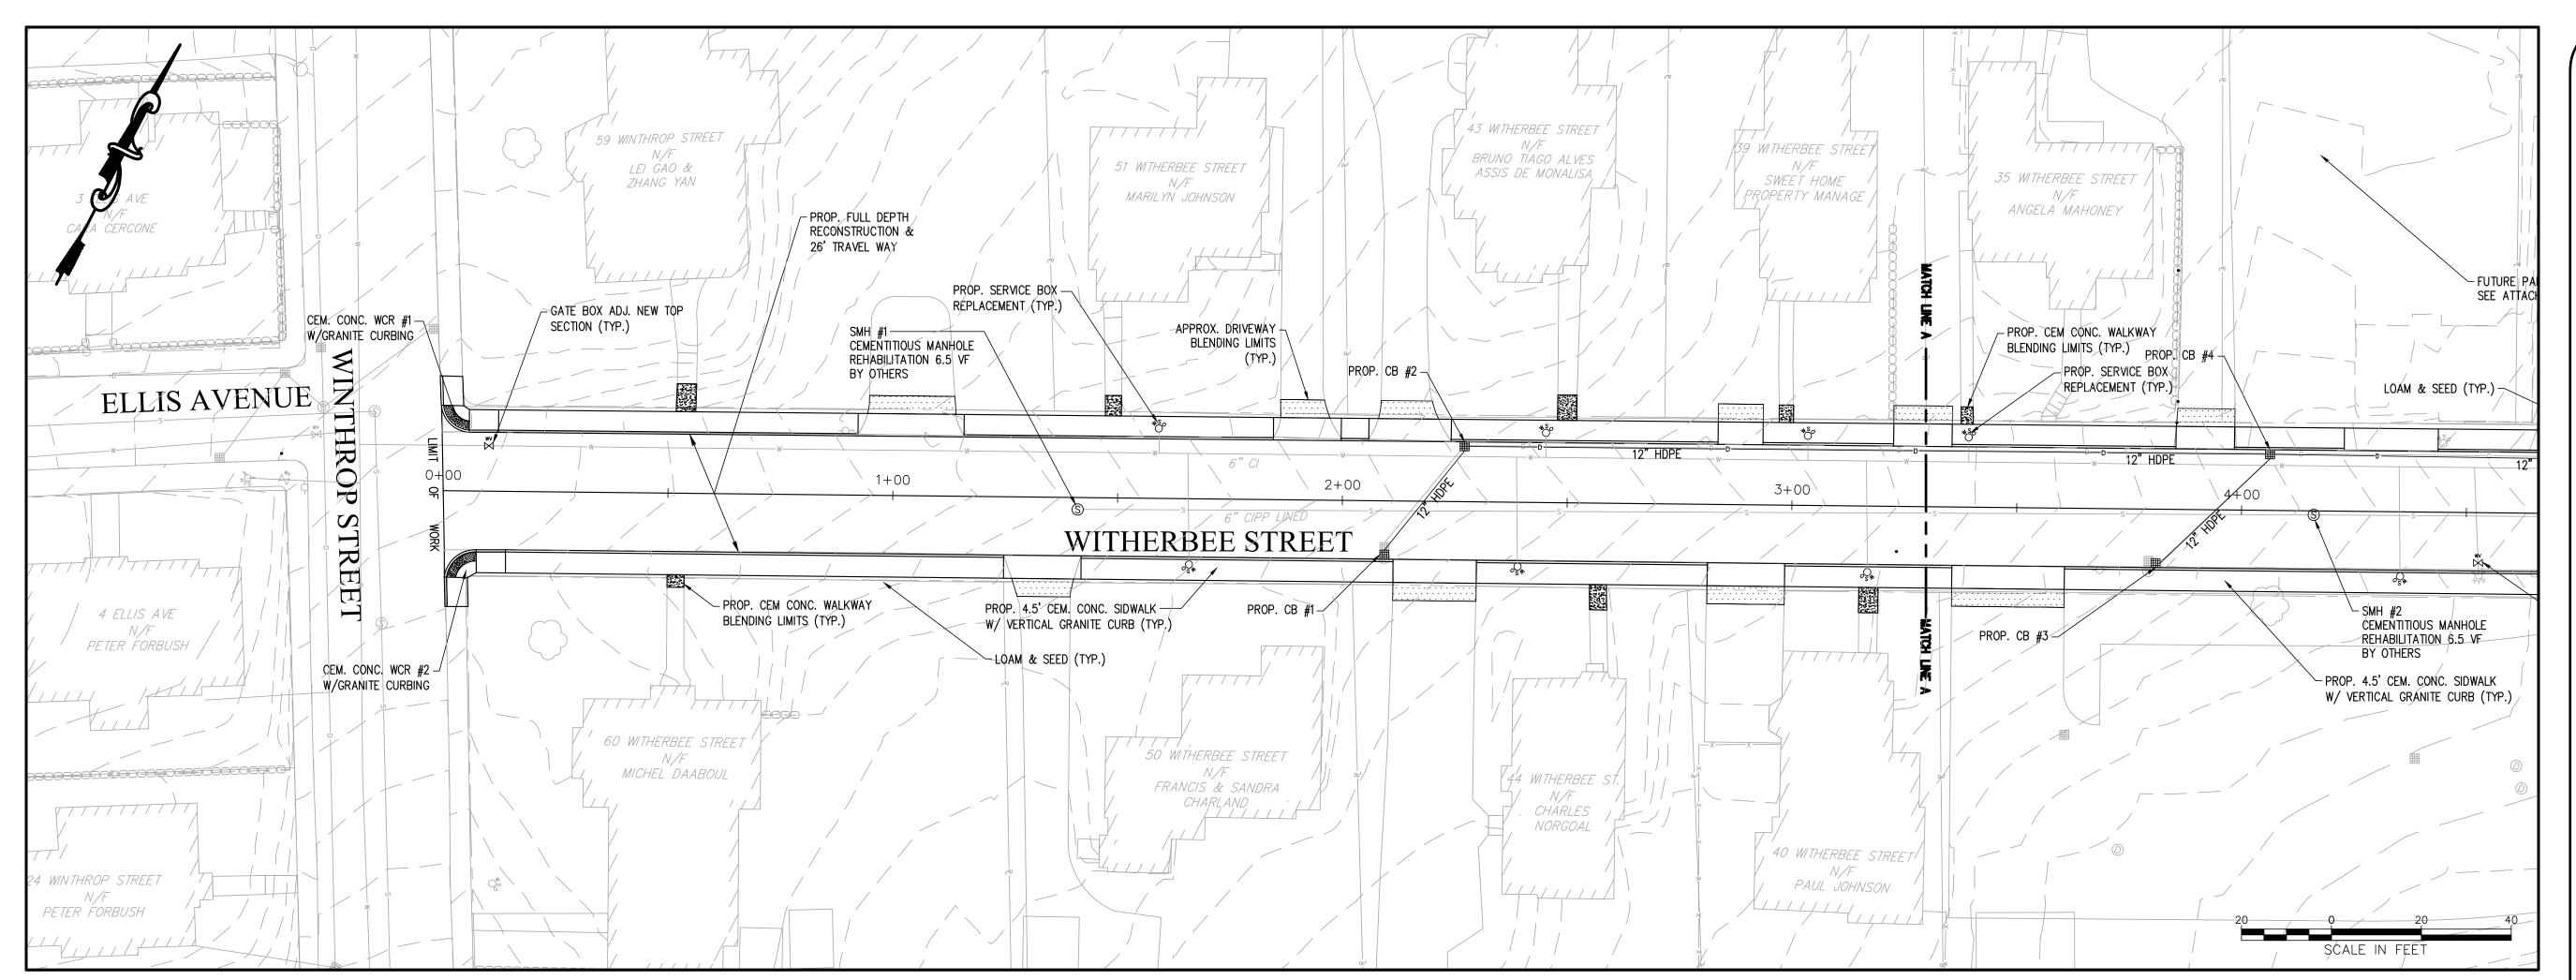

EXISTING SEWER STRUCTURE DATA							
NO.	TYPE	STATION	RIM ELEV.	INV. IN ELEV.	INV. OUT ELEV.	REMARKS	
#1	SMH	1+41 RT	463.76'		456.48'	6" UNKNOWN	
#2	SMH	4+16 RT	449.48'	442.71'	442.61'	6" UNKNOWN	
#3	SMH	8+16 RT	425.35'	418.23'	418.18'	6" UNKNOWN	

	WITHERBEE	STREET WCR	? TABLE
WCR #	STATION	TRANSITIO	N LENGTH
WCR #	STATION	HIGH SIDE	LOW SIDE
#1	0+03 LT	6'-6"	6'-6"
#2	0+03 RT	6'-6"	6'-6"
#3	7+78 LT	11'-6"	6'-6"
#4	7+80 RT	11'-6"	6'-6"

	PROPOSED SEWER STRUCTURE DATA						
NO.	TYPE	STATION	RIM ELEV.	INV. IN ELEV.	INV. OUT ELEV.	REMARKS	
#1	SMH	1+41 RT	463.75'		456.48'	REMODEL	
#2	SMH	4+16 RT	449.50'	442.71'	442.61'	REMODEL	
#3	SMH	8+16 RT	425.35'	418.23'	418.18'		

	EXISTING DRAINAGE STRUCTURE DATA						
	NO.	TYPE	STA TION	RIM ELEV.	INV. IN ELEV.	INV. OUT ELEV.	REMARKS
	#2	DMH	6+63 RT	433.80'		425.50'	8" VCP
	#7	CB	7+50 LT	428.93'	425.01'	424.58'	12" CMP
Γ	#8	CB	7+87 RT	426.13'	422.55'	422.45'	12" PVC

		PR	OPOSED DRA	AINAGE STRU	ICTURE DATA	1
NO.	TYPE	STATION	RIM ELEV.	INV. IN ELEV.	INV. OUT ELEV.	REMARKS
#1	СВ	2+10 RT	462.55'		458.13'	12" CHDPE, REMODEL
#2	СВ	2+27 LT	461.65'	457.75'	457.65'	12" CHDPE, REMODEL
#3	СВ	3+92 RT	450.95'		446.78'	12" CHDPE, REMODEL
#4	СВ	4+06 LT	450.00'	446.10'	446.00'	12" CHDPE, REMODEL
				446.10'		12" CHDPE, REMODEL
#1	DMH	5+17 LT	442.95'	438.95'	434.81	12" CHDPE, REMODEL
				435.00'		FROM PARKING LOT
<b>#</b> 5	СВ	6+16 LT	436.20'	431.89'	431.79'	12" CHDPE, REMODEL
#6	СВ	6+16 RT	436.20'		430.52'	12" CHDPE, REMODEL
#2	DMH	6+63 RT	433.80'	429.80'	428.76'	12" CHDPE, REMODEL
#7	CB	7+50 LT	428.85'	425.01'	424.67'	12" CMP
				425.05'		12" CHDPE, REMODEL
#8	CB	7+75 RT	426.10'	422.53'	422.43'	12" PVC IN, 12" RCP OU
				422.55'		12" CHDPE, REMODEL

# CITY<sup>OF</sup> MARLBOROUGH



Public Works

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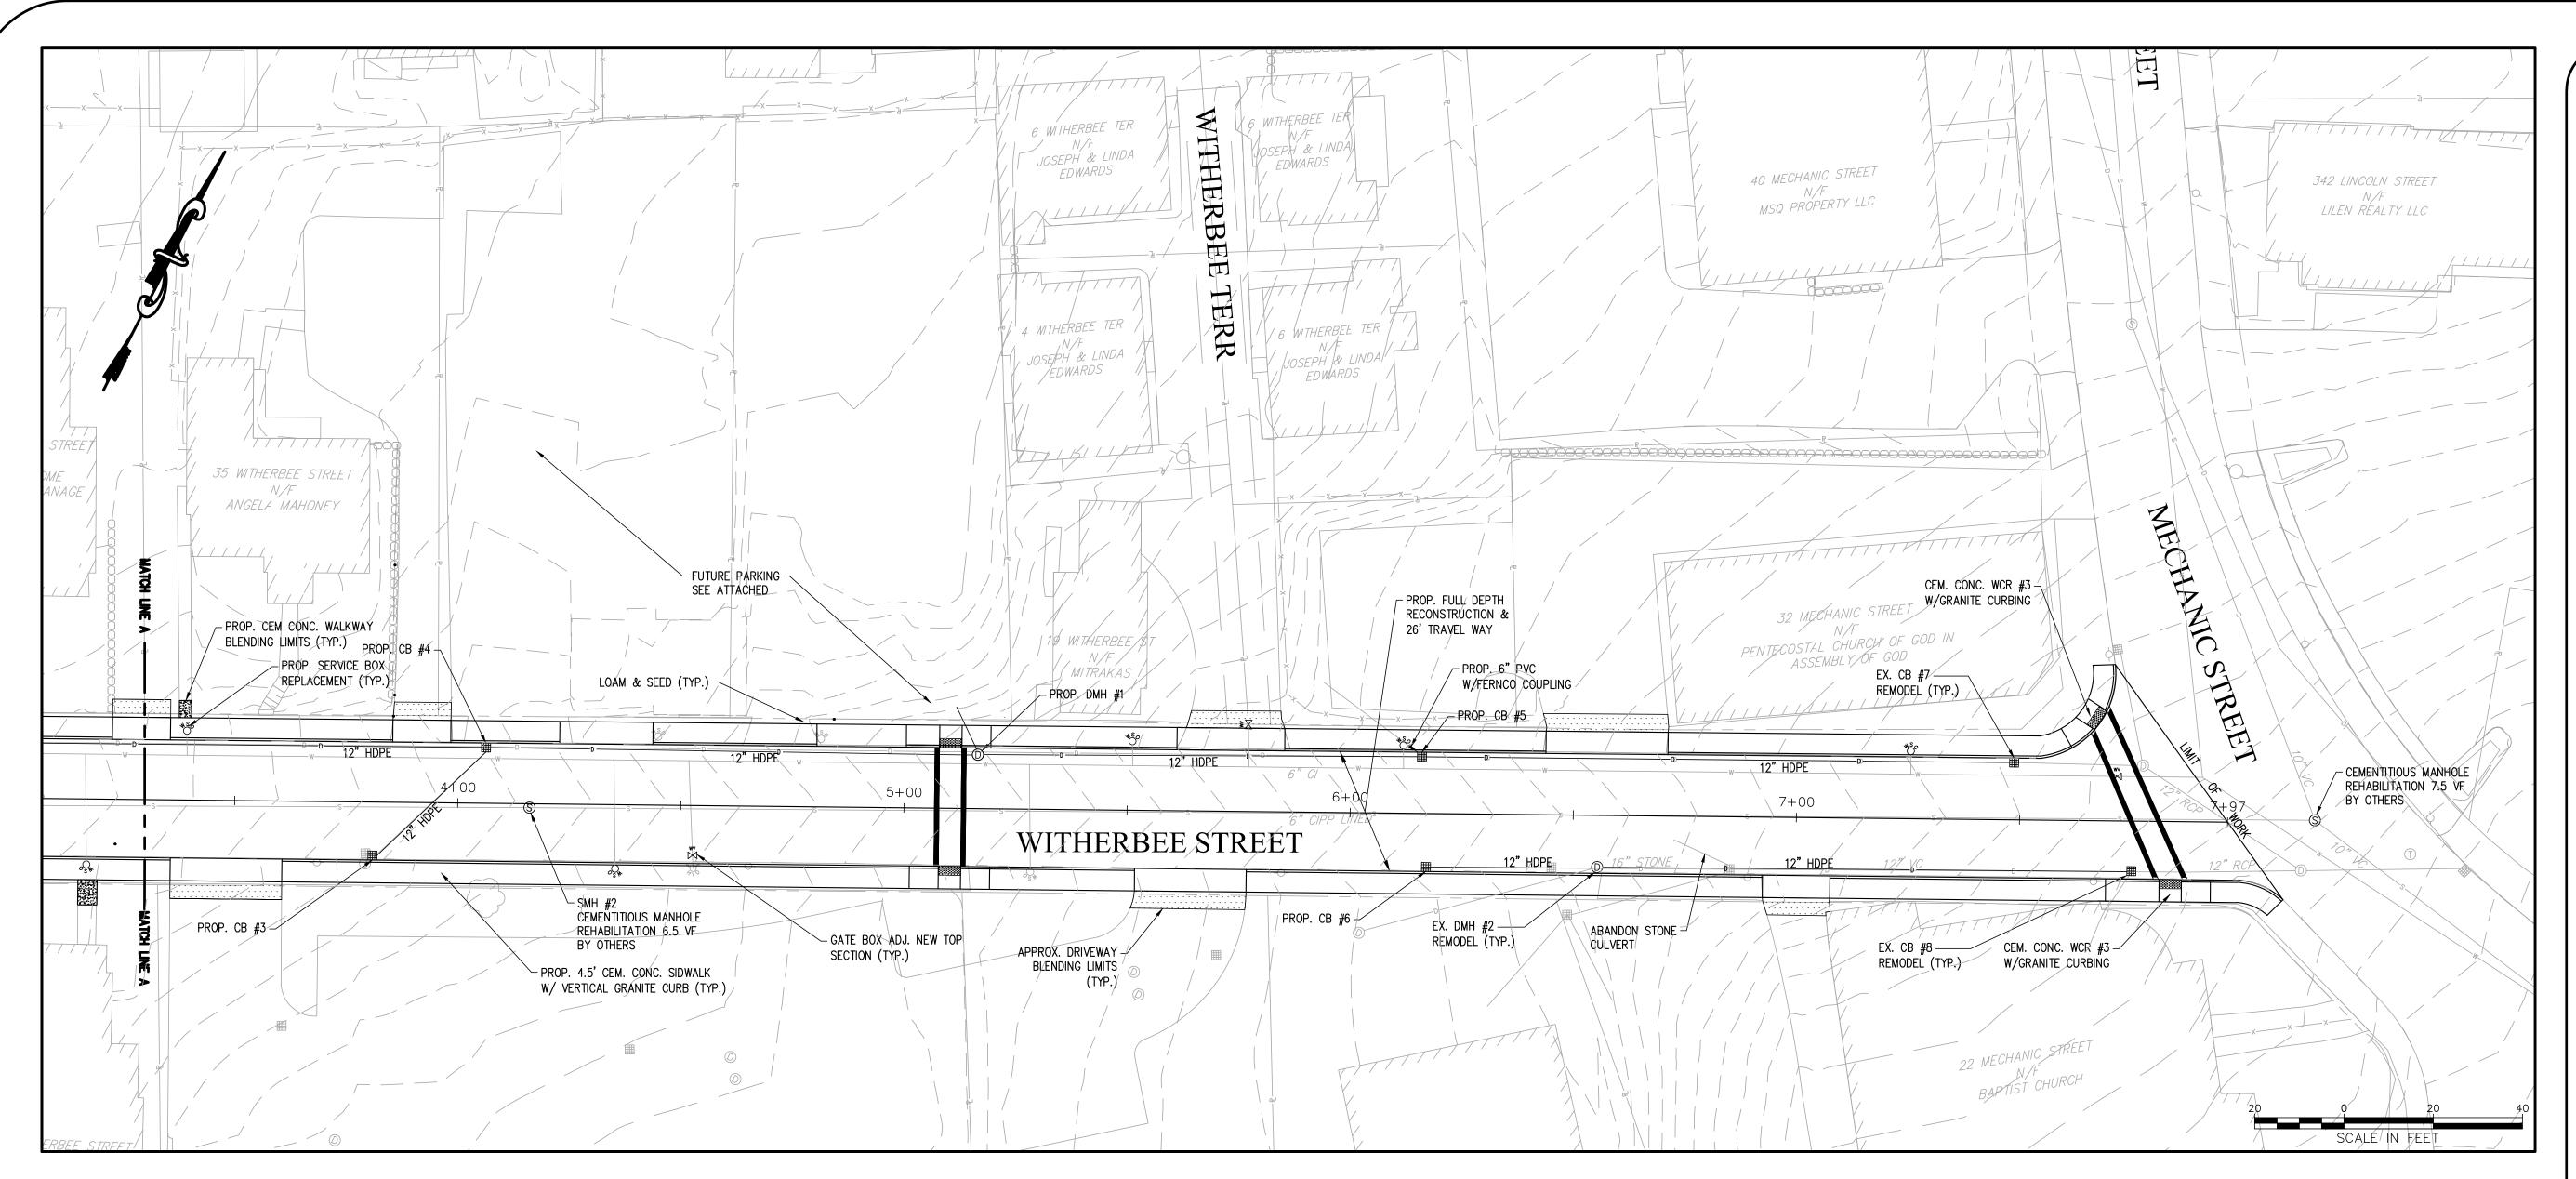
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RECONSTRUCTION OF WITHERBEE STREET AND APPURTENANT WORK

Sheet Title:

WITHERBEE STREET CONSTRUCTION PLAN

Contract No: ED-2023-10	Sheet No.:
Date: 9-14-2023	3
Scale: 1 "=20'	



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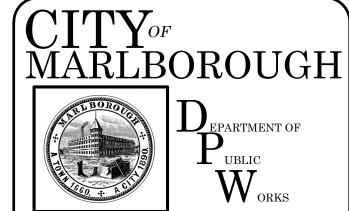
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EXISTING DRAINAGE STRUCTURE DATA						
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#6	СВ	6+16 RT	436.20'		430.52'	12" CHDPE, REMODEL
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#7	CB	7+50 LT	428.85'	425.01'	424.67'	12" CMP
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#8	CB	7+75 RT	426.10'	422.53'	422.43'	12" PVC IN, 12" RCP OUT
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PROPOSED DRAINAGE STRUCTURE DATA



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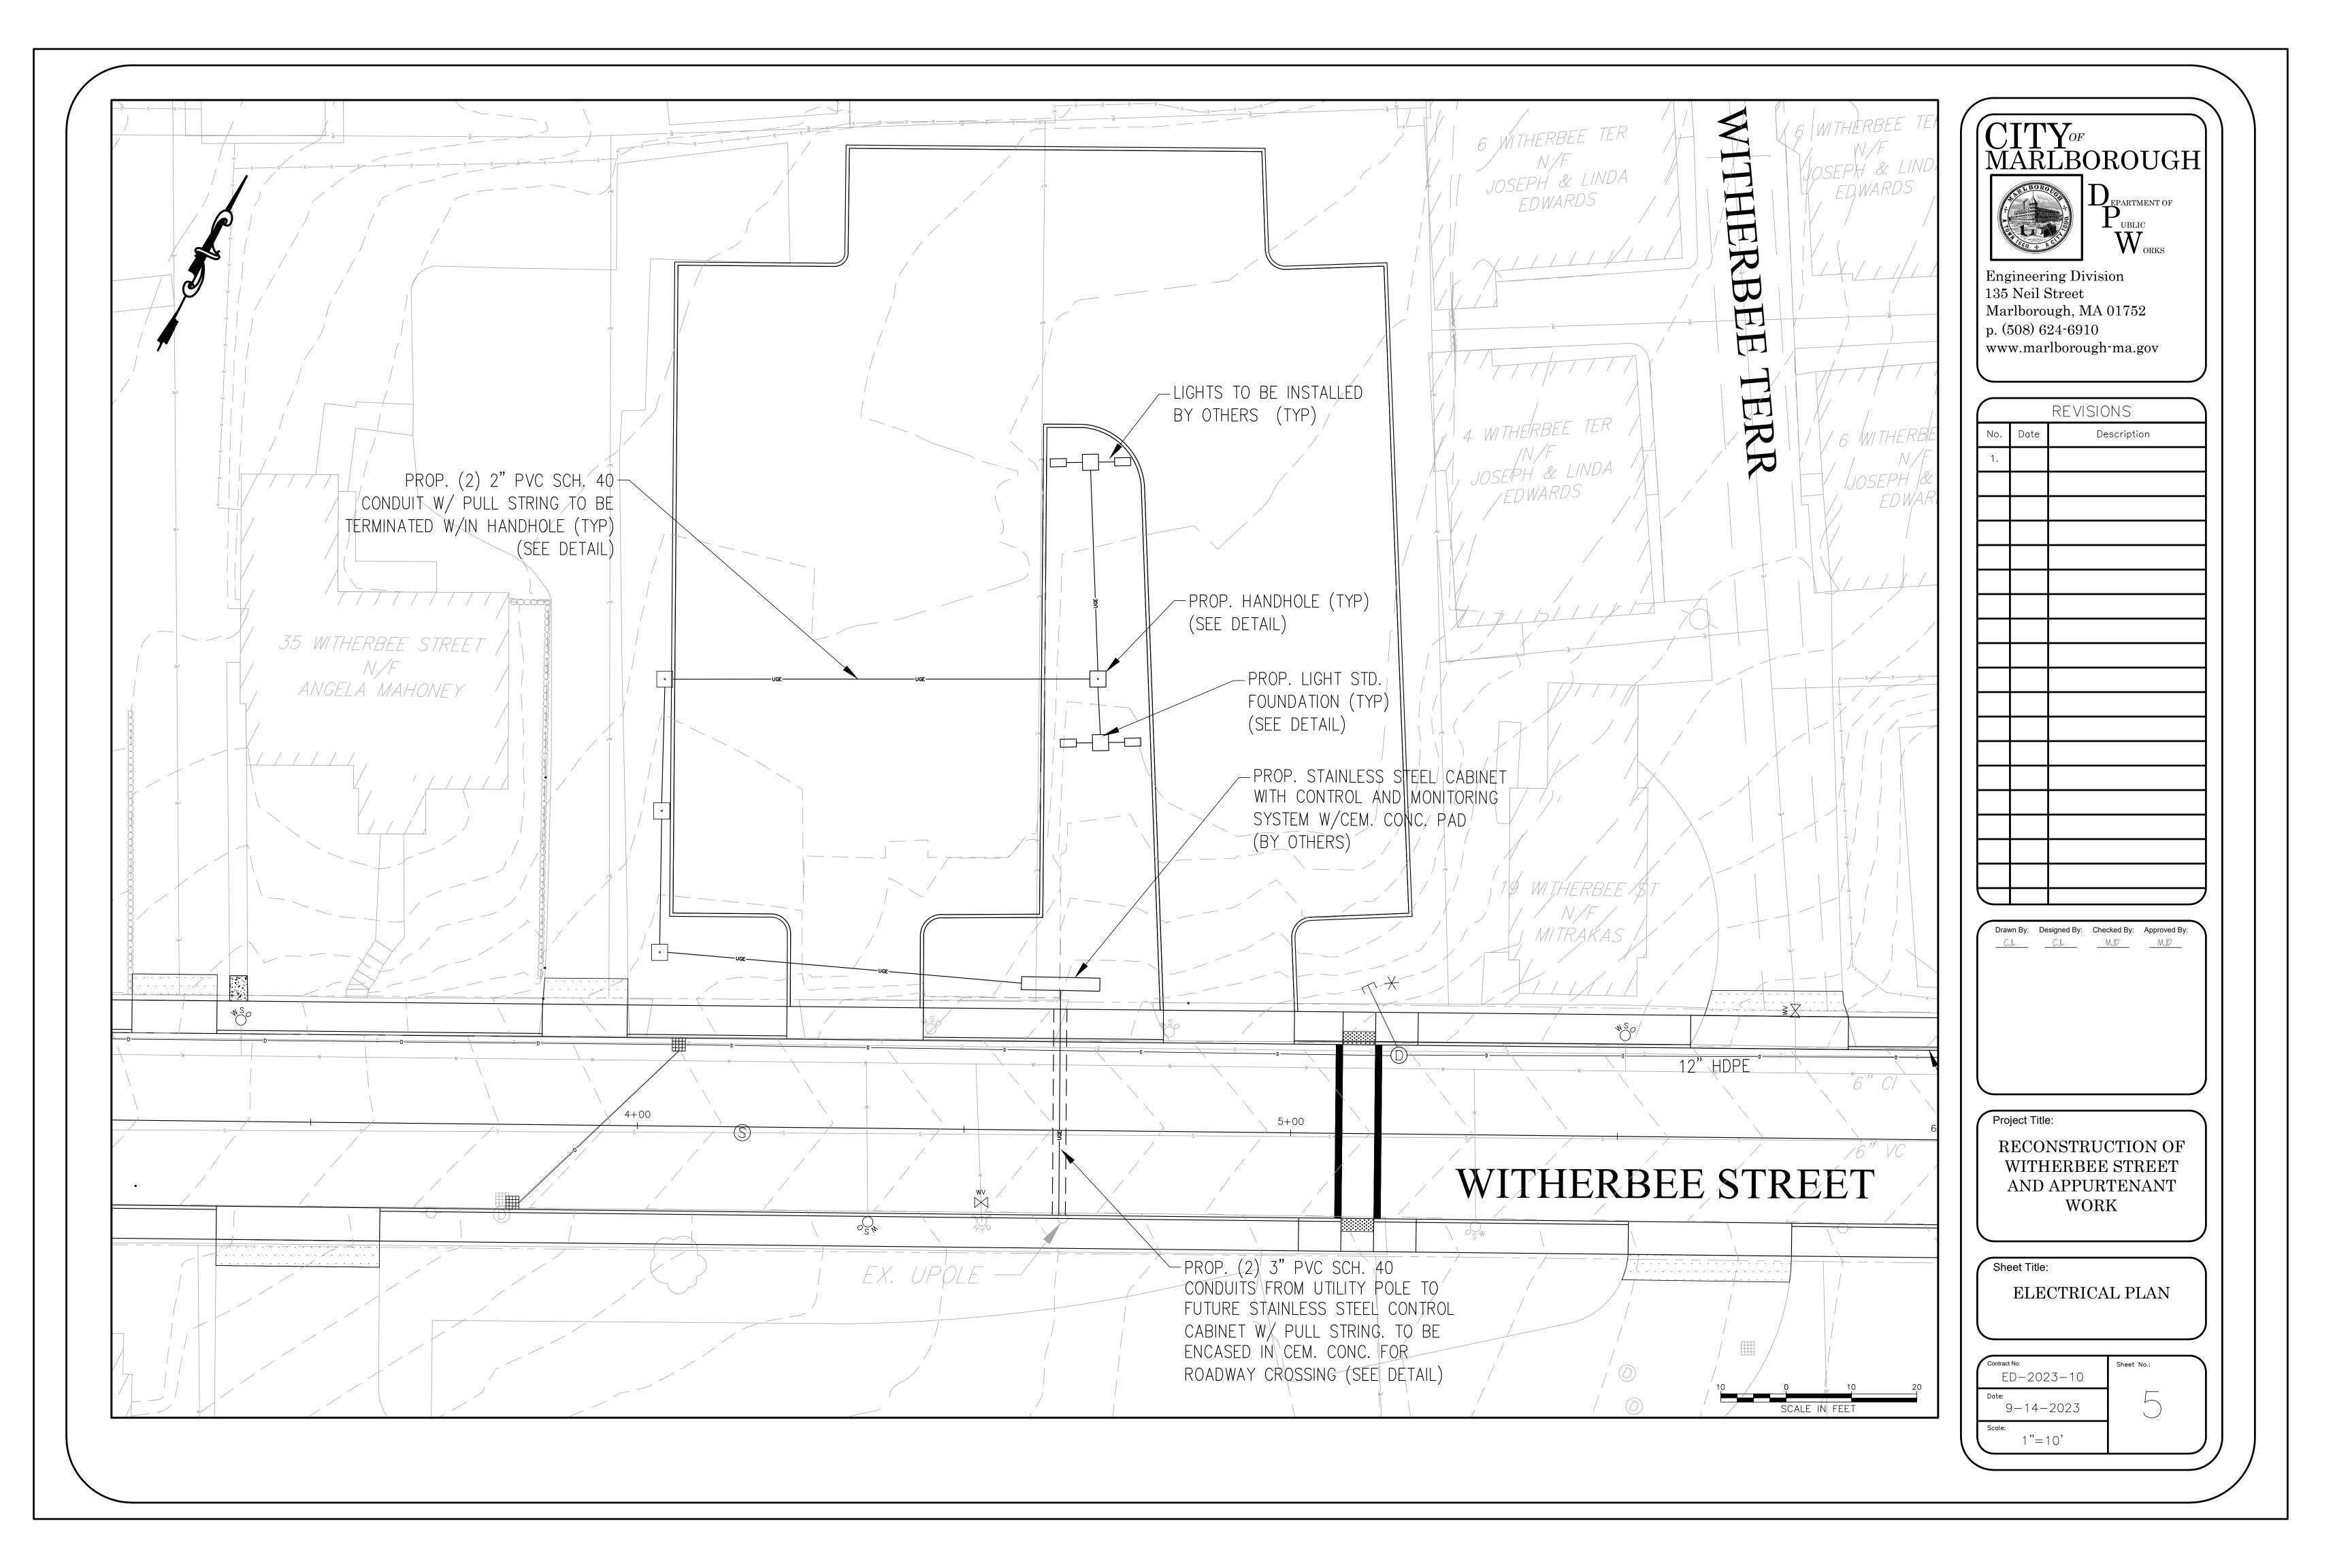
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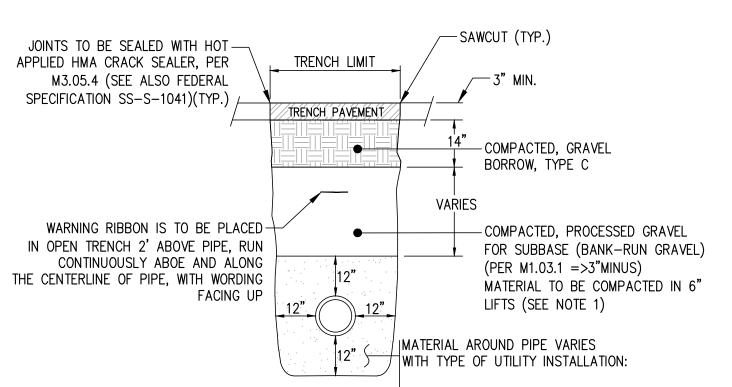
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WITHERBEE STREET CONSTRUCTION PLAN

Contract No: ED-2023-10	Sheet No.:
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Scale: 1"=20'	





|SEWER-3/4" CRUSHED STONE (PER M2.01.0)

DETAIL SHOWN AS TYPICAL

|WATER-SAND BORROW, TYPE B (PER M1.04.0 =>3/8"MINUS)

DRAIN RCP-GRAVEL BORROW, TYPE C (PER M1.03.0 =>2"MINUS)


DRAIN CHDPE-GRAVEL BORROW, TYPE D (PER M1.03.0 =>1-1/2"MINUS

NOTE:

1. COMPACTION EQUIPMENT AND LIFT THICKNESS SHALL MEET OR EXCEED THE MINIMUM REQUIREMENTS TO OBTAIN THE COMPACTION STANDARDS DESCRIBED IN THE CONSTRUCTION NOTES, UNLESS OTHERWISE APPROVED BY THE CITY ENGINEER. IN PROXIMITY TO STRUCTURES, A JUMPING JACK COMPACTOR SHALL BE REQUIRED.

2. WATER MAIN PIPE IS TO HAVE MINIMUM COVER DEPTH OF 5 FEET FROM FINISHED SURFACE.

TYPICAL
EXCAVATION TRENCH
N.T.S.

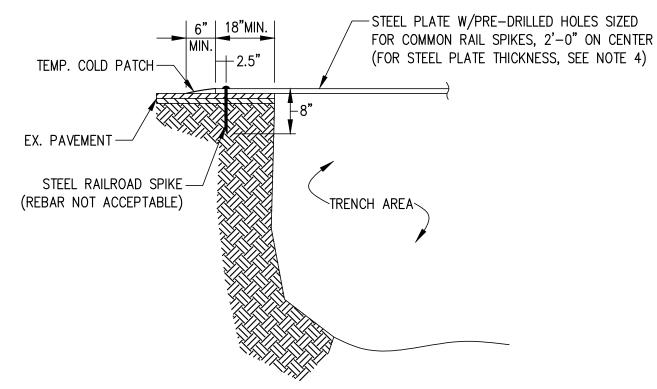

# NOTF:

- 1. THE CITY RESERVES THE RIGHT NOT TO ALLOW THE USE OF STEEL PLATES TO SECURE
- TRENCHES AT ANY TIME THROUGHOUT CONSTRUCTION.

  2. PLACE 48"X48" ORANGE AND BLACK CONSTRUCTION SIGN, STATING "STEEL PLATES 100 FT."
  TO PROVIDE DRIVERS WITH ADVANCED NOTICE. SEE TRAFFIC MANAGEMENT PLAN FOR PLACEMENT OF SIGNAGE.
- 3. NOT MORE THAN ONE (1) STEEL PLATE SHALL BE USED AT ANY TIME AND CAN NOT BE USED
- ON EXCAVATIONS GREATÉR THAN 7-FEET WIDE.
  4. STEEL PLATE DIMENSIONS AND THICKNESS SHALL BE DESIGNED BY THE CONTRACTOR. STEEL
- PLATE THICKNESS SHALL BE DESIGNED TO ALLOW DEFLECTION OF NOT MORE THAN 0.25".

  5. PROVIDE WOOD WEDGES UNDER PLATE EDGES AT UNEVEN SURFACES TO MINIMIZE MOVEMENT.

STEEL PLATE DETAIL N.T.S.

# CONSTRUCTION NOTES

THE FOLLOWING DESCRIBES MATERIALS AND METHODS AS THEY PERTAIN TO ROAD OPENING WORK. ALL WORK SHALL CONFORM TO THE 1988 STANDARD SPECIFICATIONS FOR HIGHWAYS AND BRIDGES, AND ALL SUBSEQUENT SUPPLEMENTAL SPECIFICATIONS THERETO.

#### BACKFILL MATERIALS

EXCAVATIONS IN THE STREET PAVEMENT AREAS SHALL BE CAREFULLY BACKFILLED WITH LAYERS OF SUITABLE GRAVEL. THE TWELVE (12) INCHES OF BEDDING MATERIAL AROUND PIPES SHALL BE SAND (M1.04.0) FOR WATER, 3 CRUSHED STONE (M2.01.0) FOR SEWER, GRAVEL BORROW — TYPE C (M1.03.0) FOR RCP DRAIN & TYPE D (M1.03.0) FOR CHDPE DRAIN OR AS SPECIFIED BY THE OWNER OF THE UTILITY AND APPROVED BY THE CITY OF MARLBOROUGH.

SUITABLE BANK-RUN GRAVEL MATERIAL FOR BACKFILLING SHALL BE GRANULAR FILL CONSISTING OF MINERAL SOIL SUBSTANTIALLY FREE FROM CLAY, ORGANIC MATERIALS, LOAM, WOOD, TRASH OR OTHER OBJECTIONABLE MATERIAL WHICH MAY NOT BE COMPRESSIBLE OR WHICH CANNOT BE PROPERTY COMPACTED. IT SHALL NOT CONTAIN STONES, BROKEN CONCRETE, MASONRY RUBBLE OR OTHER SIMILAR MATERIALS. IT SHALL HAVE PHYSICAL PROPERTIES SUCH THAT IT CAN BE READILY SPREAD AND COMPACTED. IT SHALL NOT CONTAIN ANY SNOW, ICE OR FROZEN SOIL.

BACKFILL MATERIAL SHALL CONSIST OF CONTROLLED DENSITY FILL (CDF) — TYPE 1E OR 2E (M4.08.0) FOR ALL MAJOR ROADWAYS OF THE CITY OR AS DIRECTED BY THE COMMISSIONER OF PUBLIC WORKS. WHERE REQUIRED, CDF SHALL BE PLACED TO WITHIN A MINIMUM OF 5" FROM THE TOP OF THE EXISTING PAVEMENT OR AS DIRECTED BY THE CITY'S INSPECTOR. CDF SHALL BY TYPE 1E VERY FLOWABLE (EXCAVATABLE) OR TYPE 2E FLOWABLE (EXCAVATABLE) WITH A MAXIMUM STRENGTH OF 200 PSI AND 25-30% AIR. CDF (TYPE 1E AND 2E) SHALL BE EXCAVATABLE USING SIMPLE HAND TOOLS WHERE REQUIRED.

IF CONTROL DENSITY FILL IS USED TO BACKFILL THE TRENCH, PERMANENT TRENCH PAVING CAN BE PERFORMED ONCE THE CONTROL DENSITY FILL HAS SET, ELIMINATING THE TEMPORARY TRENCH PAVING REQUIREMENT. PROOF OF CONTROL DENSITY FILL SHALL BE REQUIRED IN ORDER TO BE GRANTED RELIEF FROM PERMANENT TRENCH PAVING. PLEASE NOTE, SHOULD THE TRENCH SHOW ANY SIGNS OF FAILURE, THE CONTRACTOR SHALL EXCAVATE THE HOT MIX ASPHALT IN QUESTION AND PERFORM TRENCH PAVING MEETING THE CITY OF MARLBOROUGH'S SPECIFICATIONS.

#### COMPACTION OF BACKFILL

BACKFILL SHALL BE UNIFORMLY DISTRIBUTED IN SUCCESSIVE LAYERS, EACH LAYER BEING THOROUGHLY COMPACTED BEFORE THE SUCCEEDING LAYER IS PLACED. THE ENTIRE WIDTH OF THE TRENCH SHALL BACKFILLED AND MECHANICALLY TAMPED IN LIFT DEPTHS NOT GREATER THAN (6) INCHES. COMPACTION EQUIPMENT AND LIFT THICKNESS SHALL MEET OR EXCEED THE MINIMUM REQUIREMENTS TO OBTAIN THE COMPACTION STANDARDS UNLESS OTHERWISE APPROVED BY THE CITY ENGINEER. THE TOP LAYER OF BACKFILL SHALL BE FOURTEEN (14) INCHES OF GRAVEL COMPACTED TO 97% OF MAXIMUM DENSITY.

#### GRADING ROLLING AND FINISHING

PAVEMENT PLACED SHALL BE PLACED AND RAKED TO A UNIFORM SURFACE, ROLLED TO THE REQUIRED THICKNESS AND TO A GRADE THAT WILL MATCH THE EXISTING BITUMINOUS ROAD SURFACE. THE PERMITTEE SHALL MAINTAIN THE SURFACING AND SHALL PROMPTLY FILL WITH SIMILAR MATERIAL ANY DEPRESSION AND HOLES THAT MAY OCCUR SO AS TO KEEP THE SURFACING IN A SAFE AND SATISFACTORY CONDITION FOR TRAFFIC.

#### TEMPORARY PAVEMENT

A TEMPORARY PAVEMENT SHALL BE PLACED ON THE SURFACE OF THE FILL AND THOROUGHLY COMPACTED. A TEMPORARY PAVEMENT SHALL BE HOT MIX ASPHALT NO LESS THAN THE EXISTING BASE COURSE OR A MINIMUM THREE (3) INCHES THICK (SEE EXCAVATION TRENCH DETAIL). IF PLATES ARE USED PRIOR TO TEMPORARY PAVING, THEY SHALL BE RAMPED TO MATCH THE EXISTING PAVEMENT. TEMPORARY PAVING OR STEEL PLATING SHALL IMMEDIATELY FOLLOW THE BACKFILLING OPERATION OR AS DIRECTED BY ENGINEER.


#### PERMANENT PAVING

THE FINAL HOT MIX ASPHALT SURFACE SHALL NOT BE PLACED ANY EARLIER THAN 65 DAYS OR NO LATER THAN 90 DAYS FROM THE DATE OF COMPLETION OF THE TEMPORARY SURFACE WITHOUT APPROVAL FROM THE COMMISSIONER OF PUBLIC WORKS. THE TEMPORARY PAVEMENT SHALL BE MILLED TO A DEPTH OF ONE AND ONE—HALF (1 ½) INCHES, TWELVE (12) INCHES OUTSIDE OF THE TEMPORARY PAVING LIMITS. PAVEMENT LIMITS JOINTS ARE TO BE SEALED WITH HOT APPLIED HMA CRACK SEALER, PER M3.05.4. IN SOME INSTANCES, FOR PROJECTS BEYOND A SIMPLE TRENCH EXCAVATION ADDITIONAL PAVEMENT DETAILS AND RESURFACING REQUIREMENTS MAY BE INCLUDED AS A SPECIAL CONDITION IN THE PERMIT.

#### PROTECTIVE SYSTEMS

COLOR NO. 33538

ALL EXCAVATIONS MUST BE PROPERLY SLOPED, SHORED, OR SHIELDED UNLESS THEY ARE MADE ENTIRELY IN STABLE ROCK, OR LESS THAN (5) FEET DEEP AND DECLARED SAFE AFTER AN INSPECTION BY A COMPETENT PERSON.

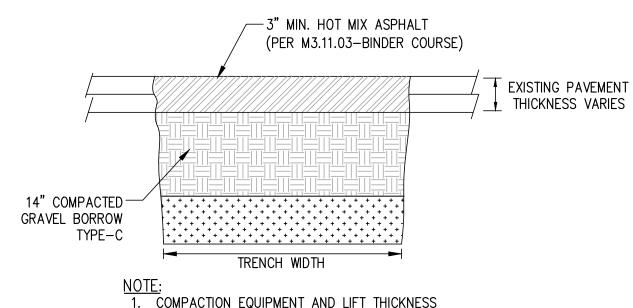

1. COMPACTION EQUIPMENT AND LIFT THICKNESS SHALL MEET OR EXCEED THE MINIMUM REQUIREMENTS TO OBTAIN THE COMPACTION STANDARDS DESCRIBED IN THE CONSTRUCTION NOTES, UNLESS OTHERWISE APPROVED BY THE CITY ENGINEER. IN PROXIMITY TO STRUCTURES, A JUMPING JACK COMPACTOR SHALL BE REQUIRED.


TEMPORARY TRENCH PAVING
TYPICAL SECTION

N.T.S.

SIDEWALK-5' EXIST. BUILDING GRANITE CURB. 6"x6" W.W.F. (1.4x1.4) TYPE VA4 (TYP.) 2% MAX.─<del>-</del> EXIST. GROUND **→** 1/4"/FT 6" MIN.-PROP. SIDEWALK TO MEET EXIST. BUILDING FOUNDATION, STEP OR 6" MIN. → EXIST. GROUND - 4" CEM. CONC. SIDEWALK 3000 PSI CONCRETE AS DIRECTED. NOTE: CONSTRUCTION JOINTS ARE TO BE AT 6' INTERVALS.

CEMENT CONCRETE SIDEWALK DETAIL

N.T.S.

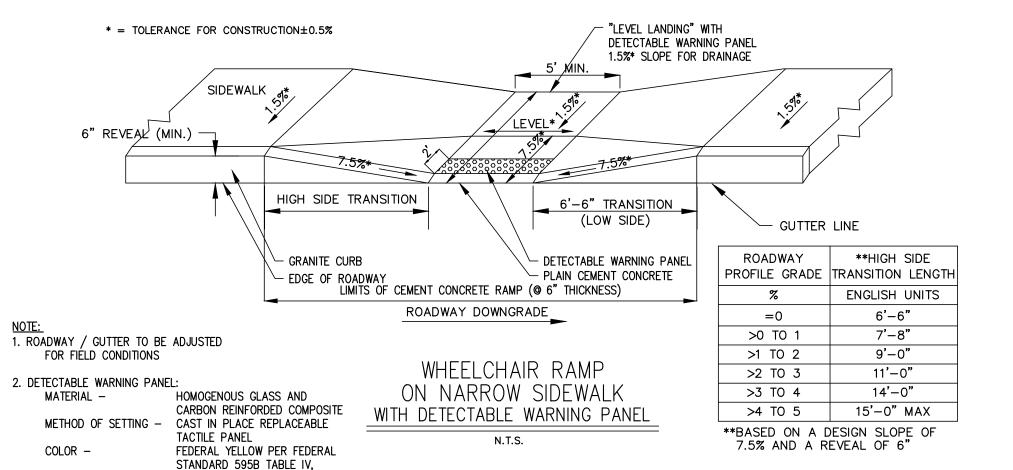





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		REVISIONS
No.	Date	Description


Drawn By:	Designed By:	Checked By:	Approved By
<u>CJL</u>	<u> </u>	MJD	110


Project Title:

RECONSTRUCTION OF WITHERBEE STREET AND APPURTENANT WORK

Sheet Title:
TYPICAL DETAILS

Contract No: ED — 2023 — 10	Sheet No.:
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Scale: NTS	

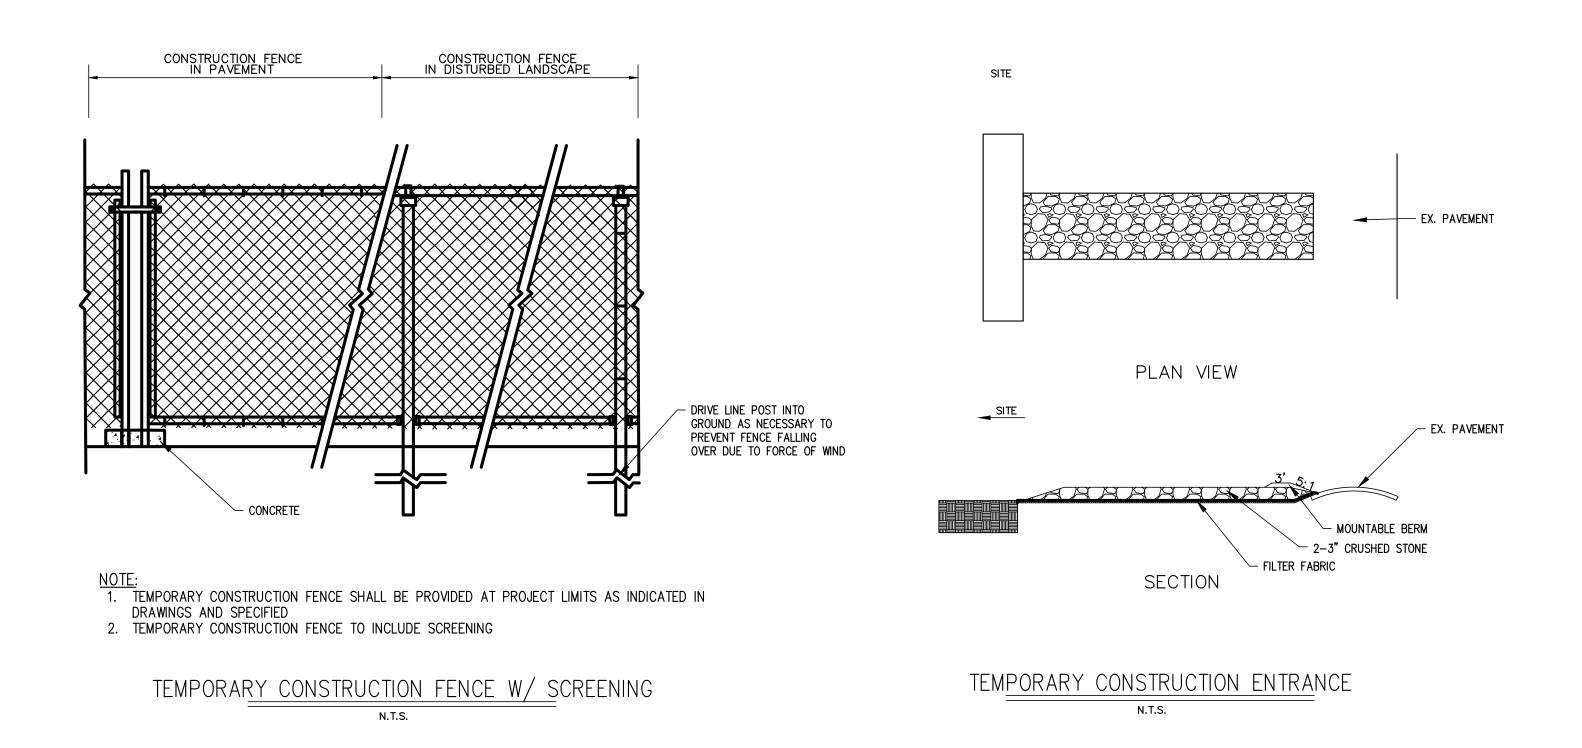

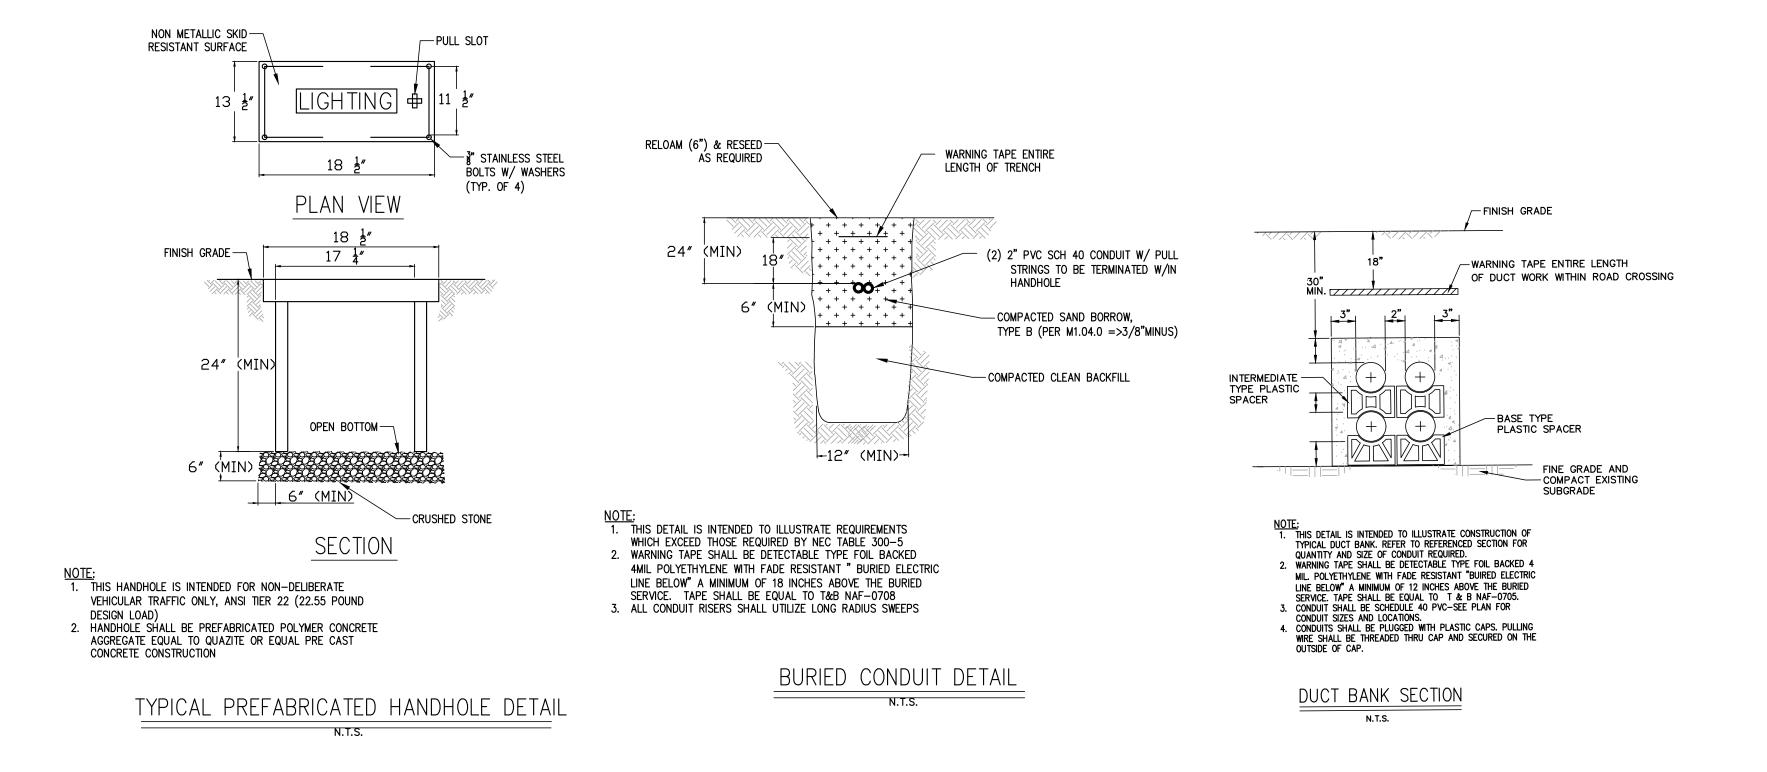

# CITY<sup>OF</sup> MARLBOROUGH



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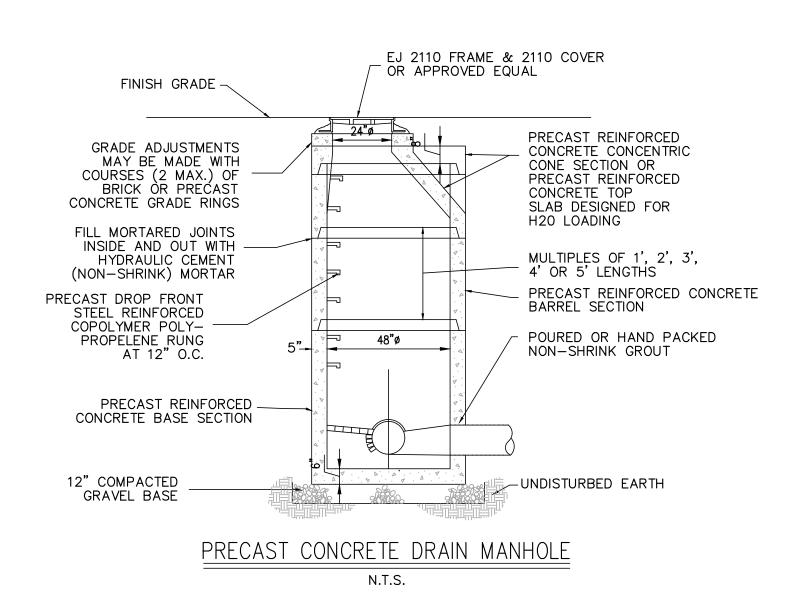
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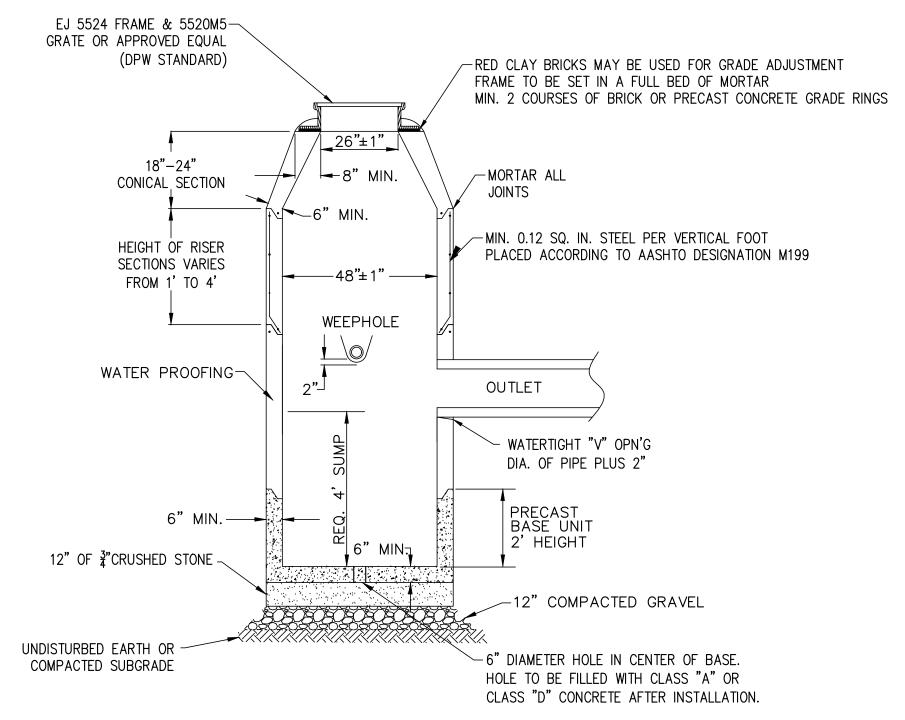
Project Title:

RECONSTRUCTION OF WITHERBEE STREET AND APPURTENANT WORK

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TYPICAL DETAILS


Contract No: ED-2023-10	Sheet No.:
Date: 9-14-2023	
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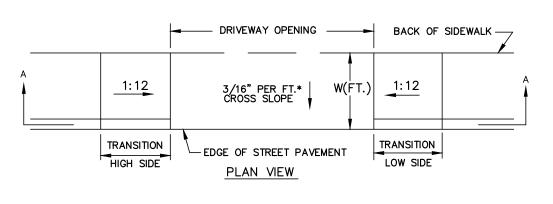





PRECAST CONCRETE CATCH BASIN DETAIL

NOTE:
ALL CONCRETE STRUCTURES SHALL BE CAPABLE OF WITHSTANDING H20 LOADING



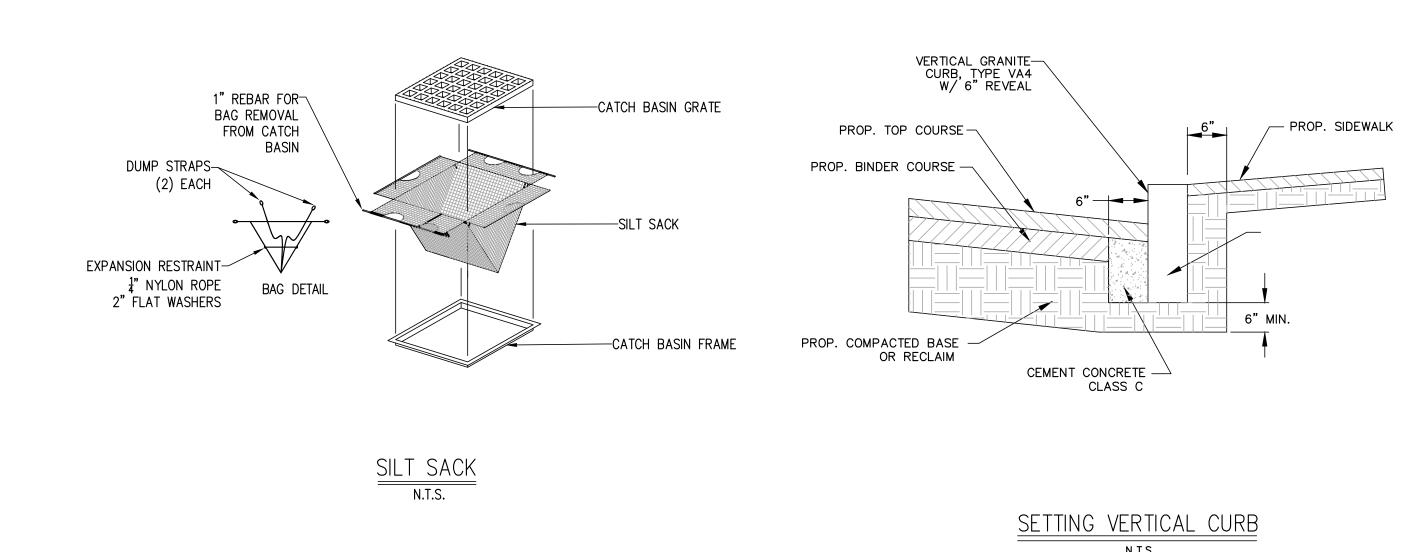

3/16" PER FOOT EQUALS A SLOPE OF 1.5625% MAXIMUM SLOPE PER A.D.A. REGULATION IS 2.0% (A.D.A. – AMERICANS WITH DISABILITIES ACT)

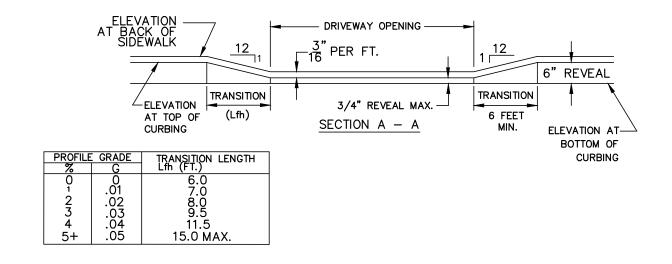

DRIVEWAY REQ. HMA S.W N.T.S.





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	REVISIONS		
No.	Date	Description	

<u>CJL</u>	<u> </u>	_MJD	110

Drawn By: Designed By: Checked By: Approved By:

Project Title:


RECONSTRUCTION OF WITHERBEE STREET AND APPURTENANT WORK

Sheet Title:
TYPICAL DETAILS

Contract No: ED — 2023 — 10	Sheet No:
Date: 9-14-2023	8
Scale: N.T.S.	


# <u>CONSTRUCTION SIGN LEGEND</u>

IDENTIFICATION	SIZE	□F SIGN		TEXT DIMENSIONS	COLOR	UNIT AREA IN
NUMBER	WIDTH	HEIGHT	TEXT	LETTER VERTICAL ARROW HEIGHT SPACING	BACK- GROUND LEGEND BORDER	0011455
W20-1D	48″	48″	STEEL PLATES 100 FT	MUTCD STANDARD DETAIL	MUTCD STANDARD DETAIL	16.0
W20-1A	48″	48″	ROAD WORK AHEAD		•	16.0
W20-1B	48 <i>"</i>	48″	ROAD WORK 1000 FT			16.0
W20-1C	48 <i>"</i>	48″	ROAD WORK 500 FT			16.0
W20-4	48 <i>"</i>	48″	ONE LANE ROAD AHEAD			16.0
W20-7b	48″	48″	BE_PREPARED TO STOP			16.0
W20-8	48 <i>"</i>	48″	POLICE OFFICER AHEAD			16.0
G20-2	36 <i>"</i>	18″	END ROAD WORK			4.5
R11-2	48 <i>"</i>	30″	ROAD CLOSED			10.0
W5−1	48 <i>"</i>	48″	ROAD NARROWS			16.0
W1-4L	30″	30″				6.25
W1-4R	30 <i>*</i>	30″				6.25
M4-8A	24 <i>"</i>	18″	END DETOUR			3.0
M4-9L	30″	24″	DETOUR			5.0
M4-9R	30″	24″	DETOUR			5.0
M4-9∨	30″	24″	DETOUR			5.0
W20-2	48″	48″	DETOUR AHEAD			16.0

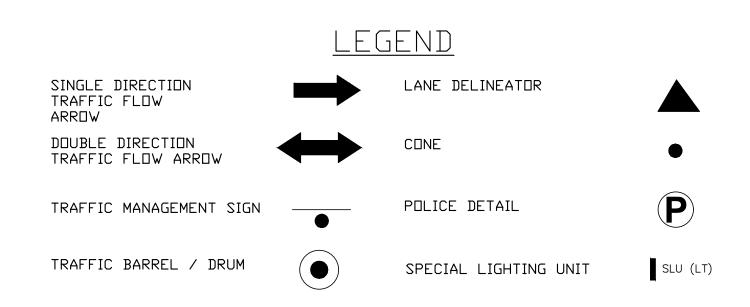

PROPOSED WORK AREA

CHANGEABLE MESSAGE SIGN

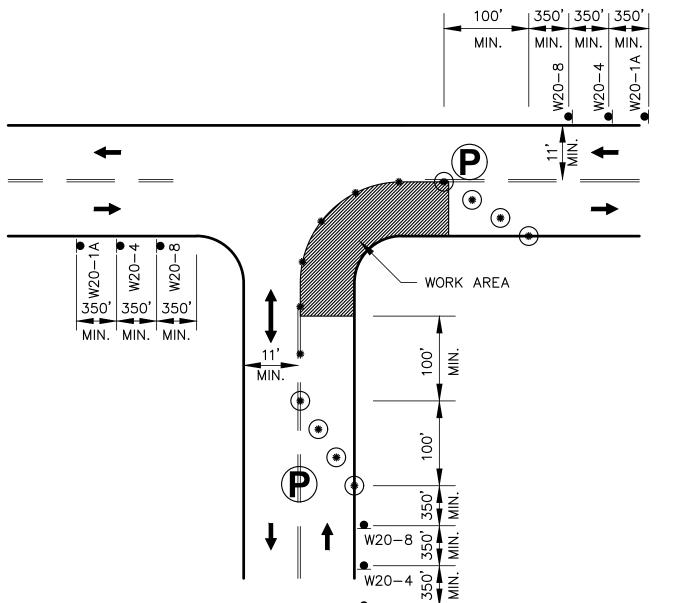

NOTE:

1. ADVANCE WARNING SIGN PLACEMENT TO BE ADJUSTED AS NECESSARY.


2. ALL DRUMS AND CONES TO BE SPACED

@ 20' O.C.

W20-1A

ONE LANE BI-DIRECTIONAL TRAFFIC AT INTERSECTIONS

N.T.S.

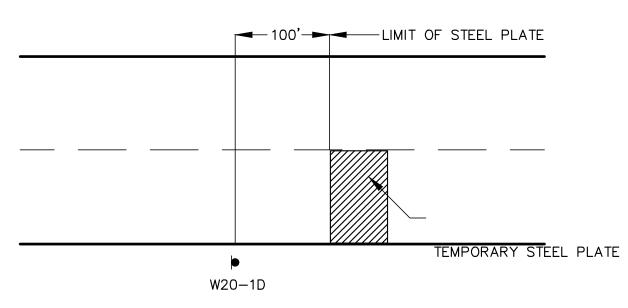

TRENCH PLATE SIGNING

N.T.S.

# GENERAL NOTES

1. ALL CONSTRUCTION SIGNING, DRUMS, BARRICADES AND OTHER DEVICES SHALL CONFORM WITH THE LATEST EDITION OF THE MANUAL ON UNIFORM TRAFFIC CONTROL DEVICES (MUTCD) AS AMENDED.

2. ALL DRUMS SHALL BE APPROXIMATELY PLACED AND MOVED AS NECESSARY TO MAINTAIN ADEQUATE ABUTTER ACCESS AT ALL TIMES. WORK MAY REQUIRE ADDITIONAL SIGNS, DRUMS AND OTHER TRAFFIC CONTROL DEVICES, GRADING AND TEMPORARY PAVEMENT FOR PASSAGE OF PEDESTRIAN, VEHICULAR AND EMERGENCY TRAFFIC THROUGH THE WORK AREAS, BOTH DURING AND AFTER WORKING HOURS, TO MAINTAIN SUCH ACCESS.

3. THE CONTRACTOR SHALL NOTIFY EACH ABUTTER AT LEAST 24 HOURS IN ADVANCE OF THE START OF ANY WORK THAT WILL REQUIRE THE TEMPORARY CLOSURE OF ACCESS, SUCH AS EXISTING PAVEMENT EXCAVATION, TEMPORARY DRIVEWAY PAVEMENT PLACEMENT AND SIMILAR OPERATIONS.

4. DURING WORK IN INTERSECTIONS A MINIMUM OF ONE LANE OF ALTERNATING TRAFFIC SHALL BE ALLOWED TO PASS AT ALL TIMES. (POLICE DETAILS SHALL BE PRESENT DURING THIS WORK.)

5. GRADE SEPARATIONS IN EXCESS OF 2" DURING NON-WORKING HOURS WILL REQUIRE DELINEATION BY USE OF DRUMS.

6. EXCAVATION EDGES IN EXCESS OF 4" DEEP SHALL BE PROTECTED DURING NON-WORKING HOURS BY BACKFILLING WITH A WEDGE OF GRAVEL OR SOIL TO COMPACTED 4:1 SLOPE.

7. 11' MINIMUM TRAVEL LANE WIDTHS SHALL BE MAINTAINED AT ALL TIMES.

8. NON-ESSENTIALS TRAFFIC CONTROL DEVICES SHALL BE COVERED OR REMOVED DURING NON-WORKING HOURS.


9. TRAFFIC MANAGEMENT SHALL INCLUDE CONSIDERATIONS FOR PEDESTRIANS ACCESS AT ALL TIMES.

10, NO SIGNAGE SHALL BE INSTALLED ON UTILITY POLES OR OTHER PRIVATE PROPERTY UNLESS CONTRACTOR RECEIVES WRITTEN PERMISSION FROM OWNER AND PROVIDES A COPY OF SAID AGREEMENT TO THE ENGINEER.

11. SPECIFIC SIGNAGE SHALL BE USED WHEN TEMPORARY TRENCH PLATES ARE INSTALLED. (SEE DETAIL ON THIS SHEET).

12. TRAFFIC MANAGEMENT PLAN REPRESENTS MINIMUM REQUIREMENTS, CONTRACTOR TO BE SOLELY RESPONSIBLE FOR TRAFFIC MANAGEMENT AND SAFETY IN WORK ZONE AREAS. DETOUR SHALL ONLY BE ESTABLISHED AND/OR ALTERED BY WITH THE APPROVAL OF THE ENGINEER.


13. THE CONTRACTOR IS RESPONSIBLE FOR NOTIFYING THE RESPECTIVE PUBLIC SERVICE CORPORATIONS OR OFFICIALS OF THEIR INTENTIONS AT LEAST ONE WEEK IN ADVANCE OF THE COMMENCEMENT OF OPERATIONS. THE CONTRACTOR MAY HAVE TO COORDINATE ON A DAILY BASIS IF THE DETOUR OR WORK ZONES HAVE CHANGED. FOR A LIST OF SAID CORPORATIONS PLEASE SEE THE CONTRACT DOCUMENTS "GENERAL CONDITIONS".

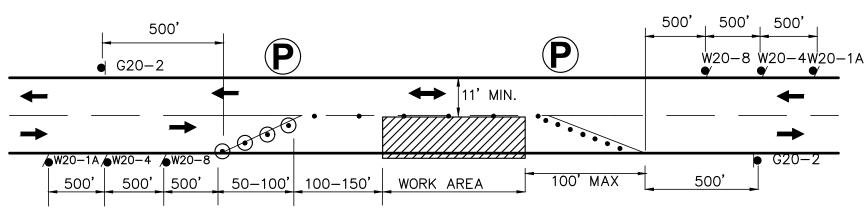

TYPICAL TWO WAY ALTERNATING TRAFFIC

N.T.S.

NOTE: THIS DETAIL SHOWS A RIGHT LANE CLOSURE DETAIL. THIS DETAIL CAN ALSO BE USED FOR LEFT LANE CLOSURES, WITH THE SIGN PLACEMENT REVERSED AS APPROPRIATE.

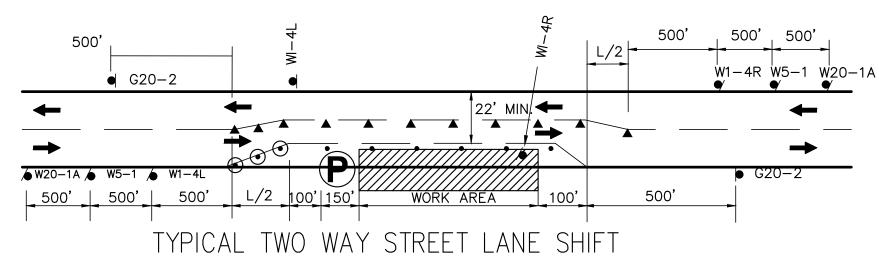

YPICAL TWO WAY STREET LANE SHIFT

NOTE: THIS DETAIL SHOWS A RIGHT LANE CLOSURE DETAIL.

THIS DETAIL CAN ALSO BE USED FOR LEFT LANE CLOSURES,
WITH THE SIGN PLACEMENT REVERSED AS APPROPRIATE.

L=WS²/60 (FEET) FOR 40 MPH OR LESS W=WIDTH OF OFFSET (FT)
L=WS FOR 45 MPH OR MORE S= POSTED SPEED LIMIT (MPH)

OPERATIONAL SIGNING
N.T.S.

ALL DRUMS AND SIGNS ARE SHOWN AS THEY SHOULD APPEAR DURING THE WORKING DAY, OR WHILE OPERATING IN THE WORK ZONE.

# CITY<sub>OF</sub> MARLBOROUGH



Public Works

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# REVISIONS

No.	Date	Description

Project Title:

RECONSTRUCTION OF WITHERBEE STREET AND APPURTENANT WORK

Sheet Title:
TRAFFIC
MANAGEMENT PLAN

Contract No: ED-2023-10	Sheet No.:
Date: 9-14-2023	12
Scale: N.T.S.	

# ALL DIMENSIONS ARE TO FACE OF CURB AT GUTTER LINE. OTHERWISE NOTED. DEMOLISHED AS REQUIRED. -BITUMINOUS-CONCRETE PAVEMENT SITE LIGHTING TYP. BITUMINOUS ----CONCRETE-PAVEMENT 6' HT. CEDAR STOCKADE— FENCE TYP. (VARIES), EV CHARGING STATION — LAYOUT TYP. REFER TO ELECTRICAL PLAN FOR EV - CURB CUT (TYP) REFER TO CITY SIDEWALK DRAWING FOR SIDEWALK, ROW, CROSSWALK AND CURB EXIT (FACING ILOT) ---DO NOT ENTER (FACING STREET) DO NOT ENTER (FACING LO<del>T) |</del> ENTER (FACING STREET) 3+00 4+00 6+00 WITHERBEE STREET

# LAYOUT AND MATERIAL NOTES

- 1. EXISTING CONDITIONS INFORMATION IS REPRODUCED FROM THE SURVEY PREPARED BY CITY OF MARLBOROUGH DPW.
- 2. THE LOCATIONS OF UNDERGROUND UTILITIES SHOWN ARE BASED ON THE SURVEY REFERENCED ABOVE. THE CONTRACTOR SHALL NOTIFY DIGSAFE AND THE PROPER LOCAL AUTHORITIES OR RESPECTIVE UTILITY COMPANIES TO CONFIRM THE LOCATION OF ALL EXISTING UTILITIES BEFORE COMMENCING WORK. ANY DAMAGE DUE TO FAILURE OF THE CONTRACTOR TO CONTACT THE PROPER AUTHORITIES SHALL BE BORNE BY THE CONTRACTOR.
- 3. CONTRACTOR(s) SHALL THOROUGHLY FAMILIARIZE THEMSELVES WITH ALL CONSTRUCTION DOCUMENTS, SPECIFICATIONS, AND SITE CONDITIONS PRIOR TO BIDDING AND PRIOR TO CONSTRUCTION.
- 4. ANY DISCREPANCIES BETWEEN DRAWINGS, SPECIFICATIONS, AND SITE CONDITIONS SHALL BE REPORTED IMMEDIATELY TO THE OWNER'S REPRESENTATIVE FOR CLARIFICATION AND RESOLUTION PRIOR TO BIDDING OR CONSTRUCTION.
- 5. ALL WORK CONDUCTED WITHIN PUBLIC RIGHT-OF-WAYS SHALL CONFORM TO THE REQUIREMENTS AND SPECIFICATIONS OF THE CITY OF MARLBOROUGH, MA. .
- 6. ACCESSIBLE CURB RAMPS SHALL BE PER THE MASSACHUSETTS ARCHITECTURAL ACCESS BOARD (AAB) AND THE AMERICANS WITH DISABILITIES ACT (ADA) ACCESSIBILITY GUIDELINES, WHICHEVER IS MORE STRINGENT.
- 8. THE FOLLOWING LAYOUT CRITERIA SHALL CONTROL UNLESS OTHERWISE NOTED ON THE PLAN:

ALL DIMENSIONS ARE TO CENTER OF PAVEMENT MARKINGS. ALL TIES TO PROPERTY LINES ARE PERPENDICULAR TO THE PROPERTY LINE UNLESS

SCREENED IMAGES SHOW EXISTING CONDITIONS. WHERE EXISTING CONDITIONS LIE UNDER OR ARE IMPINGED UPON BY PROPOSED BUILDINGS AND/OR SITE ELEMENTS, THE EXISTING CONDITION WILL BE REMOVED, ABANDONED AND/OR CAPPED OR




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PROPERTY LINE



SITE LIGHTING

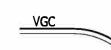

VERTICAL GRANITE CURB

WITHERBEE STREET PARKING LOT

MARLBOROUGH, MA



LAYOUT AND **MATERIALS** PLAN

SCALE:	1"-20"	
JOB:	2GIS-535	
FILE:		
DRAWN:	JJD / CM	
CHECKED	: TOG	
DATE:	08-21-23	


## **GRADING AND UTILITY NOTES**

- MARLBOROUGH DPW.
- PRIOR TO THE START OF ANY EXCAVATION FOR THE PROJECT, BOTH ON AND OFF THE SITE, THE CONTRACTOR SHALL NOTIFY DIGSAFE AND BE PROVIDED WITH A DIGSAFE NUMBER INDICATING THAT ALL EXISTING UTILITIES HAVE BEEN LOCATED AND MARKED.
- CONTRACTOR TO ADJUST UTILITY ELEMENT MEANT TO BE FLUSH WITH GRADE (CLEAN-OUTS, UTILITY SPECIFICALLY NOTED ON PLANS OR NOT.
- ALL CONSTRUCTION TO BE DONE IN ACCORDANCE WITH CITY OF MARLBOROUGH STANDARDS.
- SPECIFICATIONS OF THE CITY OF MARLBOROUGH.
- HAVE NOT BEEN INDEPENDENTLY VERIFIED BY THE OWNER OR ITS REPRESENTATIVE. THE CONTRACTOR SHALL DETERMINE THE EXACT LOCATION OF ALL EXISTING UTILITIES BEFORE COMMENCING WORK, AND AGREES TO BE FULLY RESPONSIBLE FOR ANY AND ALL DAMAGES WHICH MAY BE OCCASIONED BY THE CONTRACTOR'S FAILURE TO EXACTLY LOCATE AND PRESERVE ALL UNDERGROUND UTILITIES.
- WHERE AN EXISTING UTILITY IS FOUND TO CONFLICT WITH THE PROPOSED WORK, THE LOCATION, ELEVATION,
- THE CONTRACTOR SHALL ALTER THE MASONRY OF THE TOP SECTION OF ALL EXISTING DRAINAGE
- GRATES, AND BOXES TO THE PROPOSED FINISH SURFACE GRADE.
- DIRECTED BY OWNER'S REPRESENTATIVE.
- SITE LIGHTING IS SHOWN ON THIS PLAN FOR COORDINATION PURPOSES ONLY. REFER TO ELECTRICAL PLANS FOR EXACT TYPE AND LOCATION.
- AREAS OUTSIDE THE LIMITS OF PROPOSED WORK DISTURBED BY THE CONTRACTOR'S OPERATIONS SHALL BE
- BE INSTALLED ACCORDING TO THE REQUIREMENTS PROVIDED BY, AND APPROVED BY, THE RESPECTIVE UTILITY COMPANY (GAS, TELEPHONE, ELECTRICAL.). THE CONTRACTOR SHALL COORDINATE THE
- CONSTRUCTION.
- PROTECT AND MAINTAIN EXISTING ON-SITE DRAINAGE STRUCTURES AND PIPES UNLESS OTHERWISE NOTED. WHERE PROPOSED GRADES MEET EXISTING GRADES, CONTRACTOR SHALL BLEND GRADES TO PROVIDE A SMOOTH TRANSITION BETWEEN EXISTING AND NEW WORK. PONDING AT TRANSITION AREAS WILL NOT BE
- CONTRACTOR SHALL MAINTAIN POSITIVE DRAINAGE AWAY FROM ALL BUILDING FOUNDATIONS, STRUCTURES
- MAXIMUM SLOPE IN DISTURBED AREAS SHALL NOT EXCEED 3:1, UNLESS OTHERWISE NOTED.
- CONTRACTOR SHALL VERIFY EXISTING GRADES AND NOTIFY OWNER'S REPRESENTATIVE OF ANY
- SCREENED IMAGES SHOW EXISTING CONDITIONS. WHERE EXISTING CONDITIONS LIE UNDER OR ARE REMOVED, ABANDONED AND/OR CAPPED OR DEMOLISHED AS REQUIRED.

# EXISTING CONDITIONS INFORMATION IS REPRODUCED FROM THE SURVEY PREPARED BY THE CITY OF

- MANHOLES, CATCH BASINS, INLETS, ETC.) THAT IS AFFECTED BY SITE WORK OR GRADE CHANGES, WHETHER
- ALL WORK TO BE DONE WITHIN PUBLIC RIGHT-OF-WAYS SHALL CONFORM TO THE REQUIREMENTS AND
- THE LOCATIONS OF EXISTING UNDERGROUND UTILITIES ARE SHOWN IN AN APPROXIMATE WAY ONLY AND
- AND SIZE OF THE UTILITY SHALL BE ACCURATELY DETERMINED WITHOUT DELAY BY THE CONTRACTOR, AND THE INFORMATION FURNISHED TO THE ENGINEER FOR RESOLUTION OF THE CONFLICT.
- STRUCTURES AS NECESSARY FOR CHANGES IN GRADE, AND RESET ALL WATER AND DRAINAGE FRAMES,
- THE CONTRACTOR SHALL MAKE ALL ARRANGEMENTS FOR THE ALTERATION AND ADJUSTMENT OF ALL GAS, ELECTRIC, TELEPHONE, AND ANY OTHER PRIVATE UTILITIES BY THE UTILITY COMPANIES.
- CONTRACTOR SHALL MAINTAIN, OR ADJUST TO NEW FINISH GRADE, AS NECESSARY ALL UTILITY AND SITE STRUCTURES SUCH AS: LIGHT POLES, SIGN POLES, MANHOLES, CATCH BASINS, HAND HOLES, WATER AND GAS GATES, HYDRANTS, ETC., FROM MAINTAINED UTILITY AND SITE SYSTEMS, UNLESS OTHERWISE NOTED OR
- REFER TO ELECTRICAL PLANS FOR SECTIONS AND DETAILS OF THE UTILITY DUCT BANK.
- RESTORED BY THE CONTRACTOR TO THEIR ORIGINAL CONDITION, AT THE CONTRACTOR'S EXPENSE.
- THE LOCATION, SIZE, DEPTH, AND SPECIFICATIONS FOR CONSTRUCTION OF PRIVATE UTILITY SERVICES SHALL
  - INSTALLATION OF THE UTILITY CONNECTIONS WITH THE RESPECTIVE COMPANIES PRIOR TO ANY UTILITY
- ALLOWED.
- ENSURE ALL EXISTING (TO REMAIN), AND PROPOSED MANHOLE COVERS PROPERLY IDENTIFY UTILITY
- BITUMINOUS CONCRETE ELEVATIONS AT CATCH BASINS TO BE 1/4 INCH ABOVE RIM ELEVATION SHOWN FOR
- IMPINGED UPON BY PROPOSED BUILDINGS AND/OR SITE ELEMENTS, THE EXISTING CONDITION WILL BE

# WITHERBEE STREET PARKING LOT

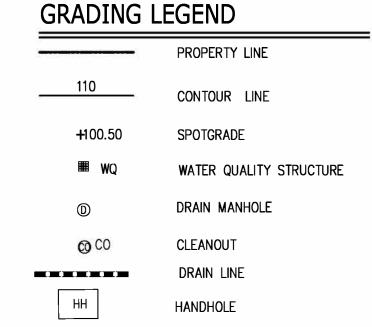

ELECTRICAL CONDUIT

R=445.0

= 441.9

(2) 3" CONDUITS

NEW UTILITY POLE

 $\perp$  INV/FROM SYSTEM = 444.8

 $\rightarrow$  INV AT CONNECTION = 441.8

- INFILTRATION AREA 2

INV. IN 435.00'

TOP OF 6"INCH STONE LAYER =444.8

BOTTOM OF 12" STONE LAYER = 442.3

TOPR OF 6"INCH#STONE LAYER =441.8

INVERT OF 12" PERFORATED PIPE = 440.3 BOTTOM OF 12" STONE LAYER = 439.3

WITHERBEE STREET

INVERT OF 12" PERFORATED PIPE = 443.3

INV FROM SYSTEM 2 = 440.3 (OUTLET UP FROM INFILTRATION)

6+00

ELECTRICAL INFORMATION SHOWN

HANDHOLE TYP, /-

ELECTRICAL CONDUIT-

PROP./CB #4 -

WQL1 R=448.0

44.9


►SMH #2

SCHEMATICALLY

3+00


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MARLBOROUGH, MA

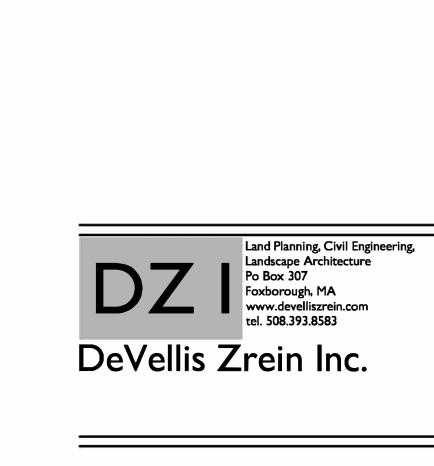

**GRADING AND** UTILITY **PLAN** 

SCALE:	1"-20"	
JOB:	2GIS-535	
FILE:		
DRAWN:	JJD / CM	
CHECKED	: TOG	
DATE:	08-21-23	

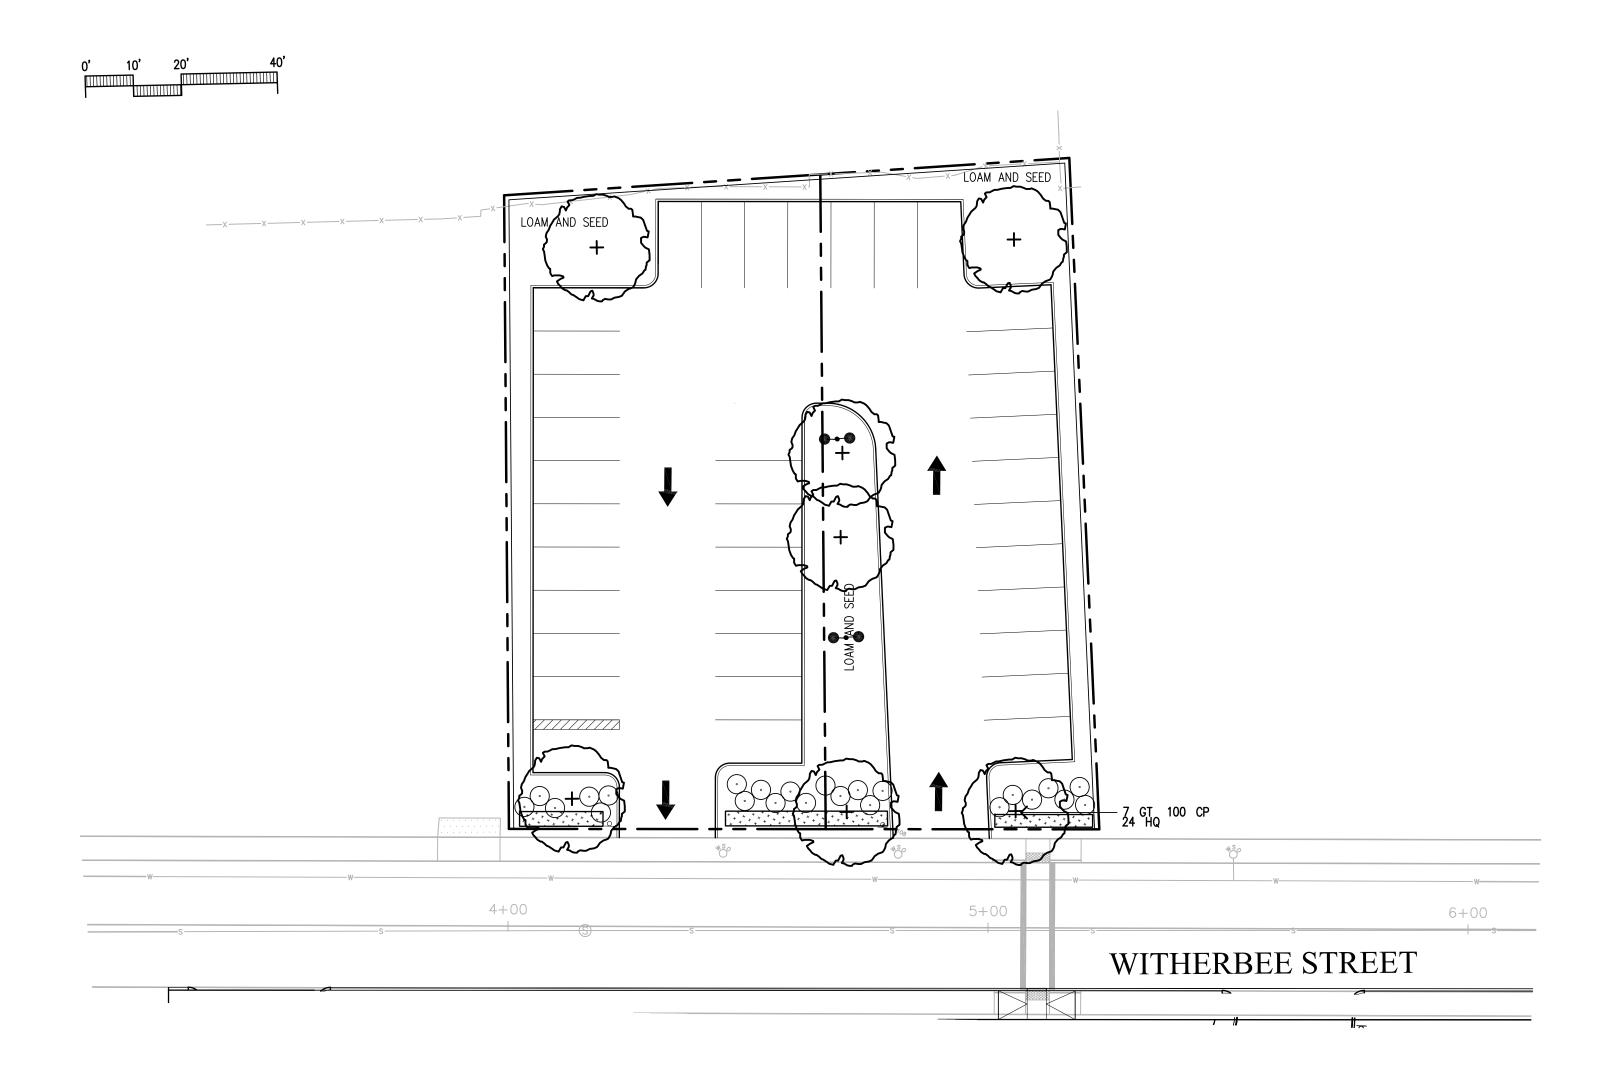

# PLANTING NOTES

- 1. EXISTING CONDITIONS INFORMATION IS REPRODUCED FROM THE SURVEY PREPARED BY THE CITY OF MARLBOROUHGH DPW, MA,
- 2. THE LOCATIONS OF UNDERGROUND UTILITIES SHOWN ARE BASED ON THE SURVEY REFERENCED ABOVE. THE CONTRACTOR SHALL CONTACT DIGSAFE AND THE PROPER LOCAL AUTHORITIES OR RESPECTIVE UTILITY COMPANIES TO CONFIRM THE LOCATION OF ALL EXISTING UTILITIES BEFORE COMMENCING WORK. ANY DAMAGE DUE TO FAILURE OF THE CONTRACTOR TO CONTACT THE PROPER AUTHORITIES SHALL BE BORNE BY THE CONTRACTOR.
- 3. CONTRACTOR SHALL BEGIN MAINTENANCE IMMEDIATELY AFTER PLANTING AND WILL CONTINUE UNTIL FINAL WRITTEN ACCEPTANCE OF PLANT MATERIAL.
- 4. LANDSCAPE ARCHITECT TO FLAG ALL TREES TO BE TRANSPLANTED PRIOR TO CONSTRUCTION START.
- 5. CONTRACTOR SHALL VERIFY ALL TREE REMOVALS AND/OR TRANSPLANTS WITH OWNER'S REPRESENTATIVE PRIOR TO CONSTRUCTION START.
- 6. CONTRACTOR SHALL MAINTAIN POSITIVE DRAINAGE AWAY FROM ALL BUILDING FOUNDATIONS, STRUCTURES, AND PLANTING BEDS.
- 7. MAXIMUM SLOPE WITHIN DISTURBED AREAS SHALL NOT EXCEED 3:1, UNLESS OTHERWISE NOTED.
- 8. THE LANDSCAPE CONTRACTOR SHALL SUPPLY ALL PLANT MATERIALS IN QUANTITIES SUFFICIENT TO COMPLETE ALL PLANTINGS SHOWN ON THIS DRAWING.
- 9. ALL MATERIALS SHALL CONFORM TO THE GUIDELINES ESTABLISHED BY THE AMERICAN NURSERY AND LANDSCAPE ASSOCIATION.
- 10. ALL PLANTS SHALL BEAR THE SAME RELATIONSHIP TO FINISH GRADE AS TO ORIGINAL GRADES BEFORE DIGGING.
- 11. ALL PLANTS TO BE BALLED IN BURLAP OR CONTAINERIZED.
- 12. MULCH FOR PLANTED AREAS TO BE AGED PINE BARK: PARTIALLY DECOMPOSED, DARK BROWN IN COLOR AND FREE OF WOOD CHIPS THICKER THAN 1/4 INCH.
- 13. PLANTING SOIL MIX: LOAM THOROUGHLY INCORPORATED WITH ROTTED MANURE PROPORTIONED 5 C.Y. TO 1 C.Y. OR EQUIVALENT. FERTILIZER ADDED PER RECOMMENDED RATES OF SOILS ANALYSIS.
- 14. THE LANDSCAPE CONTRACTOR SHALL GUARANTEE ALL PLANT MATERIALS FOR ONE (1) FULL YEAR FROM DATE OF ACCEPTANCE.
- 15. ALL PLANT MATERIALS ARE SUBJECT TO THE APPROVAL OF THE LANDSCAPE ARCHITECT, AT THE NURSERY, AND AT THE SITE.
- 16. ALL AREAS OF THE SITE WHICH HAVE BEEN DISTURBED AND NOT OTHERWISE DEVELOPED SHALL BE LOAMED AND SEEDED WITH A MINIMUM DEPTH OF 6" DEPTH TOPSOIL.
- 17. PLANT SPECIES AS INDICATED IN THE PLANT LIST ARE SUGGESTIONS ONLY. FINAL SELECTION OF SPECIES SHALL OCCUR AT THE TIME OF PLANT PURCHASE, DEPENDING ON AVAILABILITY. PLANT SIZE AND QUANTITY SHALL NOT CHANGE WITHOUT APPROVAL OF OWNER'S REPRESENTATIVE.

# PLANT SCHEDULE

SYMBOL	BOTANICAL NAME	COMMON NAME	QTY	SIZE	COMMENT	
DECIDUOUS	DECIDUOUS TREES					
GT	GLEDITSIA TRIACANTHOS 'INERMIS'	THORNLESS HONEYLOCUST	7	3 −3 1/2" CAL.		
HQ	HYDRANGEA QUERICIFOLIA 'ALICE'	ALICE OAK LEAF HYDRANGEA	8	24/36" HT.		
CP	CAREX PENNSYLVANICA	COMMON SEDGE	1500	4" POTS		


WITHERBEE STREET PARKING LOT

MARLBOROUGH, MA


DZI	Land Planning, Civil Engineering, Landscape Architecture Po Box 307 Foxborough, MA www.develliszrein.com tel. 508.393.8583
DeVellis Z	Zrein Inc.

PLANTING PLAN

SCALE:	1"-20"	
JOB:	2GIS-535	
FILE:		
DRAWN:	JJD / CM	
CHECKED	: TOG	
DATE:	08-21-23	

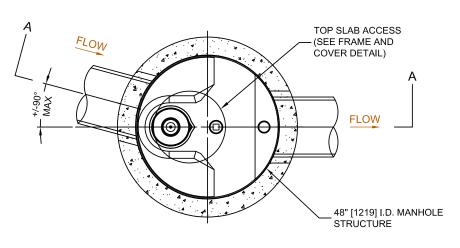

PLAN VIEW
TOP SLAB NOT SHOWN

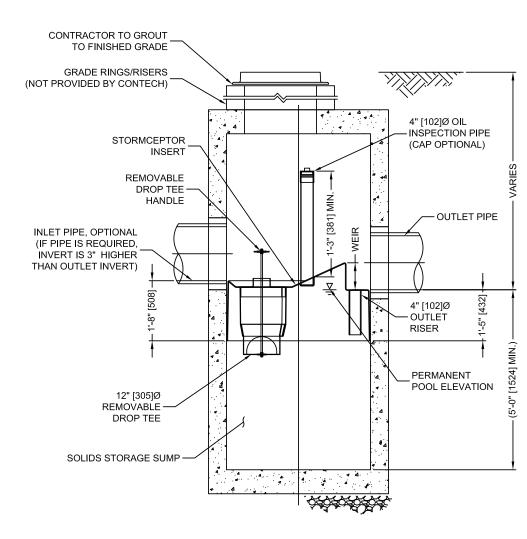

- . CONTECH TO PROVIDE ALL MATERIALS UNLESS NOTED OTHERWISE
- 2. FOR SITE SPECIFIC DRAWINGS WITH DETAILED STRUCTURE DIMENSIONS AND WEIGHT, PLEASE CONTACT YOUR CONTECH ENGINEERED SOLUTIONS LLC REPRESENTATIVE. www.ContechES.com 3. STORMCEPTOR WATER QUALITY STRUCTURE SHALL BE IN ACCORDANCE WITH ALL DESIGN DATA AND
- INFORMATION CONTAINED IN THIS DRAWING. CONTRACTOR TO CONFIRM STRUCTURE MEETS REQUIREMENTS OF PROJECT. 4. STORMCEPTOR STRUCTURE SHALL MEET AASHTO HS20 LOAD RATING, ASSUMING EARTH COVER OF 0' - 2' [610], AND GROUNDWATER ELEVATION AT, OR BELOW, THE OUTLET PIPE INVERT ELEVATION. ENGINEER OF
- RECORD TO CONFIRM ACTUAL GROUNDWATER ELEVATION. CASTINGS SHALL MEET AASHTO M306 AND BE CAST WITH THE CONTECH LOGO. 5. STORMCEPTOR STRUCTURE SHALL BE PRECAST CONCRETE CONFORMING TO ASTM C478 AND AASHTO LOAD
- FACTOR DESIGN METHOD. 6. ALTERNATE UNITS ARE SHOWN IN MILLIMETERS [mm].


- INSTALLATION NOTES

  A. ANY SUB-BASE, BACKFILL DEPTH, AND/OR ANTI-FLOTATION PROVISIONS ARE SITE-SPECIFIC DESIGN CONSIDERATIONS AND SHALL BE SPECIFIED BY ENGINEER OF RECORD.
- B. CONTRACTOR TO PROVIDE EQUIPMENT WITH SUFFICIENT LIFTING AND REACH CAPACITY TO LIFT AND SET THE STORMCEPTOR MANHOLE STRUCTURE.
- C. CONTRACTOR TO INSTALL JOINT SEALANT BETWEEN ALL STRUCTURE SECTIONS AND ASSEMBLE STRUCTURE. D. CONTRACTOR TO PROVIDE, INSTALL, AND GROUT INLET AND OUTLET PIPE(S). MATCH PIPE INVERTS WITH
- ELEVATIONS SHOWN. ALL PIPE CENTERLINES TO MATCH PIPE OPENING CENTERLINES. E. CONTRACTOR TO TAKE APPROPRIATE MEASURES TO ASSURE UNIT IS WATER TIGHT, HOLDING WATER TO
- FLOWLINE INVERT MINIMUM. IT IS SUGGESTED THAT ALL JOINTS BELOW PIPE INVERTS ARE GROUTED.


#### NOTE: CONTRACTOR MAY USE PLASTIC TREE GUYING CHAIN IF APPROVED BY L.A. WOOD STAKE (SEE BELOW) NYLON TREE SLING DOUBLE STRAND 12 GA. WIRE TWISTED TREE PIT (3 X ROOT BALL ROOTBALL -NOTE: TREE SHALL BEAR SAME PROVIDE 2"x3" UNTREATED PINE STAKES 3 PER TREE. DRILL TO ACCEPT GUY WIRE. PRIME AND PAINT BLACK. 3" BARK MULCH IN SAUCER KEEP 2" CLEAR OF TRUNK, EXTENT OF TREE PIT - PLANT SAUCER, 4" CONTINUOUS HEIGHT - SEED OR SOD AS NOTED ON PLANS FINISH GRADE CUT AND REMOVE BURLAP FROM TOP 1/3 OF ROOTBALL CUT AND REMOVE WIRE BASKETS ENTIRELY - PLANTING SOIL MIX: BACKFILL IN LOOSE LIFTS OF 6"-8" DEPTH. SETTLE WITH THOROUGH WATERING PLACE BALL ON SUBGRADE THE ROOTBALL DIAMETER

# WATER QUALITY UNIT (STORMCEPTOR 450I) (OR EQUAL)


REFER TO MANUFATURERS GENERAL NOTES AND INSTALL GUIDE

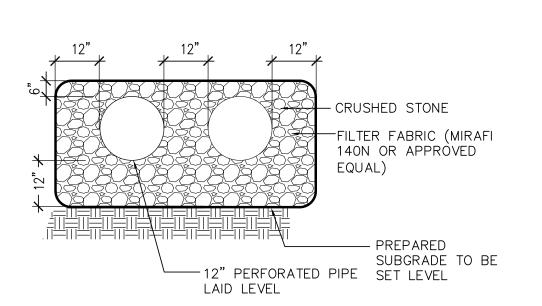


# UNDERGROUND RECHARGE SYSTEM

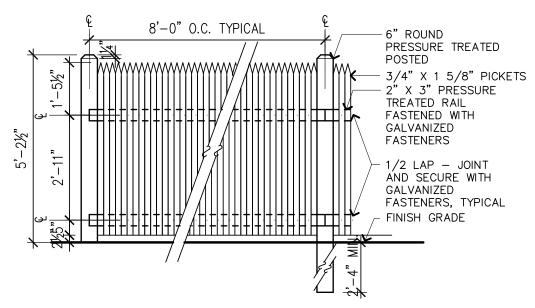

# 6' HT. STOCKADE FENCE

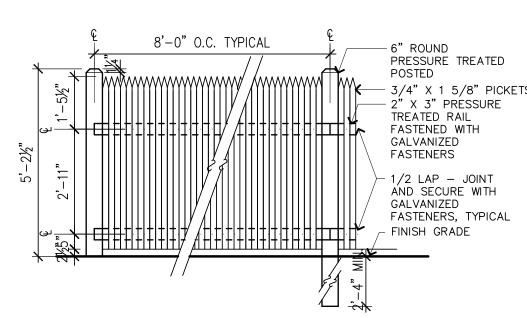

# LIGHT POLE BASE

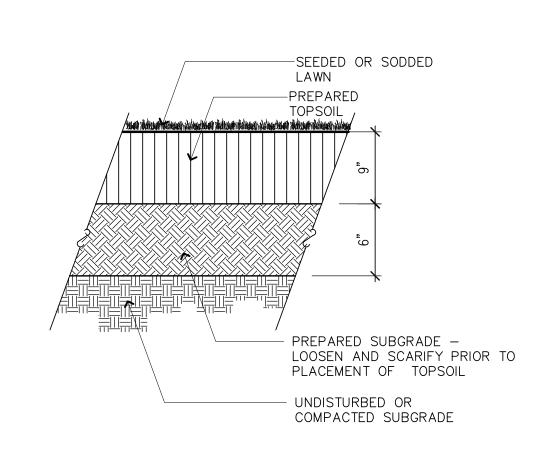



WITHERBEE

STREET

PARKING LOT

MARLBOROUGH, MA

# SITE DETAILS

SCALE:	1"-20"	
JOB:	2GIS-535	
FILE:		
DRAWN:	JJD / CM	
CHECKED	: TOG	
DATE:	08-21-23	

1. SHRUB SHALL BEAR SAME RELATIONSHIP TO FINISHED GRADE AS IT BORE TO NURSERY OR FIELD GRADE

THE CUT AND REMOVE ALL BURLAP FROM

PLANTING SOIL MIX: BACKFILL IN LOOSE LIFTS OF 6"-8" DEPTH. SETTLE WITH

PLACE ROOT BALL ON UNDISTURBED SOIL. IF SOIL HAS BEEN DISTURBED, COMPACT

OCCUR IN BEDS

THOROUGH WATERING

TO MINIMIZE SETTLING.


ROOT BALL

3" BARK MULCH IN SAUCER, NOT TO BE PILED AGAINST ROOT FLARE OR TRUNK
PLANT SAUCER, 4" CONTINUOUS, NO SAUCER WHERE SHRUBS

SHRUB PLANTING

RELATIONSHIP TO FINISHED GRADE AS IT BORE TO NURSERY OR FIELD GRADE, TRUNK FLARE SHALL BE VISIBLE ABOVE

# DECIDUOUS TREE PLANTING

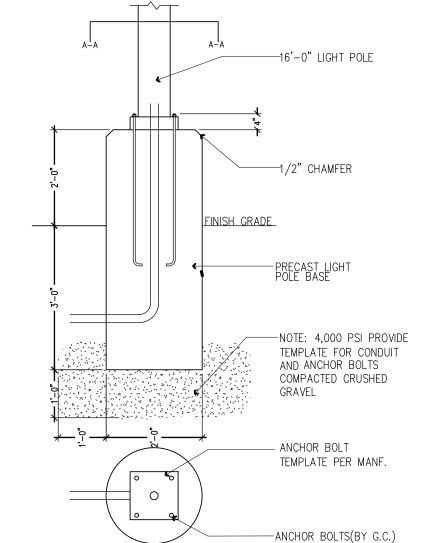

LOAM AND SEED PLANTING